DOWNTOWN PARKING GARAGE

PALO ALTO, CA



FORMAL ARB SUBMITTAL

07/12/18

SHEET INDEX

ARB 1.1 COVER SHEET

ARB 1.2 CONTEXT IMAGES

ARB 1.3 EXISTING CIVIL SITE PLAN

ARB 1.4 CIVIL SITE PLAN

ARB 1.5 SITE ZONING PLAN

ARB 1.6 SITE PLAN

ARB 2.1 GROUND LEVEL PLAN

ARB 2.2 BASEMENT AND LEVEL 02 PLANS

ARB 2.3 LEVEL 03 AND LEVEL 04 PLANS

ARB 2.4 LEVEL 05 AND PV PLANS

ARB 3.1 HAMILTON ELEVATION

ARB 3.2 WAVERLEY ELEVATION

ARB 3.3 ALLEY ELEVATION

ARB 3.4 BUILDING SECTIONS

ARB 3.5 WALL SECTION

ARB 3.6 WALL SECTION

ARB 3.7 DESIGN RENDERINGS

ARB 3.8 DESIGN RENDERINGS

ARB 3.9 DESIGN RENDERINGS

ARB 3.10 SOLAR STUDY 3/21 (without PV)

ARN 3.11 SOLAR STUDY 6/21 (without PV)

ARB 3.12 SOLAR STUDY 9/21 (without PV)

ARB 3.13 SOLAR STUDY 12/21 (without PV)

ARB 3.14 SOLAR STUDY 3/21 (with PV)

ARB 3.15 SOLAR STUDY 6/21 (with PV)

ARB 3.16 SOLAR STUDY 9/21 (with PV)

ARB 3.17 SOLAR STUDY 12/21 (with PV)

ARB 4.1 LANDSCAPE SCHEMATIC PLAN
ARB 4.2 MATERIALS AND PLANT SELECTIONS

ARB 4.3 TREE PROTECTION PLAN

ARB 4.4 T1 SPECIAL TREE PROTECTION INSTRUCTION SHEET

ARB 5.1 SITE LIGHTING PLAN

ARB 5.2 SITE PHOTOMETRIC PLAN

ARB 5.3 ROOFTOP PHOTOMETRIC PLAN & SPILL LIGHT


ARB 5.4 LUMINAIRE CUT SHEETS

ARB 6.1 PARKING GUIDANCE

MB MATERIAL AND SAMPLE BOARD






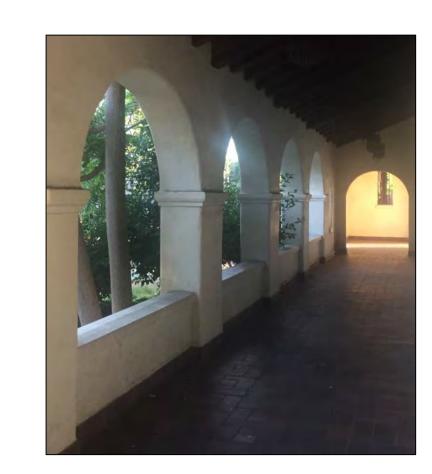



HAMILTON SOUTHEAST STREETSCAPE 2



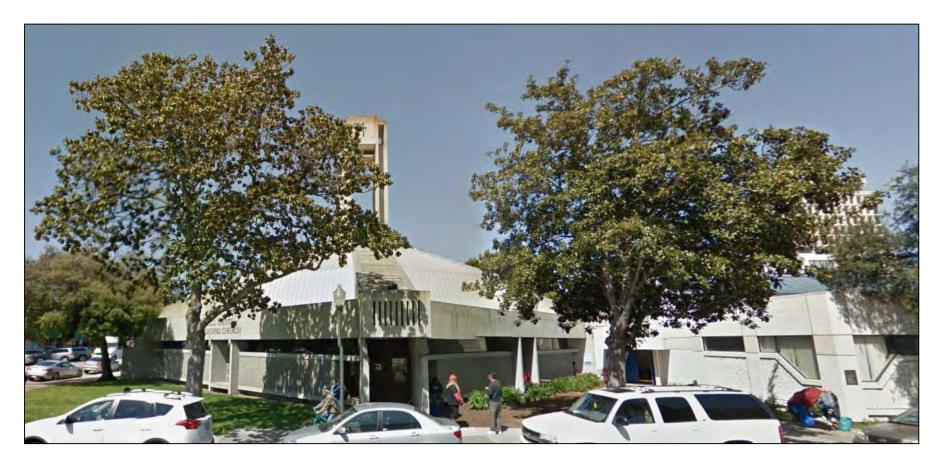

HAMILTON NORTHWEST STREETSCAPE 3








WAVERLEY SOUTHWEST STREETSCAPE 2



AERIAL VIEW OF SITE 1

DOWNTOWN PARKING GARAGE

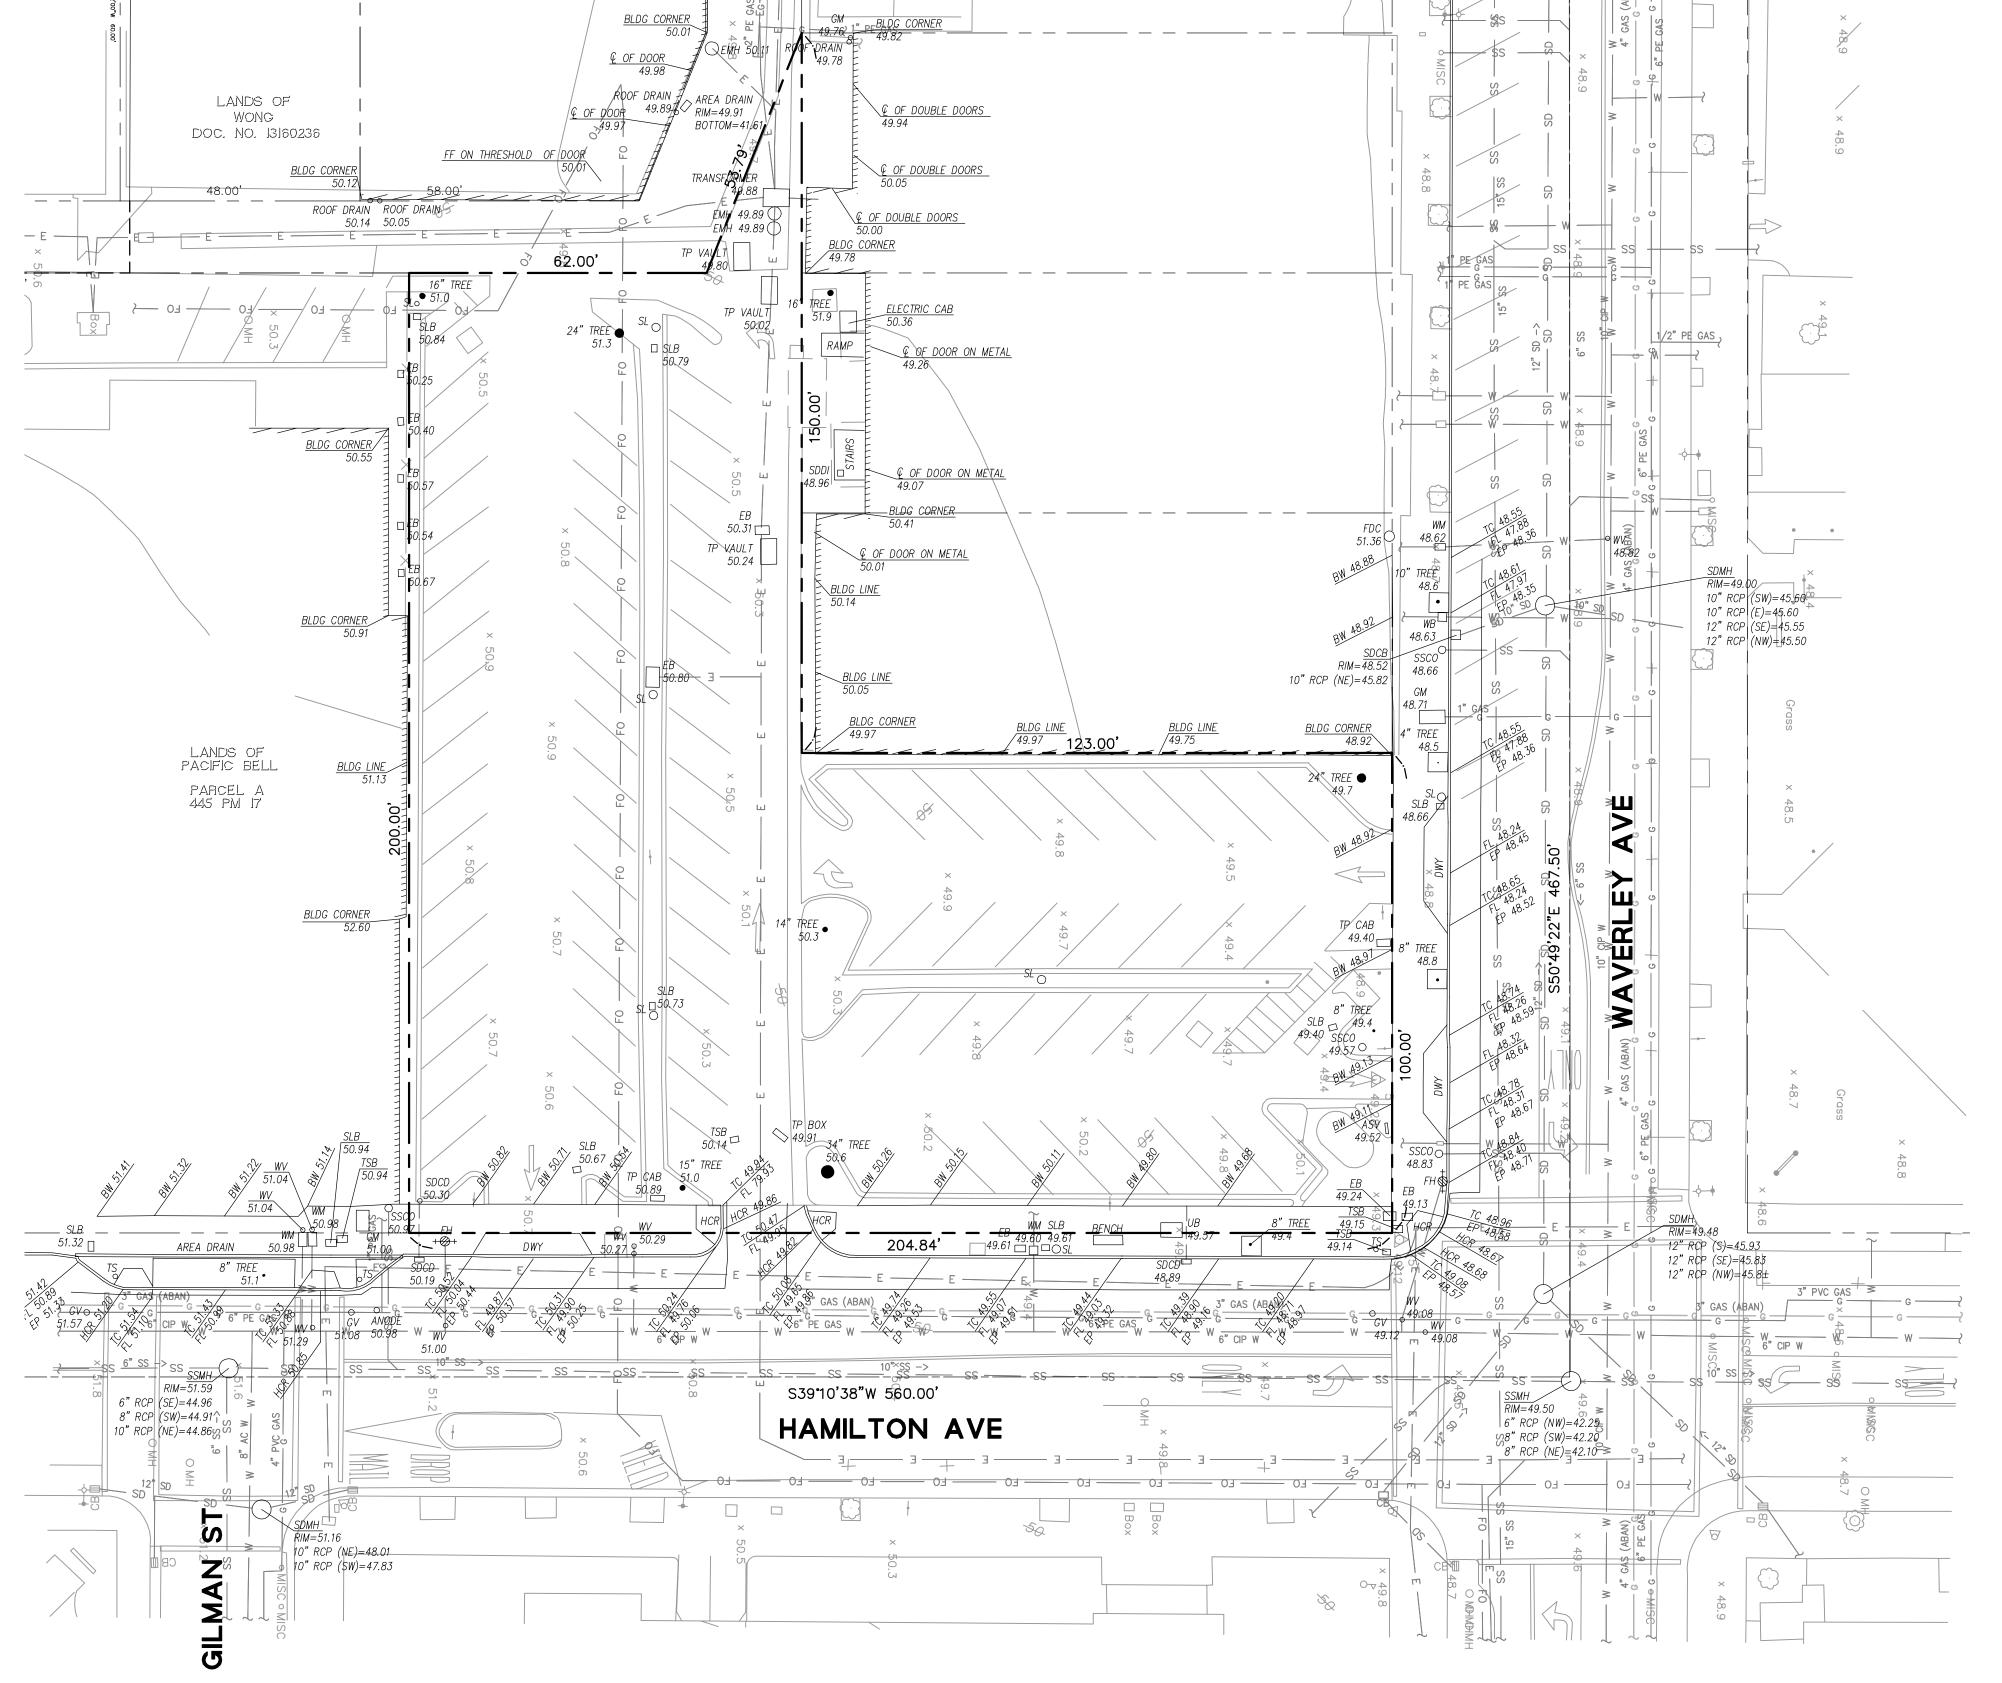

LEGEND

PROPERTY LINE	
ADJACENT LOT LINE	
GAS MAIN	G
ABANDONED GAS LINE	g <u>ABN</u>
WATER MAIN	W
ELECTRICAL LINE	—— Е ——
SANITARY SEWER LINE	SS
STORM DRAIN LINE	SD
FIBER OPTIC LINE	FO
STORM DRAIN CATCH DRAIN	SDCB□
STORM DRAIN MANHOLE	SDMH
SANITARY SEWER MANHOLE	SSMH
SANITARY SEWER CLEAN OUT	SSCO O
WATER VALVE	WV_{o}
WATER METER	WM 🗆
FIRE HYDRANT	FH + ⊘ +
GAS VALVE	GVO
TRAFFIC SIGNAL	TS o
ELECTRICAL BOX	EB 🖂
STREET LIGHT	SL O


BENCHMARK

BM#219


ELEVATION = 51.27 FEET (NGVD 29)
CHISELED SQUARE SET ON TOP OF CURB, LOCATED ON NORTHWEST CORNER AT NORTHEAST RETURN BRYANT STREET & UNIVERSITY AVENUE, CITY OF PALO ALTO SECONDARY VERTICAL CONTROL DATUM (RE-ADJUSTMENT OF 1967)

BASIS OF BEARINGS

THE BEARINGS SHOWN ON THIS SURVEY ARE BASED ON THE CALIFORNIA COORDINATE SYSTEM OF 1983 (CCS83), ZONE 3, EPOCH 2010.00 AND THIS BEING ALSO THE NORTH AMERICAN DATUM OF 1983 (NAD83). DISTANCES SHOWN ON THIS MAP ARE GROUND DISTANCES.

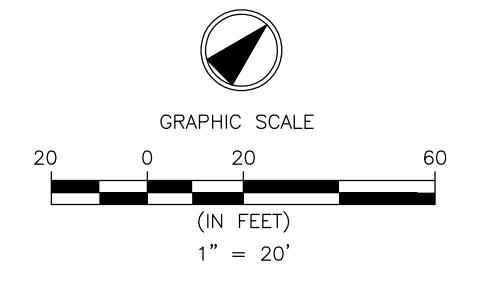



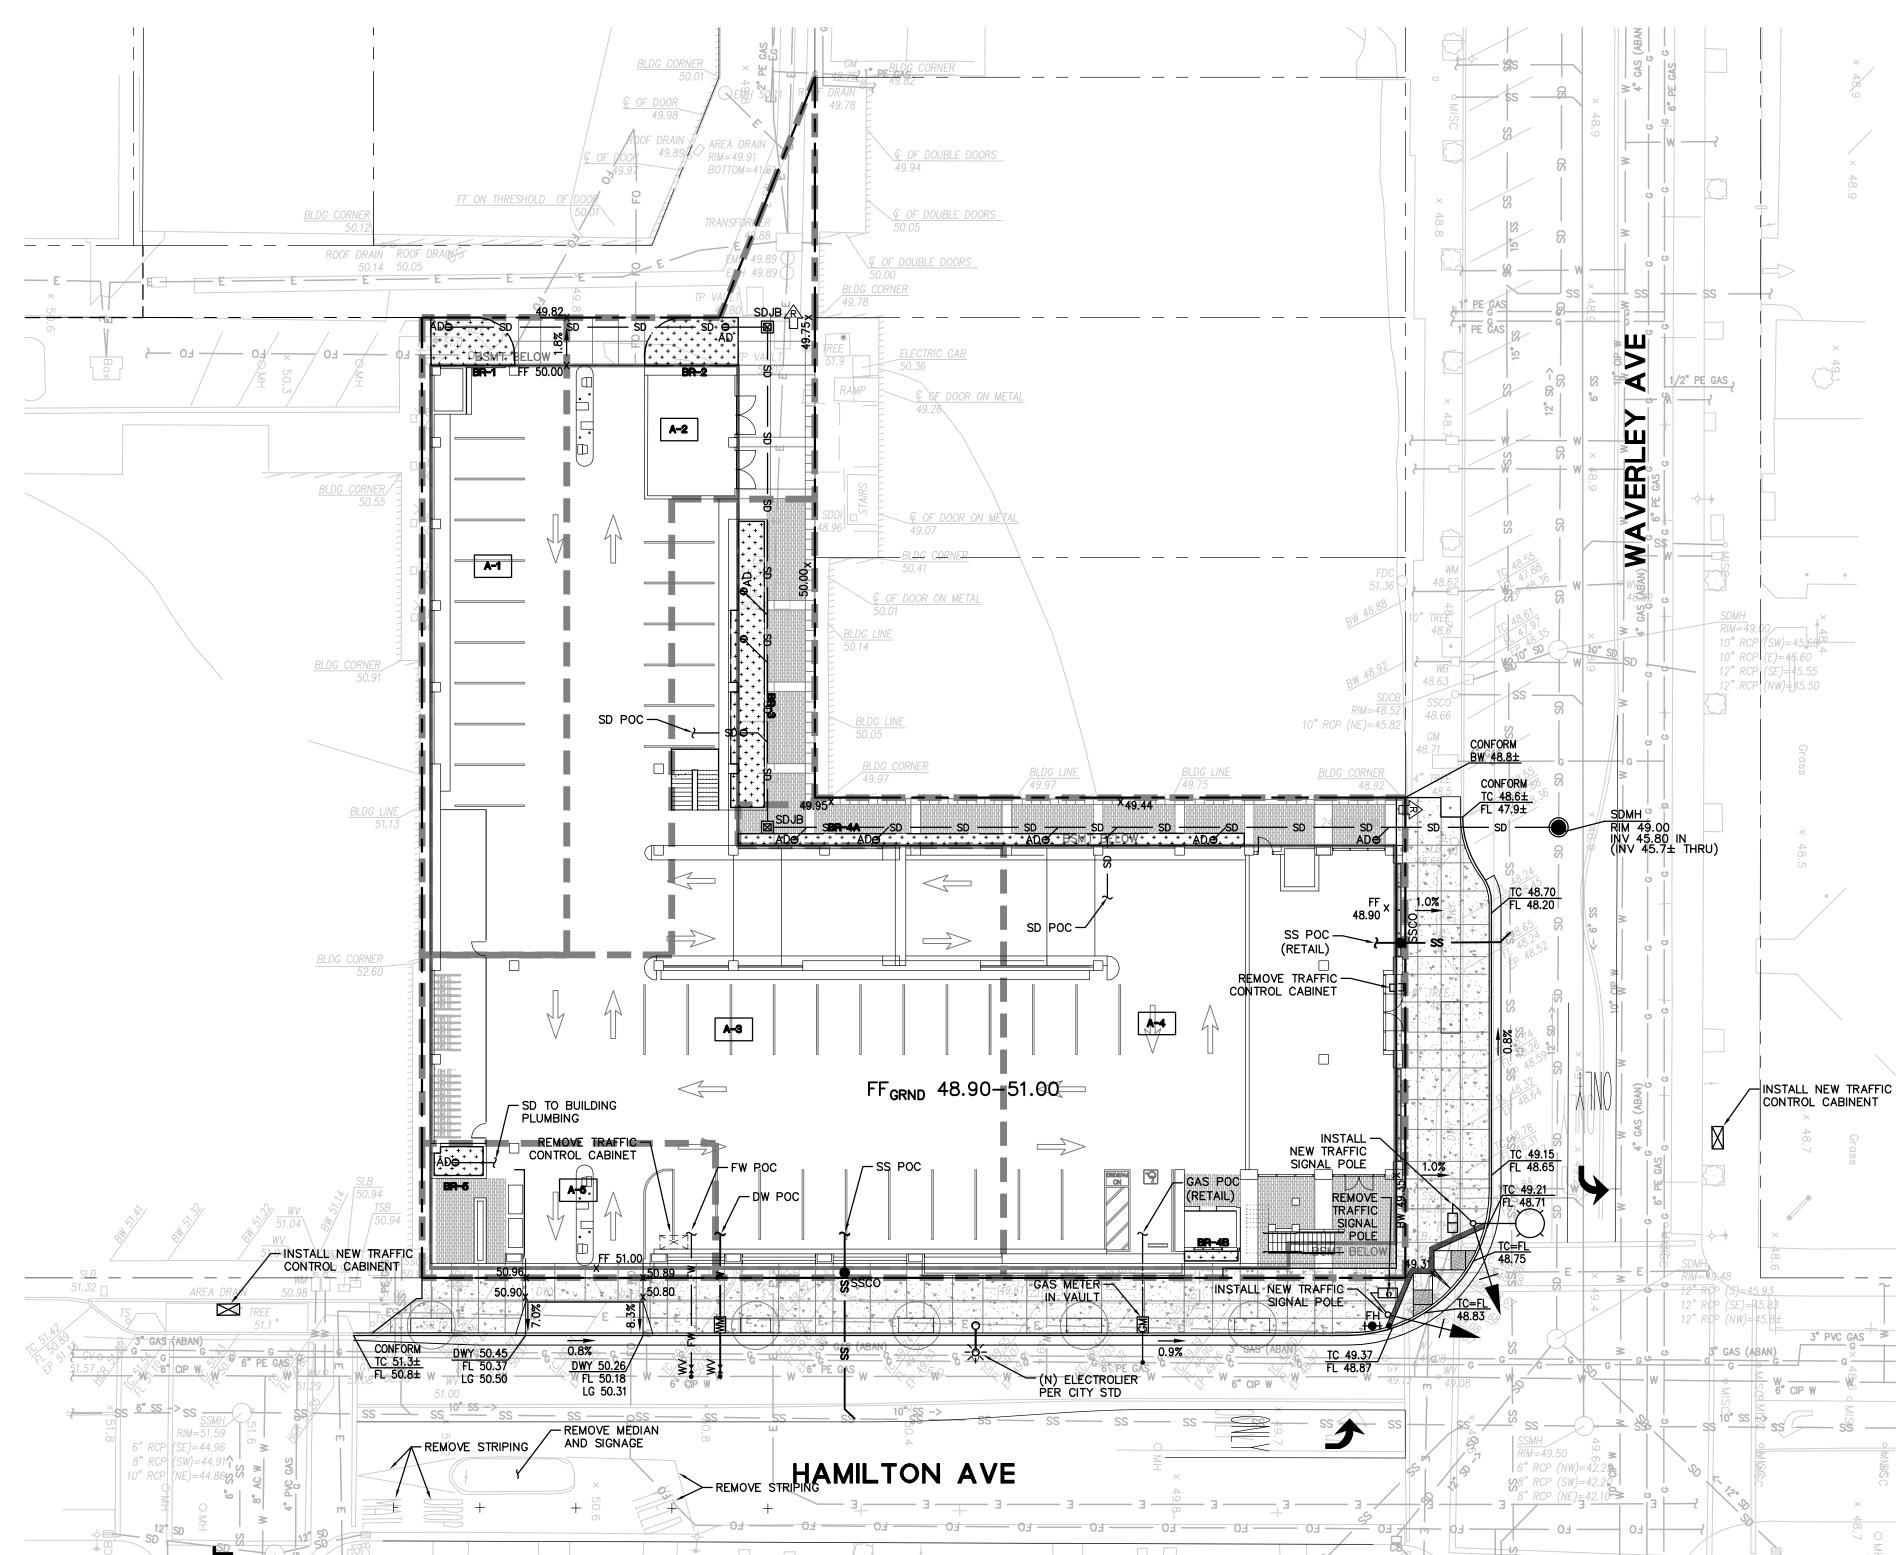

NOTES

1. ALL PAVED AREAS ARE TO SLOPE A MINIMUM OF 0.5% AND MAXIMUM OF 8%. ACCESSIBLE STALLS AND LOADING ZONES ARE TO SLOPE AT A MAXIMUM OF 2% IN ALL DIRECTIONS. ACCESSIBLE PATHWAYS ARE TO SLOPE AT A MAXIMUM OF 5% IN THE DIRECTION OF TRAVEL AND THE SLOPE CROSSWAYS TO THE DIRECTION OF TRAVEL SHALL BE AT A MAXIMUM OF 2%. ANY AREAS ON THE SITE NOT CONFORMING TO THESE BASIC RULES DUE TO EXISTING CONDITIONS OR DISCREPANCIES IN THE DOCUMENTS ARE TO BE REPORTED TO THE ENGINEER/ARCHITECT PRIOR TO PROCEEDING WITH PLACEMENT OF BASE ROCK, FORM WORK AND/OR FLATWORK.

2. CONTRACTOR SHALL DETERMINE EARTHWORK QUANTITIES BASED ON THE TOPOGRAPHIC SURVEY/EXISTING CONDITIONS, THE GEOTECHNICAL INVESTIGATION AND THE PROPOSED SURFACE THICKNESS AND BASE THE BID ACCORDINGLY. IT IS THE CONTRACTOR'S RESPONSIBILITY TO CONFIRM IF A SEPARATE DEMOLITION CONTRACT HAS BEEN ISSUED TO TAKE THE SITE FROM THE WAY IT IS AT THE TIME OF THE BID TO THE CONDITIONS DESCRIBED IN THESE DOCUMENTS. ANY DIFFERENCES BETWEEN THE STATE IN WHICH THE SITE IS DELIVERED TO THE CONTRACT AND THESE DOCUMENTS SHOULD BE NOTED TO THE

3. ALL FILL SHALL BE COMPACTED PER THE GEOTECHNICAL REPORT AND THE CONTRACTOR SHALL COORDINATE AND COMPLY WITH THE CLIENT'S TESTING AGENCY TO TAKE THE APPROPRIATE TESTS TO VERIFY COMPACTION VALUES.

4. IMPORT SOILS SHOULD MEET THE REQUIREMENTS OF THE GEOTECHNICAL REPORT AND SPECIFICATIONS.

5. COORDINATE THE PLACEMENT OF ALL SLEEVES FOR LANDSCAPE IRRIGATION (WATER AND CONTROL WIRING) AND SITE LIGHTING PRIOR TO PLACEMENT OF ANY ASPHALT, BASE ROCK OR FLATWORK. SEE SITE LANDSCAPING AND ELECTRICAL DRAWINGS.

6. DO NOT ADJUST GRADES ON THIS PLAN WITHOUT PRIOR WRITTEN APPROVAL OF THE ENGINEER/ARCHITECT.

7. SITE STRIPPINGS THAT CONTAIN ONLY ORGANIC MATERIAL (NO DEBRIS TRASH, BROKEN CONCRETE OR ROCKS GREATER THAN 1" IN DIAMETER) MAY BE USED IN LANDSCAPE AREAS, EXCEPT FOR AREAS IDENTIFIED AS IMPORT TOP SOIL BY THE LANDSCAPE DRAWINGS. EXCESS STRIPPINGS SHALL BE REMOVED FROM THE SITE.

8. ROUGH GRADING TO BE WITHIN 0.1' AND FINISH GRADES ARE TO BE WITHIN 0.05'. HOWEVER, CONTRACTOR SHALL NOT CONSTRUCT ANY IMPROVEMENTS THAT WILL CAUSE WATER TO POND OR NOT MEET REQUIREMENTS IN GRADING NOTE #1.

9. CONTRACTOR SHALL EXERCISE EXTREME CARE TO CONFORM TO THE LINES, GRADES, SECTIONS AND DIMENSIONS AS SET FORTH ON THESE PLANS. ALL GRADED AREAS SHALL CONFORM TO THE VERTICAL ELEVATIONS SHOWN WITH A TOLERANCE OF ONE-TENTH OF A FOOT. WHERE GRADED AREAS DO NOT CONFORM TO THESE TOLERANCES, THE CONTRACTOR SHALL BE REQUIRED TO PERFORM CORRECTIVE GRADING AT NO EXTRA COST TO THE OWNER.

10. IT SHALL BE THE CONTRACTOR'S RESPONSIBILITY TO CONFIRM THE GROUND ELEVATIONS AND OVERALL TOPOGRAPHY PRIOR TO THE START OF CONSTRUCTION AS TO THE ACCURACY BETWEEN THE WORK SET FORTH ON THESE PLANS AND THE WORK IN THE FIELD. ANY DISCREPANCIES SHALL BE IMMEDIATELY BROUGHT TO THE ATTENTION OF THE ENGINEER/ARCHITECT IN WRITING PRIOR TO THE START OF CONSTRUCTION WHICH MAY REQUIRE CHANGES IN DESIGN AND/OR AFFECT THE EARTHWORK QUANTITIES.

11. TRENCHES SHALL NOT BE LEFT OPEN OVERNIGHT IN EXISTING PUBLIC STREET AREAS. CONTRACTOR SHALL BACKFILL TRENCHES OR PLACE STEEL PLATING WITH ADEQUATE CUTBACK TO PREVENT SHIFTING OF STEEL PLATE AND/OR HOT-MIX ASPHALT REQUIRED TO PROTECT OPEN TRENCHES AT THE END OF THE WORKING DAY.

12. SEE SITE ARCHITECTURAL/LANDSCAPE PLANS FOR ALL WALKWAY COLORS, FINISHES, SCORE JOINT DETAILING AND LAYOUT.

13. SEE STRUCTURAL DRAWINGS FOR BUILDING SLAB SECTIONS AND PAD PREP. 14. EXISTING PAVEMENT SHALL BE TACK COATED PRIOR TO CONSTRUCTION OF NEW PAVEMENT.

15. THE FINAL OR SURFACE LAYER OF ASPHALT CONCRETE SHALL NOT BE PLACED UNTIL ALL ON-SITE IMPROVEMENTS HAVE BEEN COMPLETED, INCLUDING ALL GRADING AND ALL UNACCEPTABLE CONCRETE WORK HAS BEEN REMOVED AND REPLACED, UNLESS OTHERWISE APPROVED BY THE CITY ENGINEER AND/OR CLIENT'S CIVIL ENGINEER.

16. EXISTING ASPHALT CONCRETE IN PARKING LOT TO BE REMOVED IN ACCORDANCE WITH THE DEMOLITION PLAN. SCRAPE OFF BASE ROCK AND STOCKPILE FOR RE-USE IN NEW PAVEMENT SECTION IF APPROVED BY GEOTECHNICAL ENGINEER.

17. ALL PAVING SHALL BE IN CONFORMANCE WITH SECTION 26, "AGGREGATE BASE" AND SECTION 39, "ASPHALT CONCRETE" PER LATEST EDITION OF CALTRANS STANDARD

LEGEND

PROPERTY LINE ADJACENT LOT LINE DOMESTIC WATER LINE FIRE WATER LINE SANITARY SEWER LINE STORM DRAIN LINE (TC32.00±) **EXISTING ELEVATION** *___TC32.00 PROPOSED ELEVATION 1.8% SLOPE TO DRAIN (SURFACE SLOPE) SLOPE TO DRAIN (SOFTSCAPE) OVERLAND RELEASE PATH BIORETENTION BASIN DRAINAGE TRIBUTARY AREAS


EARTHWORK QUANTITIES

CUT 13,300 CY BALANCE 13,300 CY EXPORT

THE EARTHWORK QUANTITIES SHOWN ARE APPROXIMATE AND ARE FURNISHED FOR INFORMATION ONLY. THE ACTUAL AMOUNT OF EARTH MOVED WILL VARY DEPENDING ON THE PROPERTIES OF THE SOILS ENCOUNTERED, THE CONTRACTOR'S METHOD OF OPERATION, ETC.

		TREATMENT CONTROL MEASURE SUMMARY TABLE											
	DRAINAGE AREAS		PERVIOUS SURFACE (SQ. FT.)	TYPE OF PERVIOUS SURFACE	IMPERVIOUS SURFACE (SQ. FT.)	TYPE OF IMPERVIOUS SURFACE	WATER QUANTIT' VOLUME G	((FLOW AND/OR ENERATED)	PROPOSED TREATMENT CONTROLS	CONFORMS TO SIZE STANDARD?			
L	, ii (L) (O	0122 (04: 1 1.)	(04: 11:)	TERMIOOG CORFROL	(54: 11.)	IMIT ER VIOUS GOTAL FROE	REQUIRED*	PROVIDED	THE PROPERTY CONTINUES	GIZE GIVINDVIND.			
-	A-1	4,009	161	LANDSCAPE	3,848	CONCRETE, ROOF, PAVERS	123 SF	161 SF	B.R.1 BIORETENTION BASIN	YES			
-	A-2	4,523	181	LANDSCAPE	4,342	CONCRETE, ROOF, PAVERS	139 SF	181 SF	<u>B.R.2</u> BIORETENTION BASIN	YES			
-	A-3	10,021	825	LANDSCAPE	9,196	CONCRETE, ROOF, PAVERS	307 SF	388 SF	<u>B.R.3</u> BIORETENTION BASIN	YES			
- [A-4	8,898	1,017	LANDSCAPE	7,881	CONCRETE, ROOF, PAVERS	273 SF	286 SF	B.R. 4A & 4B BIORETENTION BASIN	YES			
= [A-5	1,714	0	LANDSCAPE	1,714	CONCRETE, ROOF, PAVERS	53 SF	59 SF	<u>B.R.5</u> BIORETENTION BASIN	YES			

*WATER QUANTITY REQUIRED CALCULATED BY THE COMBINATION METHOD

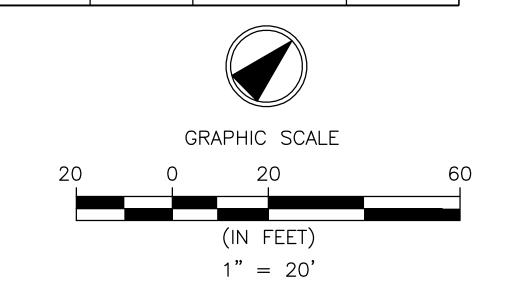





0" RCP (\$W)=47.83



CLIENT NAME:

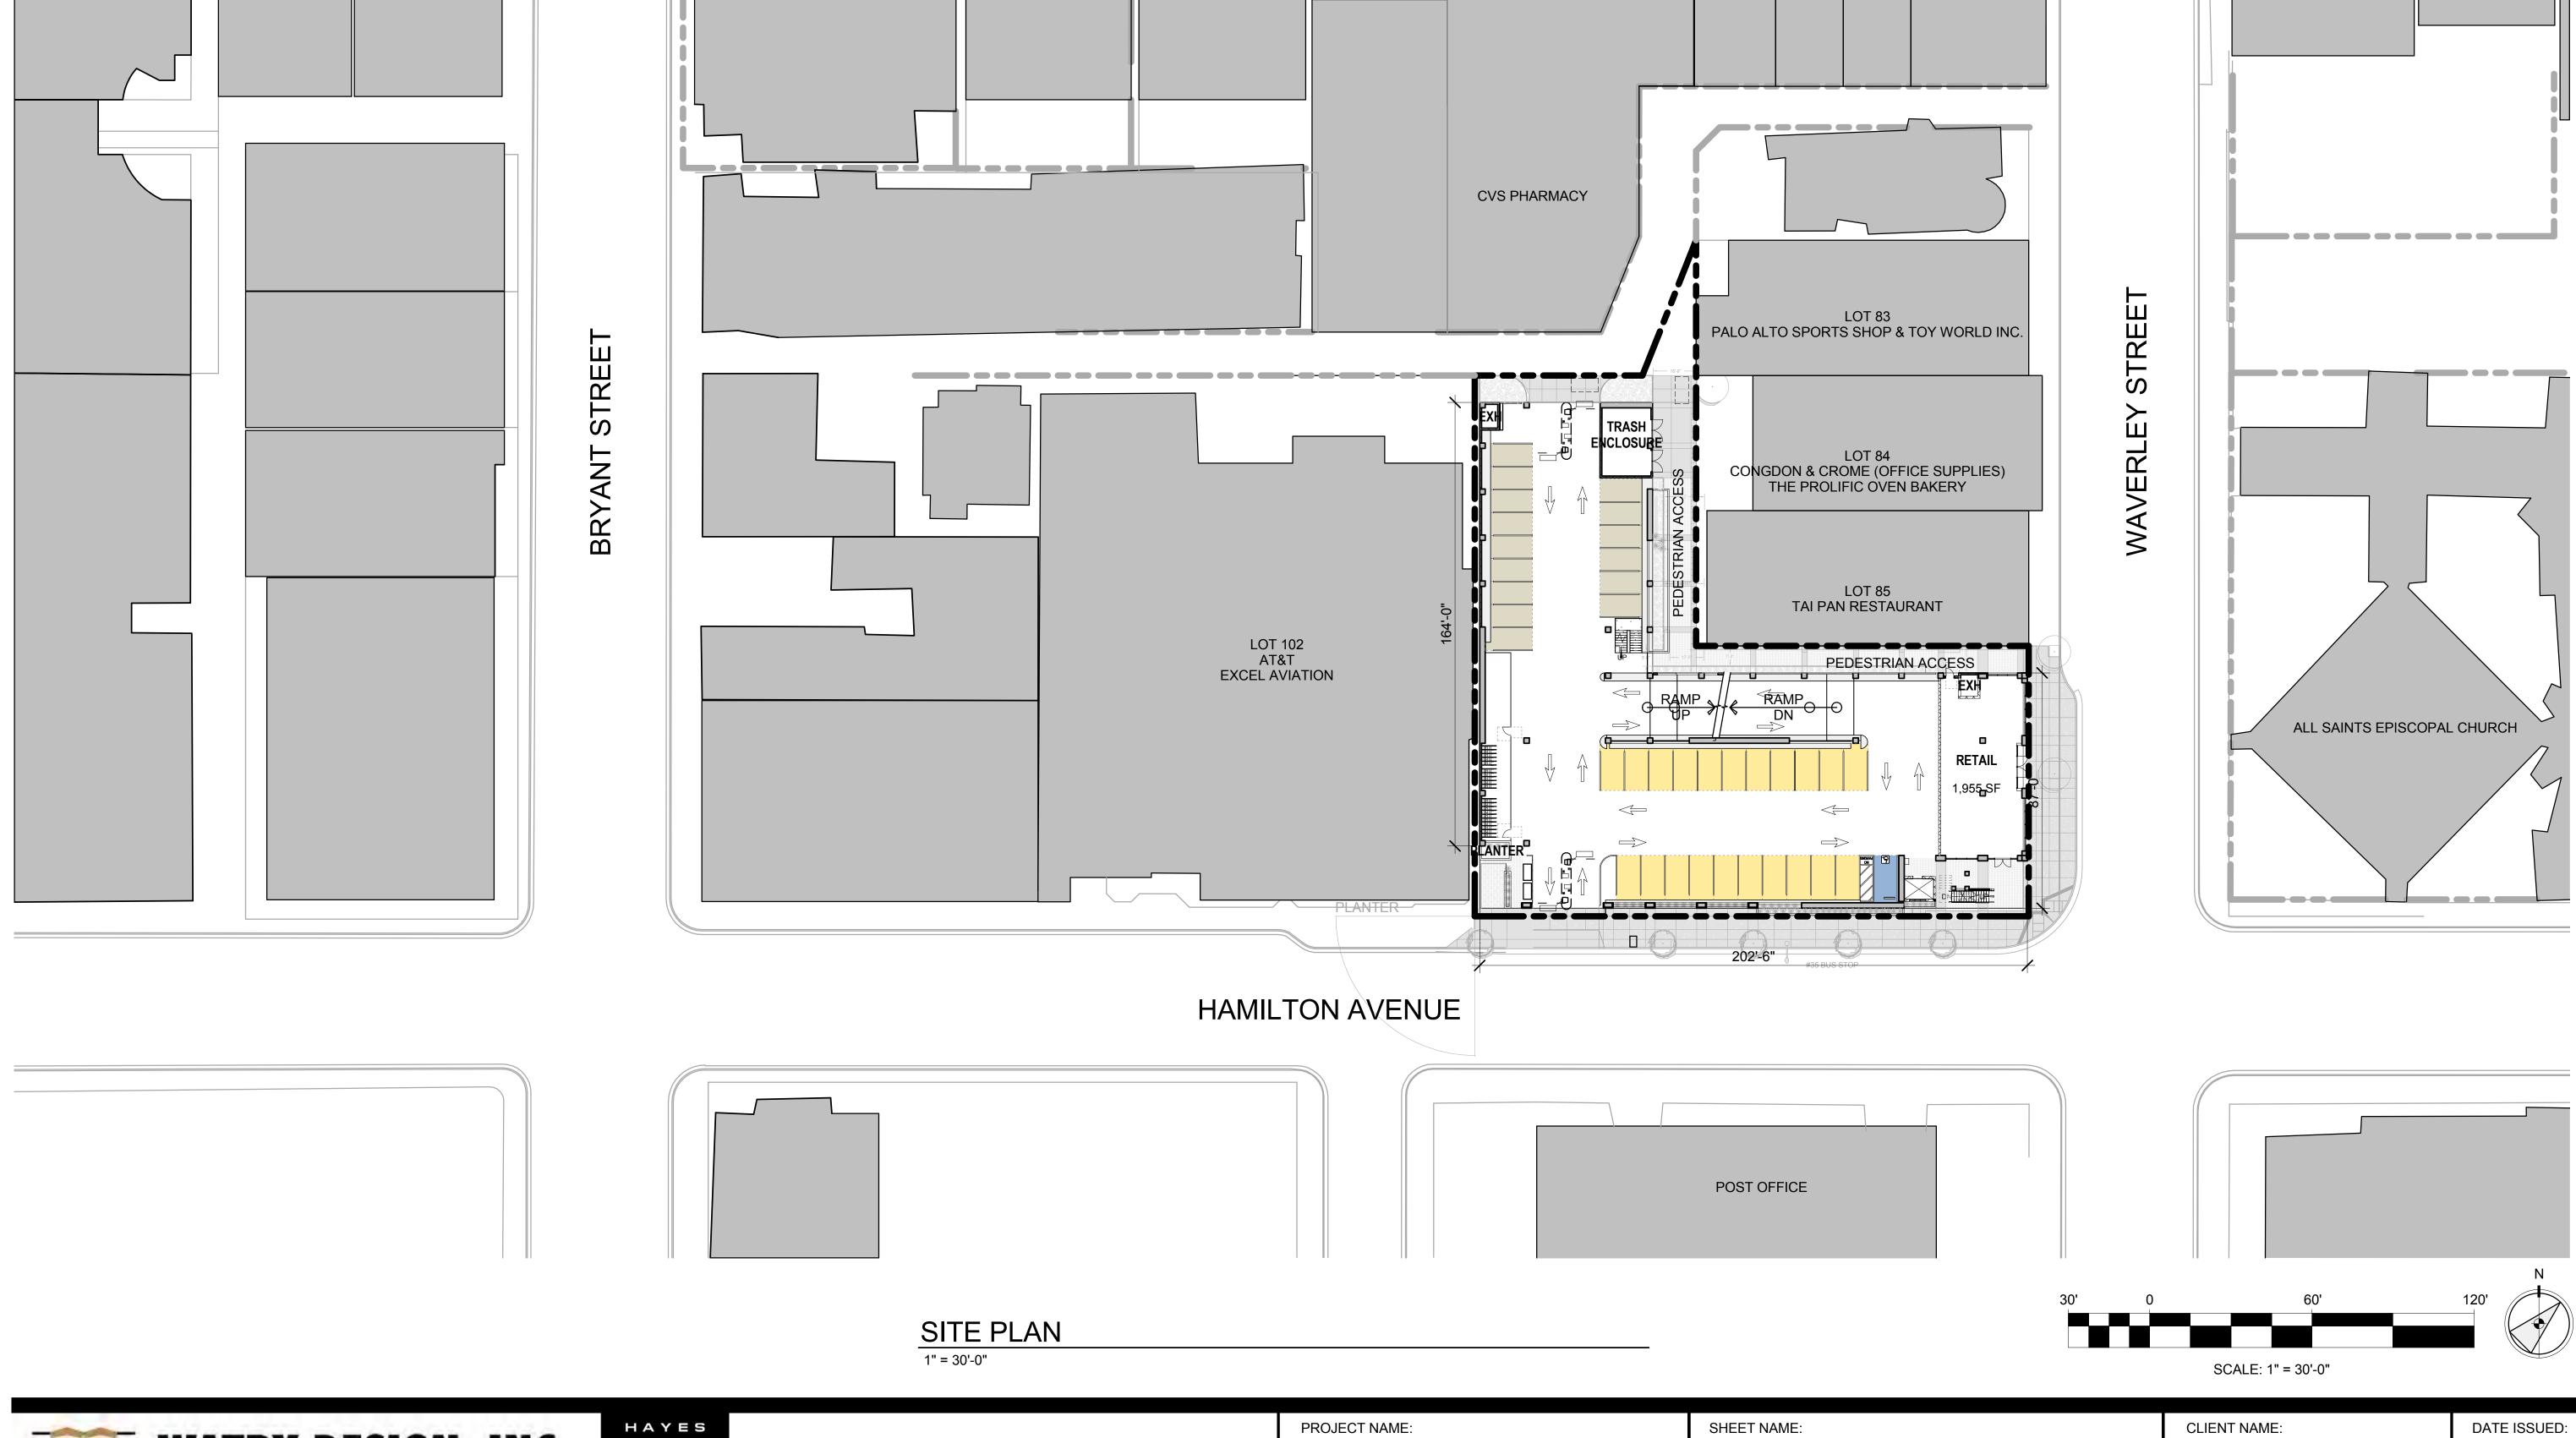



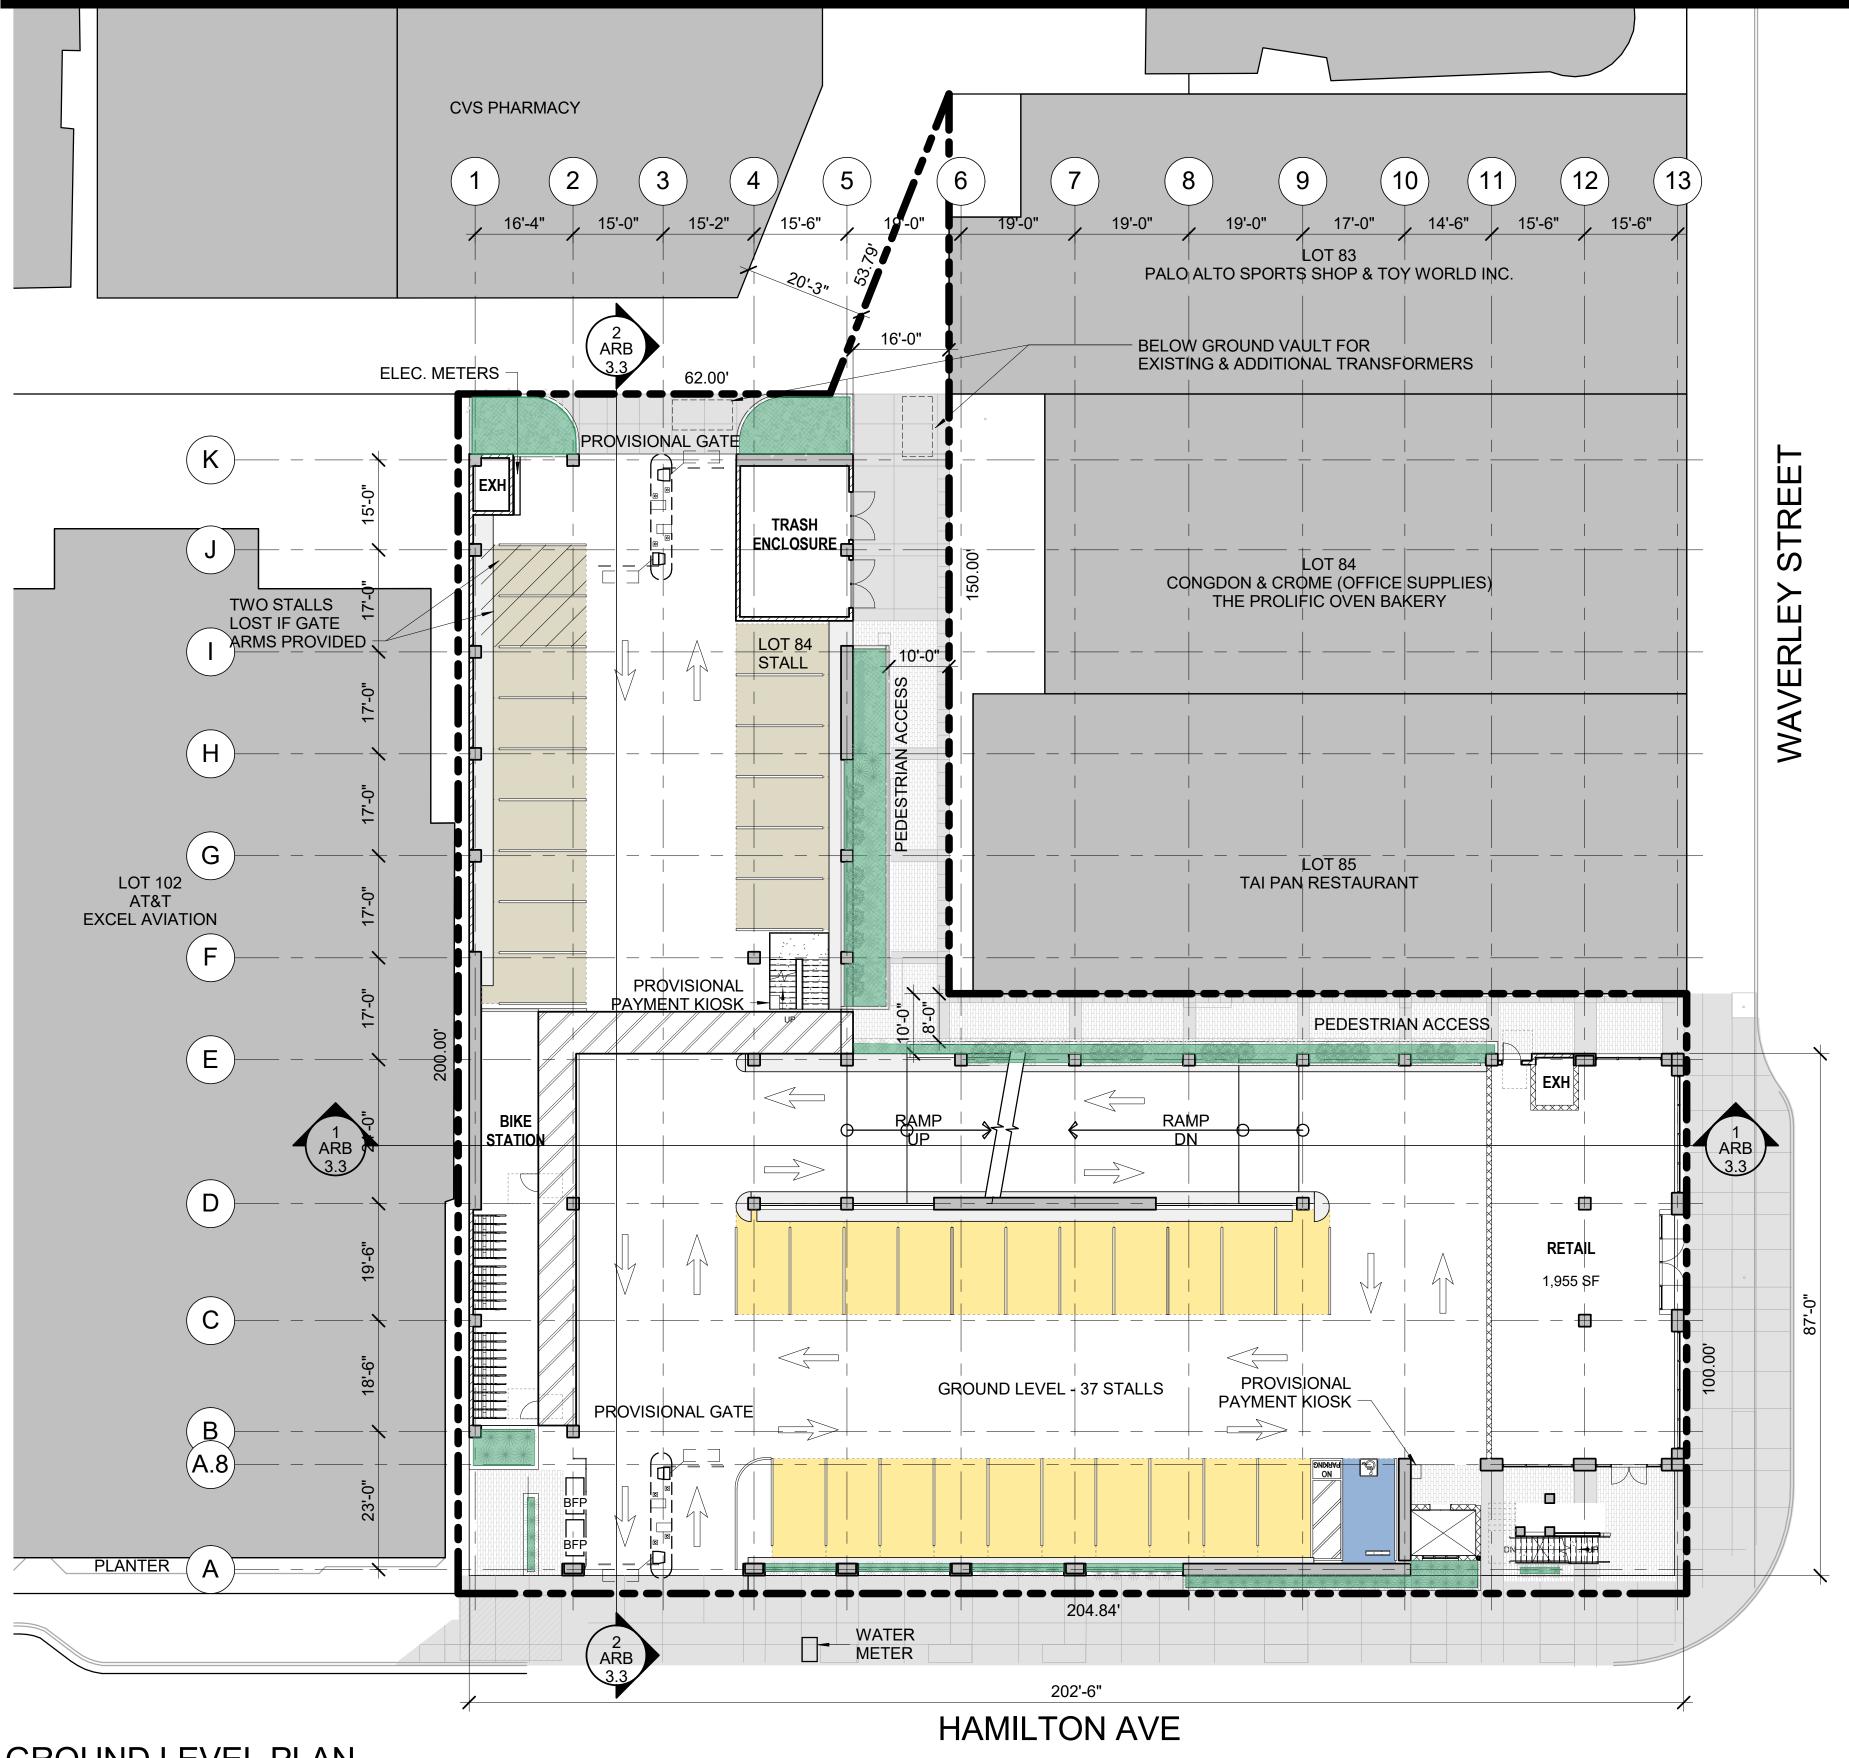


PROJECT INFORMATION


ZONING DESIGNATION: PF MAXIMUM SITE COVERAGE: NO REQUIREMENT MAXIMUM FAR: NO REQUIREMENT MAXIMUM HEIGHT: 50'-0"

LOT AREA: 29,164 SF EXISTING LOT COVERAGE: ZERO, LOT IS UNDEVELOPED PROPOSED LOT COVERAGE: 22,980 SF (80.54%) GROSS BUILDING AREA: 136,595 SF PROPOSED FLOOR AREA RATIO (FAR): 4.68 PROPOSED BUILDING HEIGHT: 49'-10" (TO TOP OF RAIL) **EXISTING ON SITE PARKING: 86 STALLS** PROPOSED PARKING: 325 STALLS (INCLUDES STALL FOR LOT 84) REQUIRED PARKING FOR RETAIL (1 space/250 sf): 8


PARKING STALL SUMMATION CHART

	TYPE										
LEVEL	VAN ACCESSIBLE	ACCESSIBLE	STANDARD (MIN)	VAN ACCESSIBLE EV	ACCESSIBLE EV	STANDARD EV (MIN)	FUTURE EV (MIN)	CLEAN AIR/ CARPOOL (MIN)	TOTAL		
	(9'-0" x 18'-0")	(9'-0" x 18'-0")	(8'-6" x 17'-0")	(9'-0" x 18'-0")	(9'-0" x 18'-0")	(8'-6" x 17'-0")	(8'-6" x 17'-0")	(8'-6" x 17'-0")			
LEVEL 05	0	0	45	0	0	0	13	4	62		
LEVEL 04	0	0	35	0	0	0	20	4	59		
LEVEL 03	1	2	24	1	1	5	5	16	55		
LEVEL 02	1	3	30	0	0	12	4	6	56		
GROUND LEVEL	0	1	36	0	0	0	0	0	37		
BASEMENT LEVEL	0	0	56	0	0	0	0	0	56		
TOTAL	2	6	244	1	1	17	43	24	325		

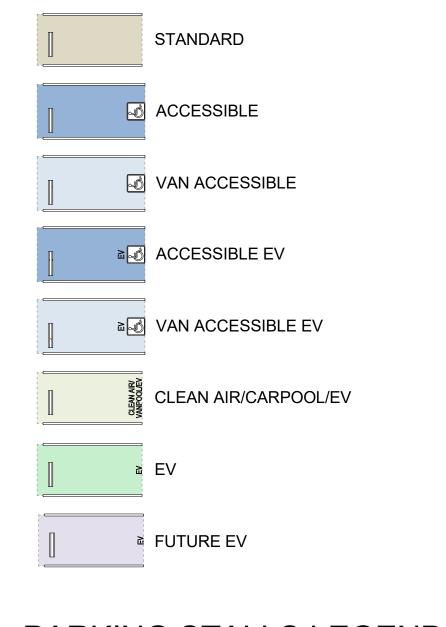

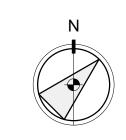

PARKING STALLS LEGEND

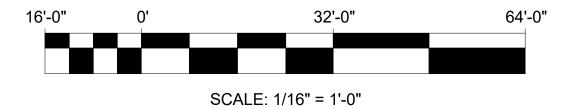


GROUND LEVEL PLAN

1/16" = 1'-0"






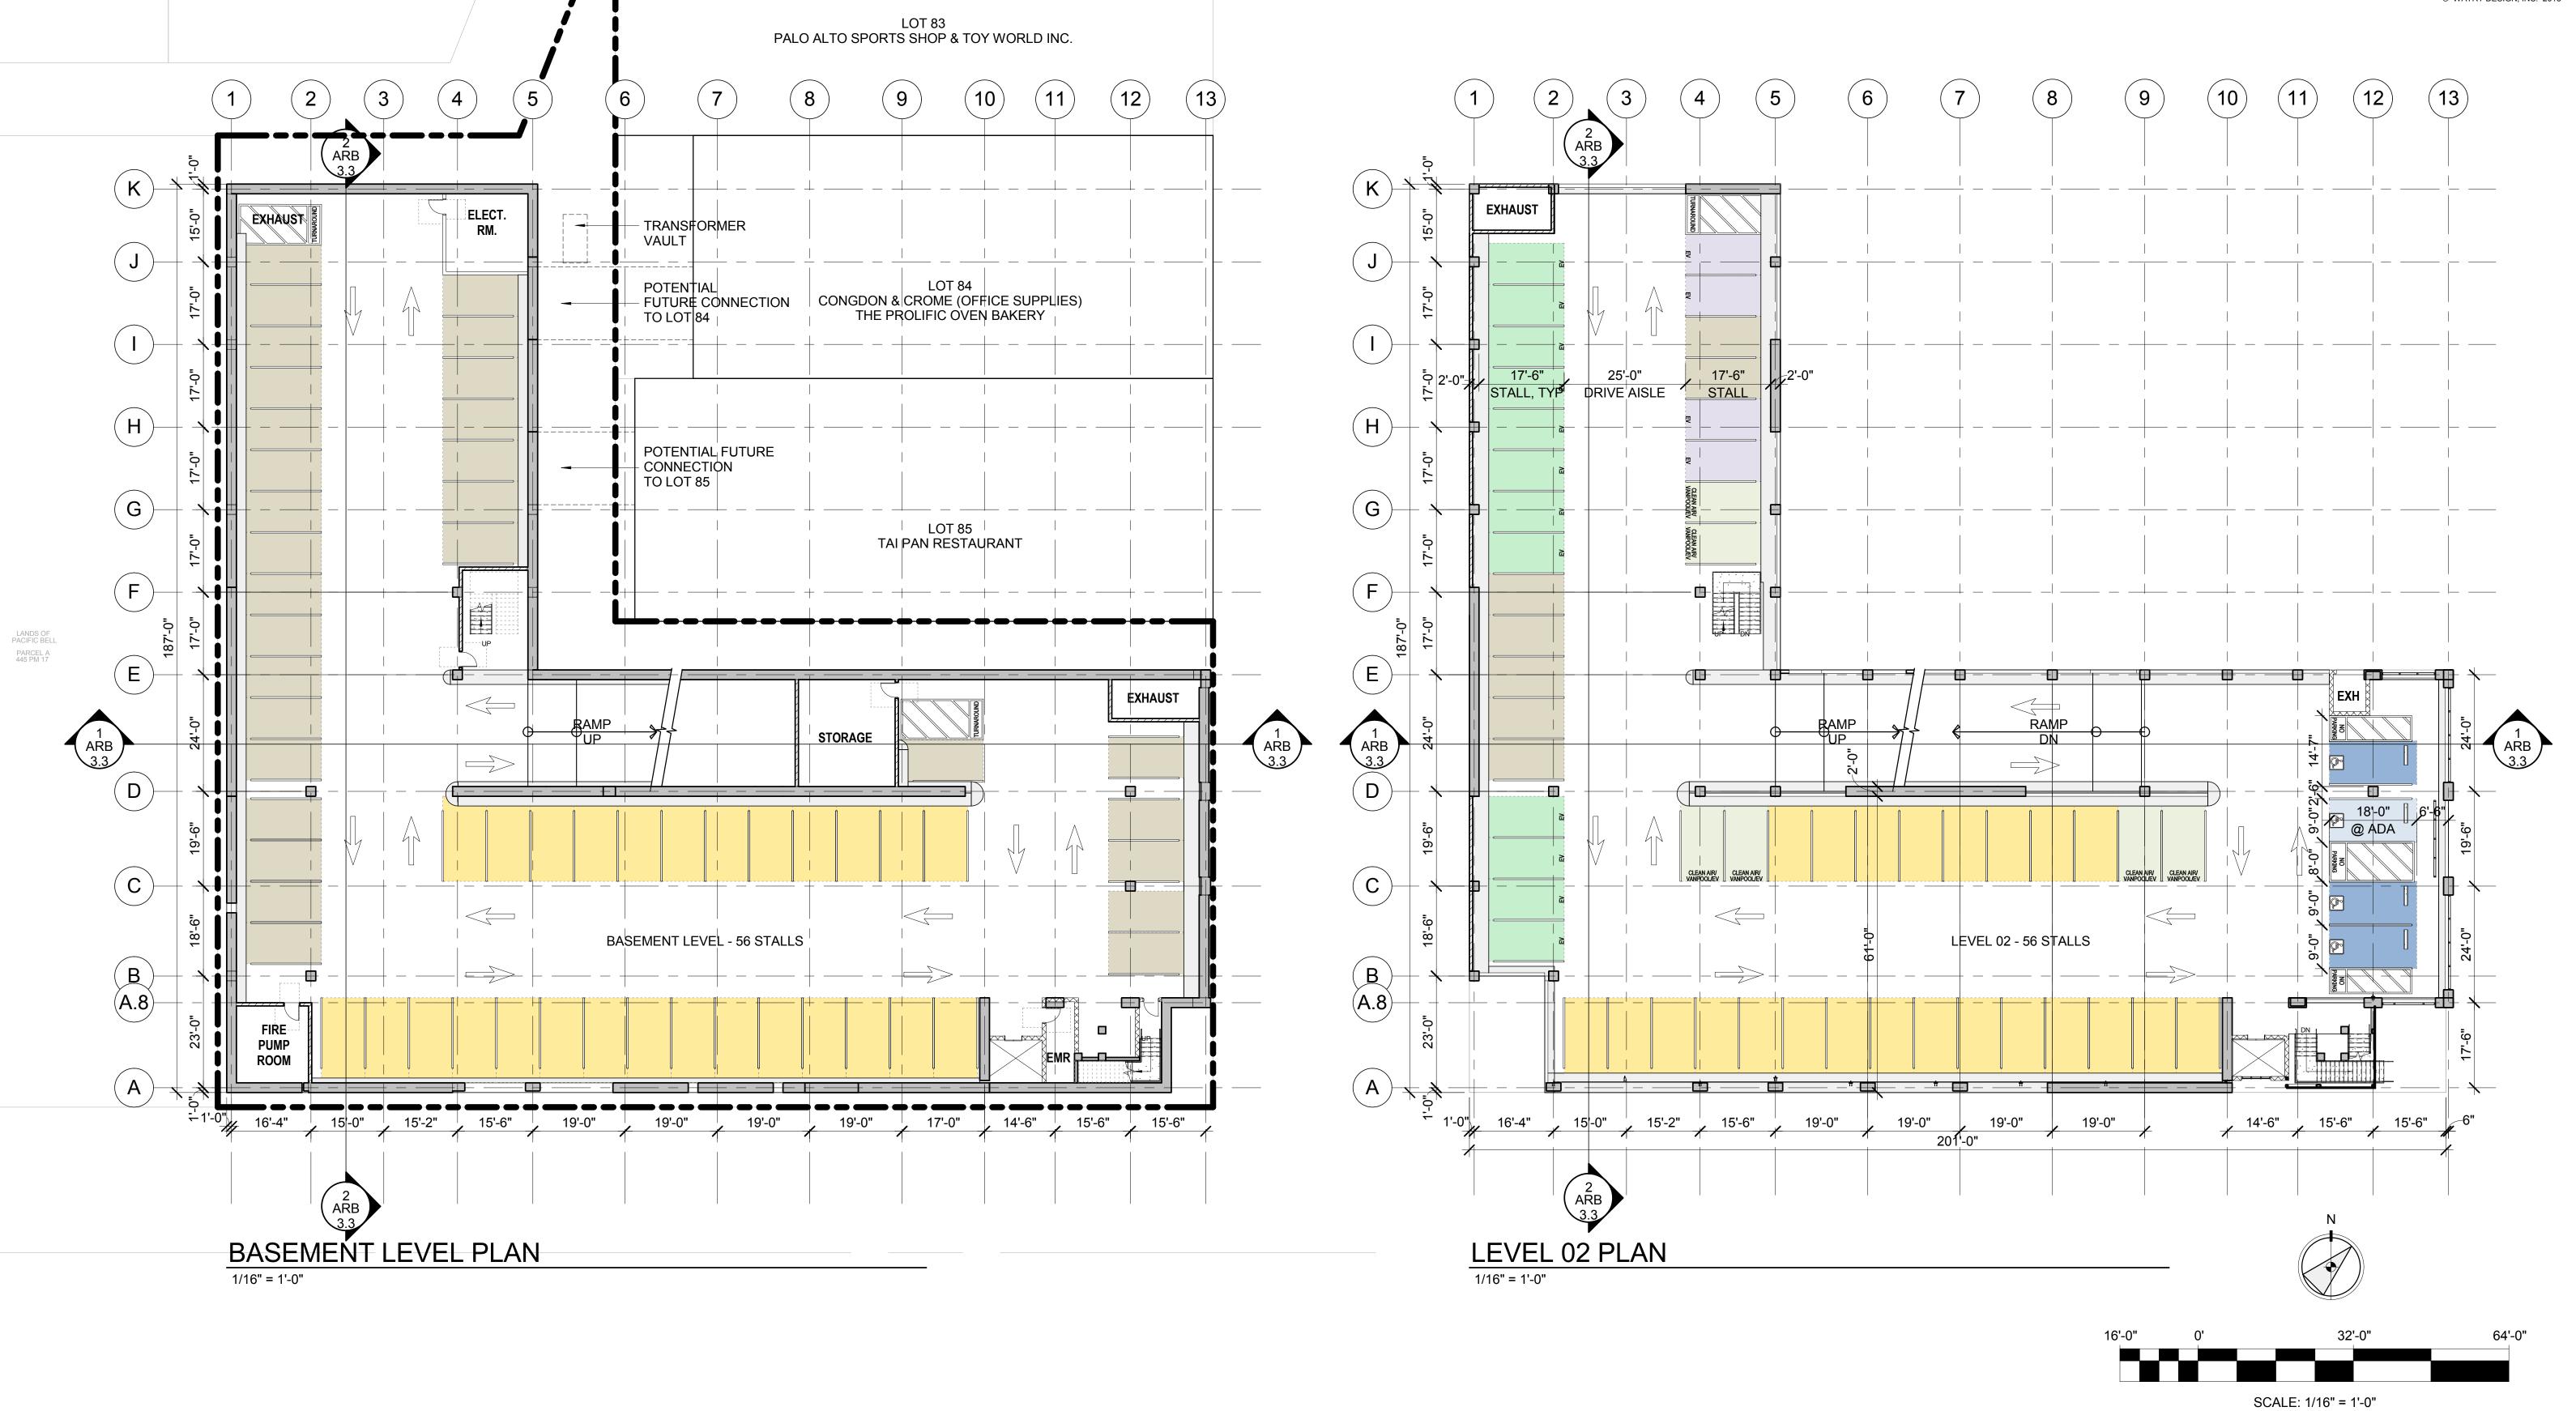







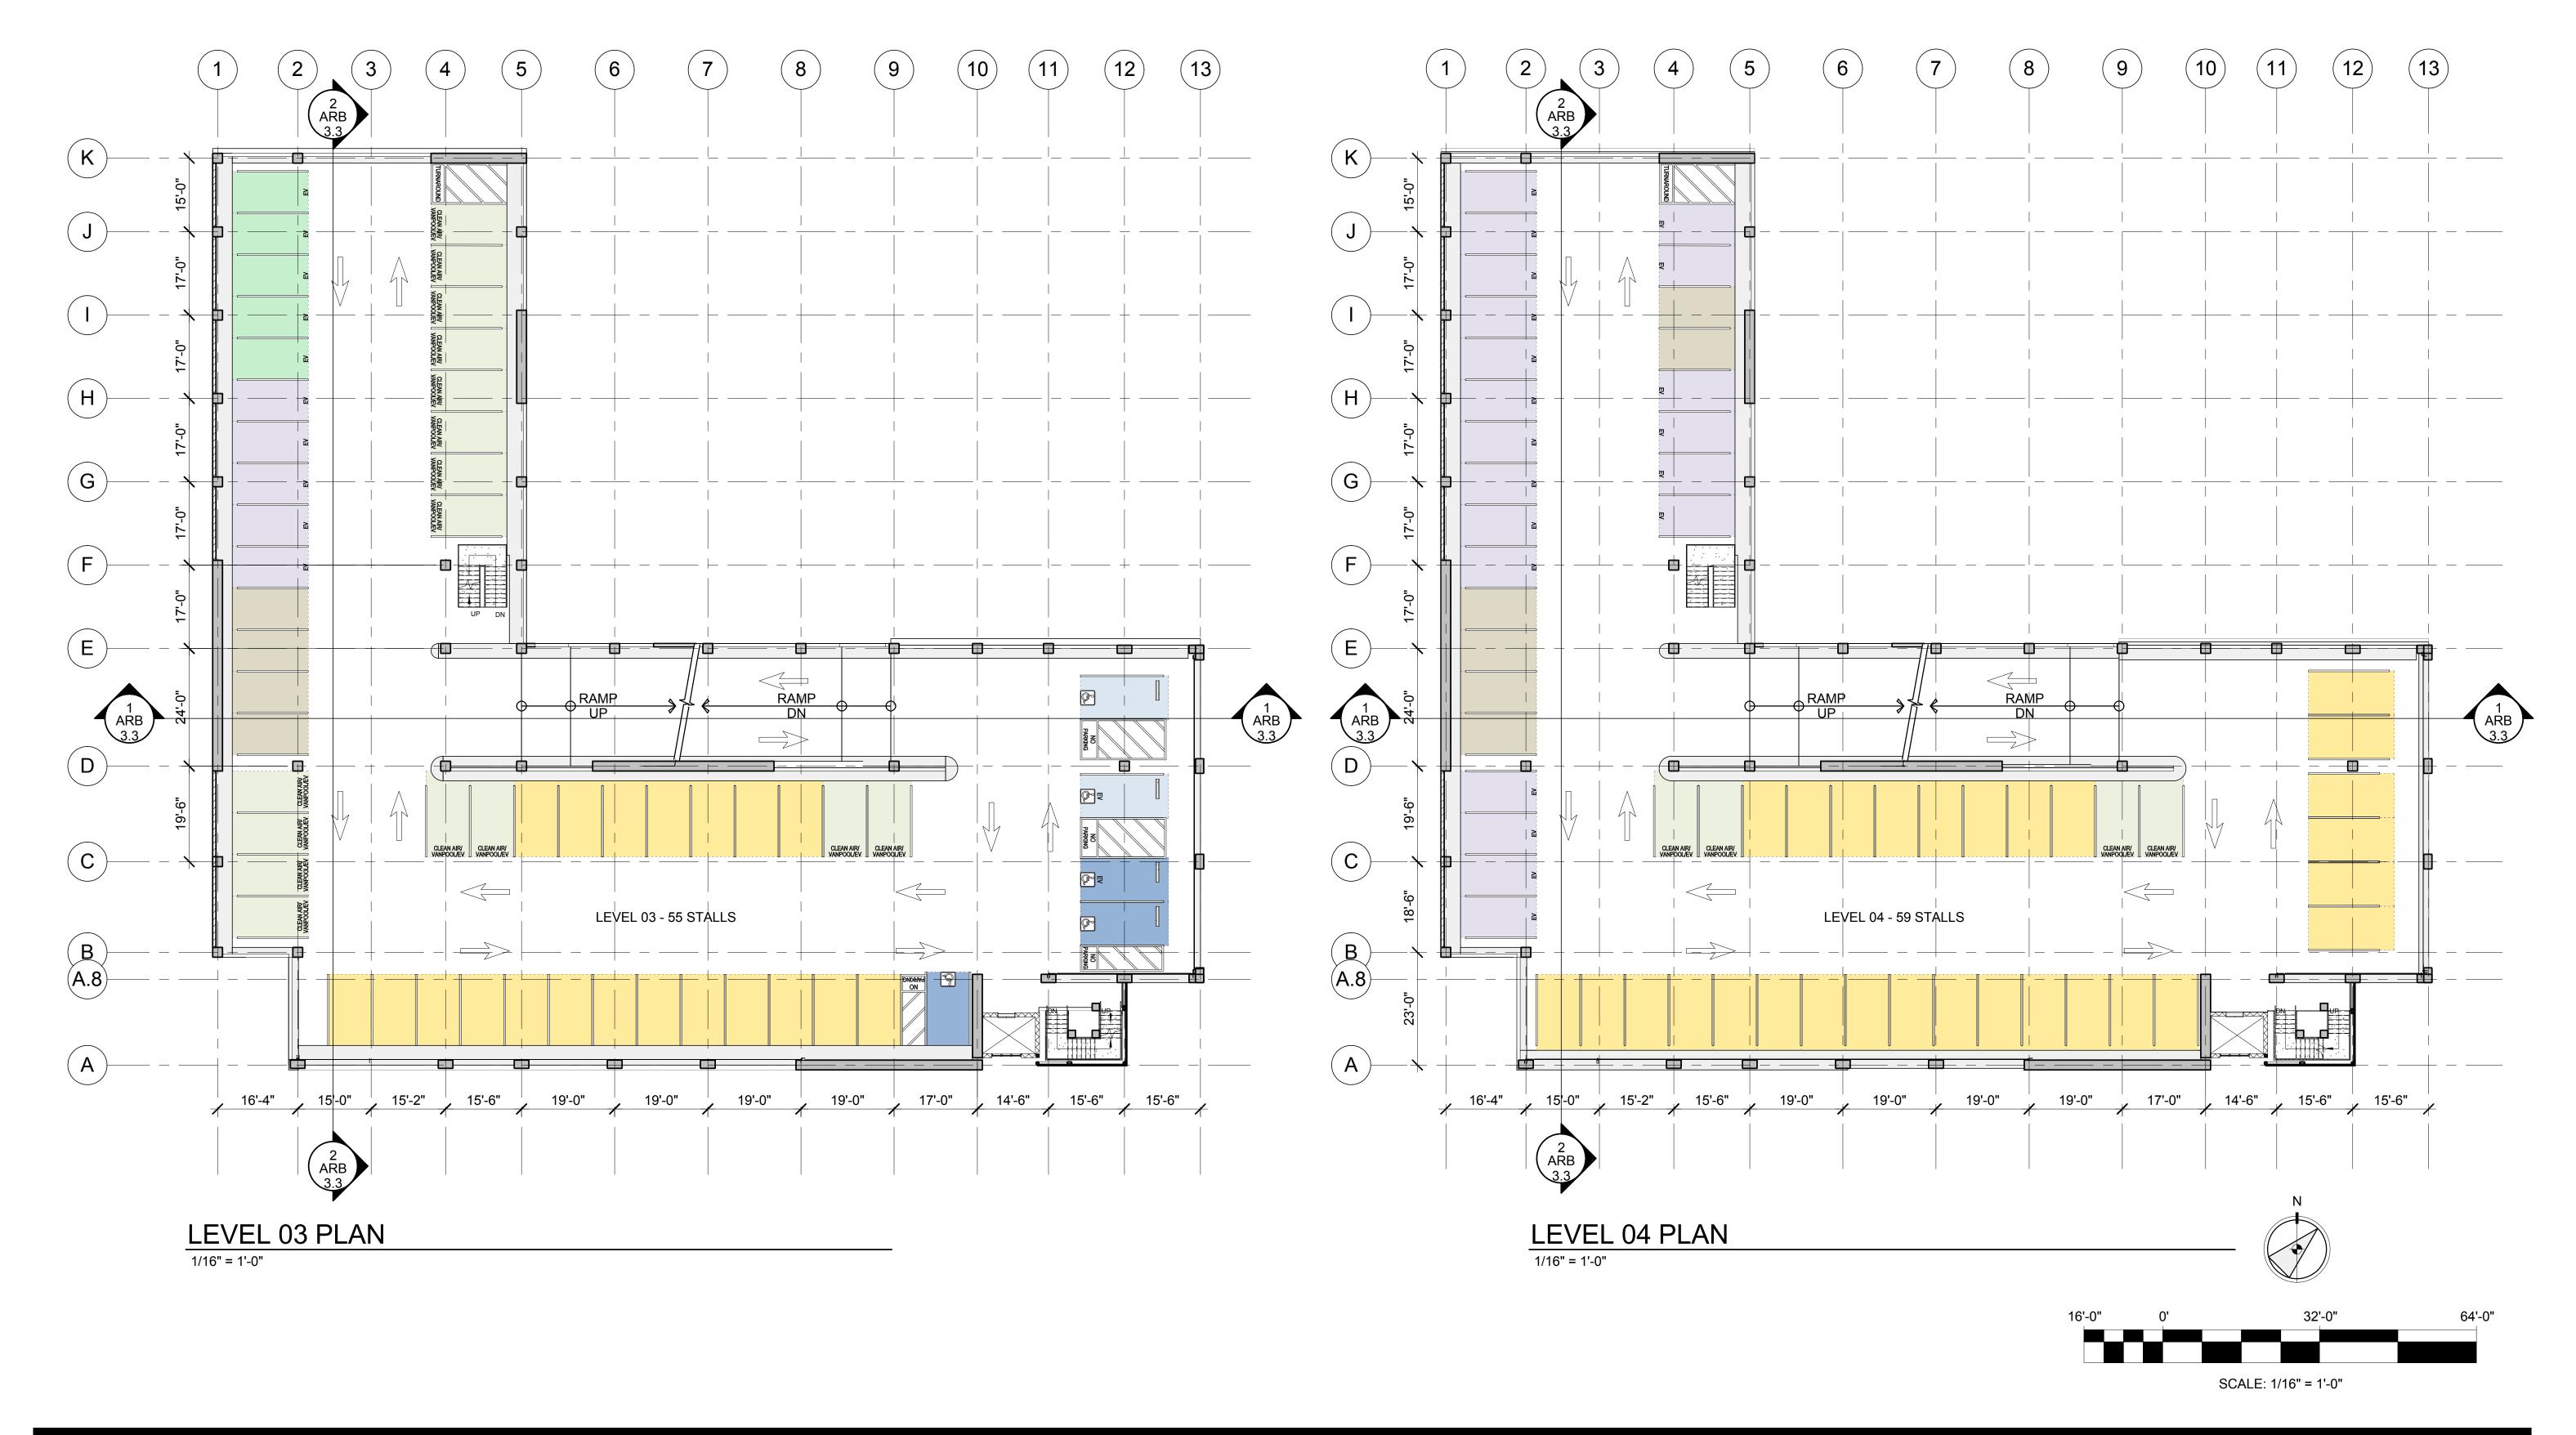






DATE ISSUED:

07/12/18

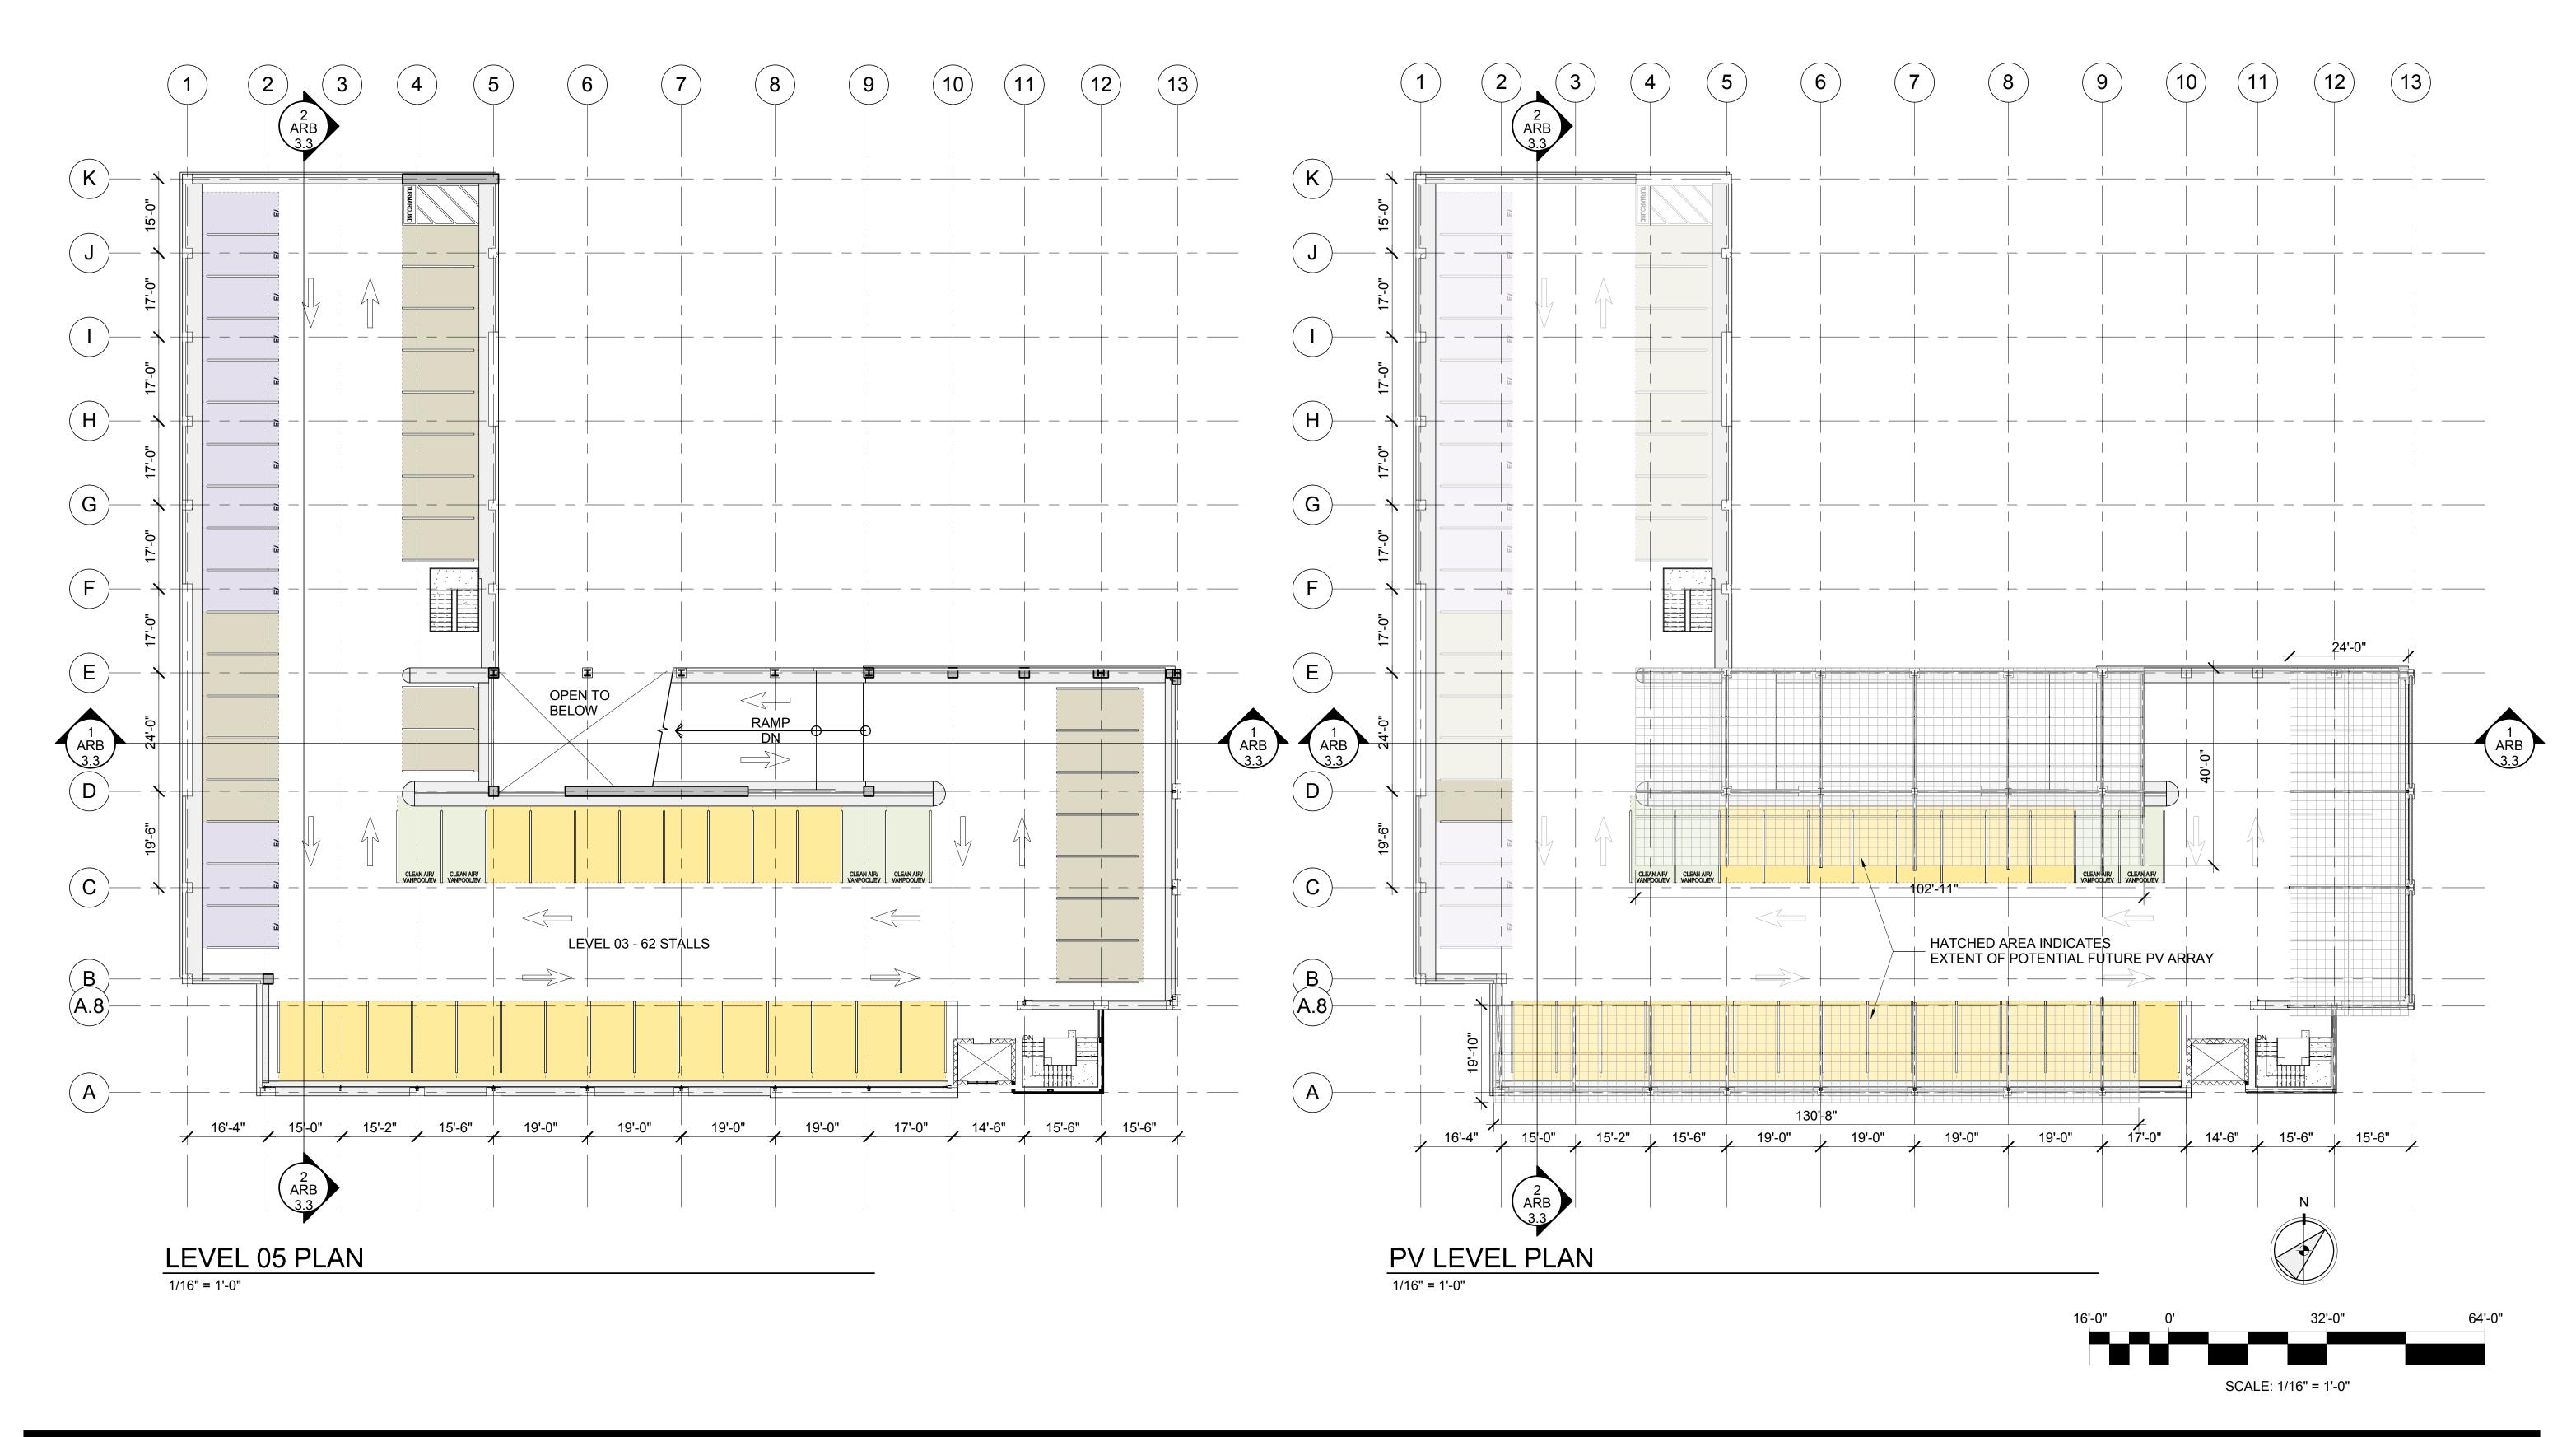






DATE ISSUED:

07/12/18

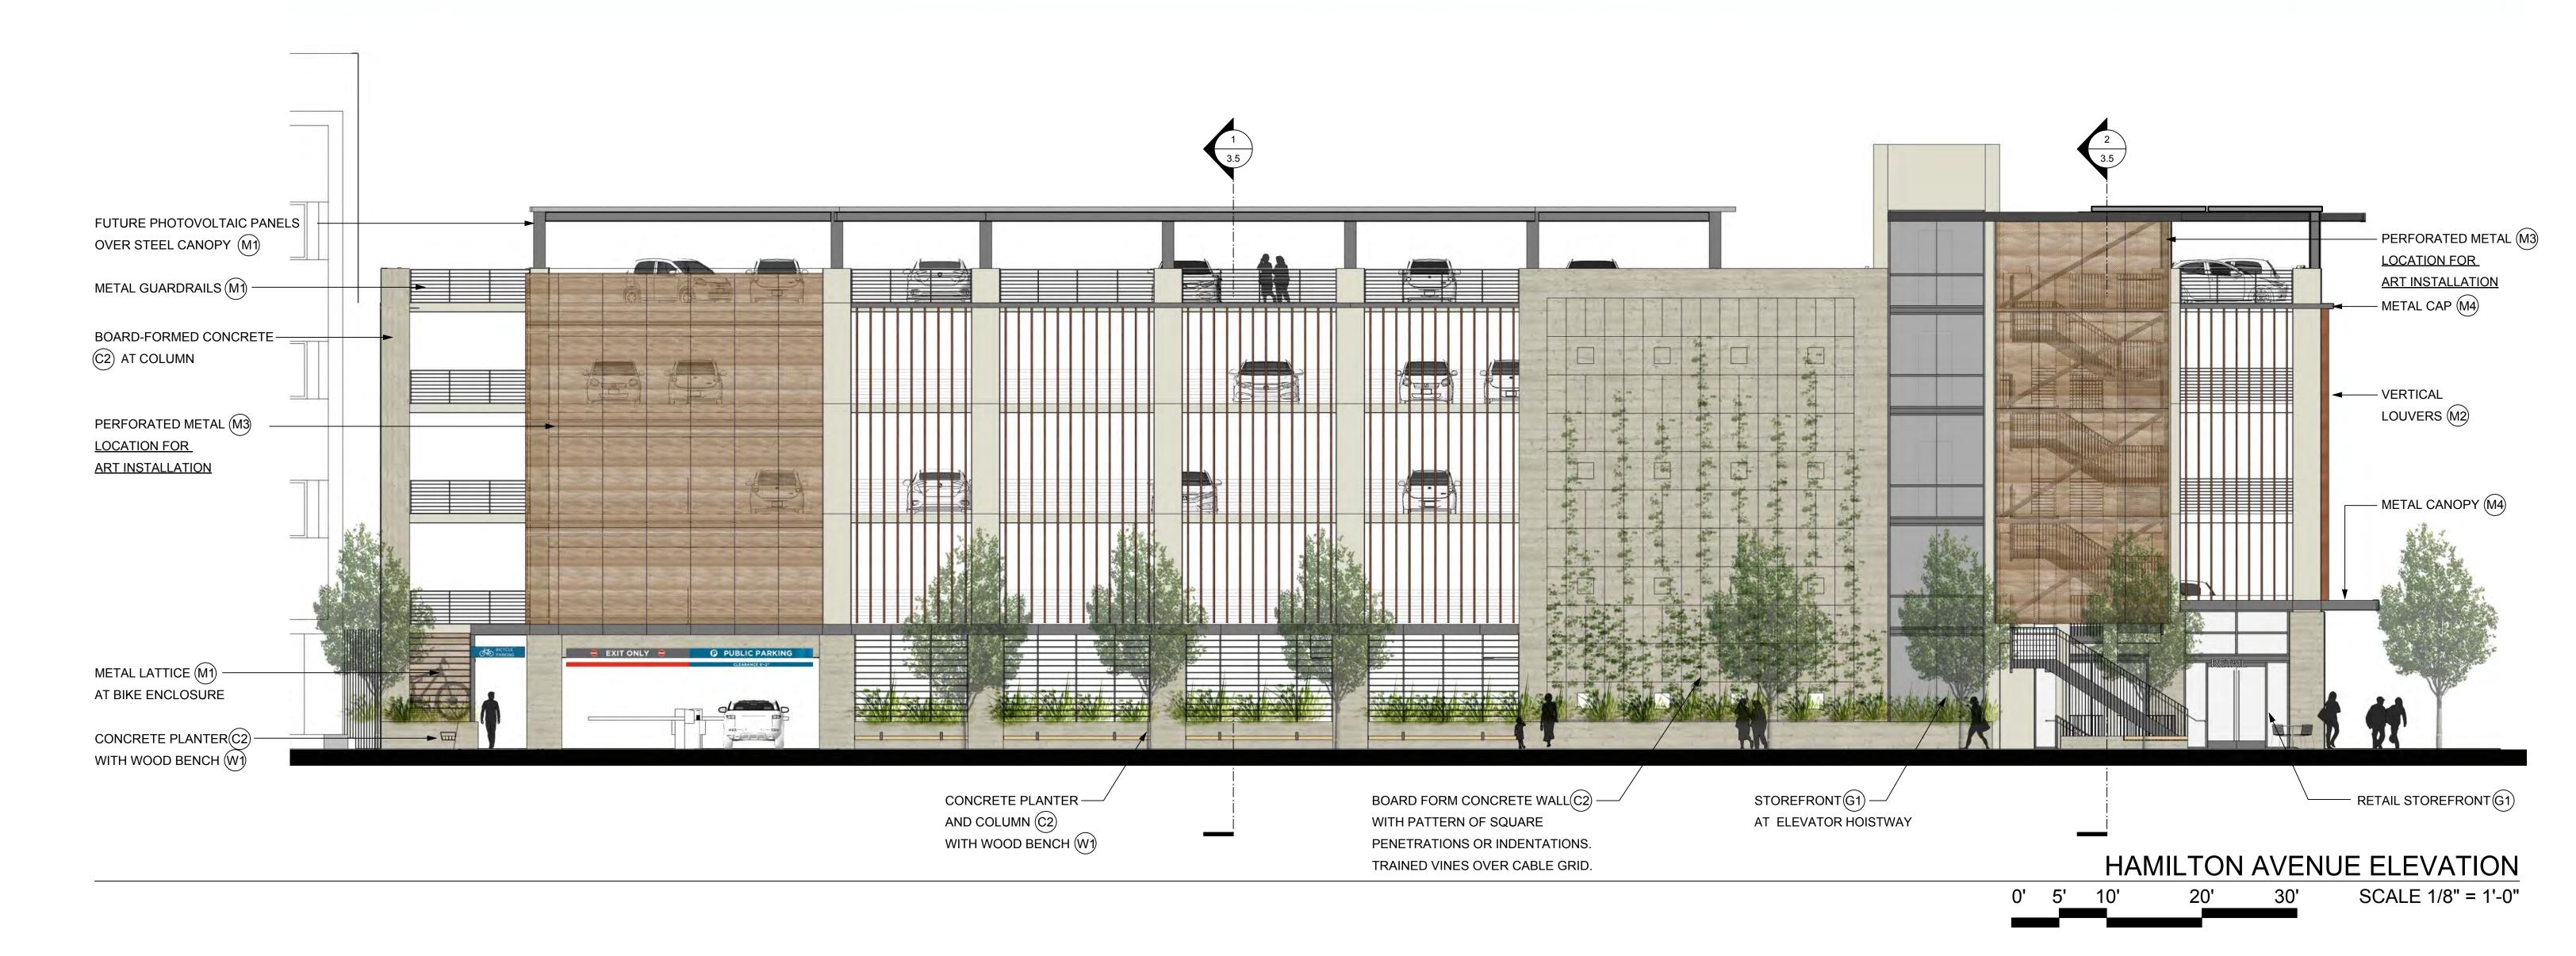


- PAINTED CONCRETE STRUCTURE CAST-IN-PLACE CONCRETE WITH TEX-COTE FINISH, 'SAND' TEXTURE, 'WHISPER GREY T-127' COLOR
- BOARD FORM CONCRETE CONCRETE NATURAL COLOR
- RETAIL STOREFRONT SYSTEM **CLEAR TEMPERED GLAZING** WITHIN DARK ANODIZED ALUMINUM STOREFRONT FRAME
- PAINTED STEEL POSTS AND TRIM, GUARDRAIL AND PICKETS. GALVANIZED STEEL SHAPE, PAINT 'DARK BRONZE'
- **ALUMINUM SUNSHADE** 'LEVOLUX INFINITY' EXTRUDED ALUMINUM VERTICAL LOUVRE RECTANGLE PROFILE BLADE, 16" X 2" POLYESTER POWDER-COATED, 'TERRACOTTA' COLOR
- PERFORATED METAL PANEL CUSTOM PERFORATED ALUMINUM PANEL, COLOR 'BURNISHED BRONZE', 40% OPEN

- M4 ALUMINUM COMPOSITE CANOPY COMPOSITE METAL PANELS, DARK BRONZE COLOR.
- **CEMENT PLASTER** SMOOTH CEMENT PLASTER, COLOR TO MATCH PAINTED CONCRETE
 - STAINED WOOD BENCH 4 X 4 WESTERN RED CEDAR BOARDS WITH CLEAR MATTE FINISH

FINISH LEGEND

DATE ISSUED:

CLIENT NAME:

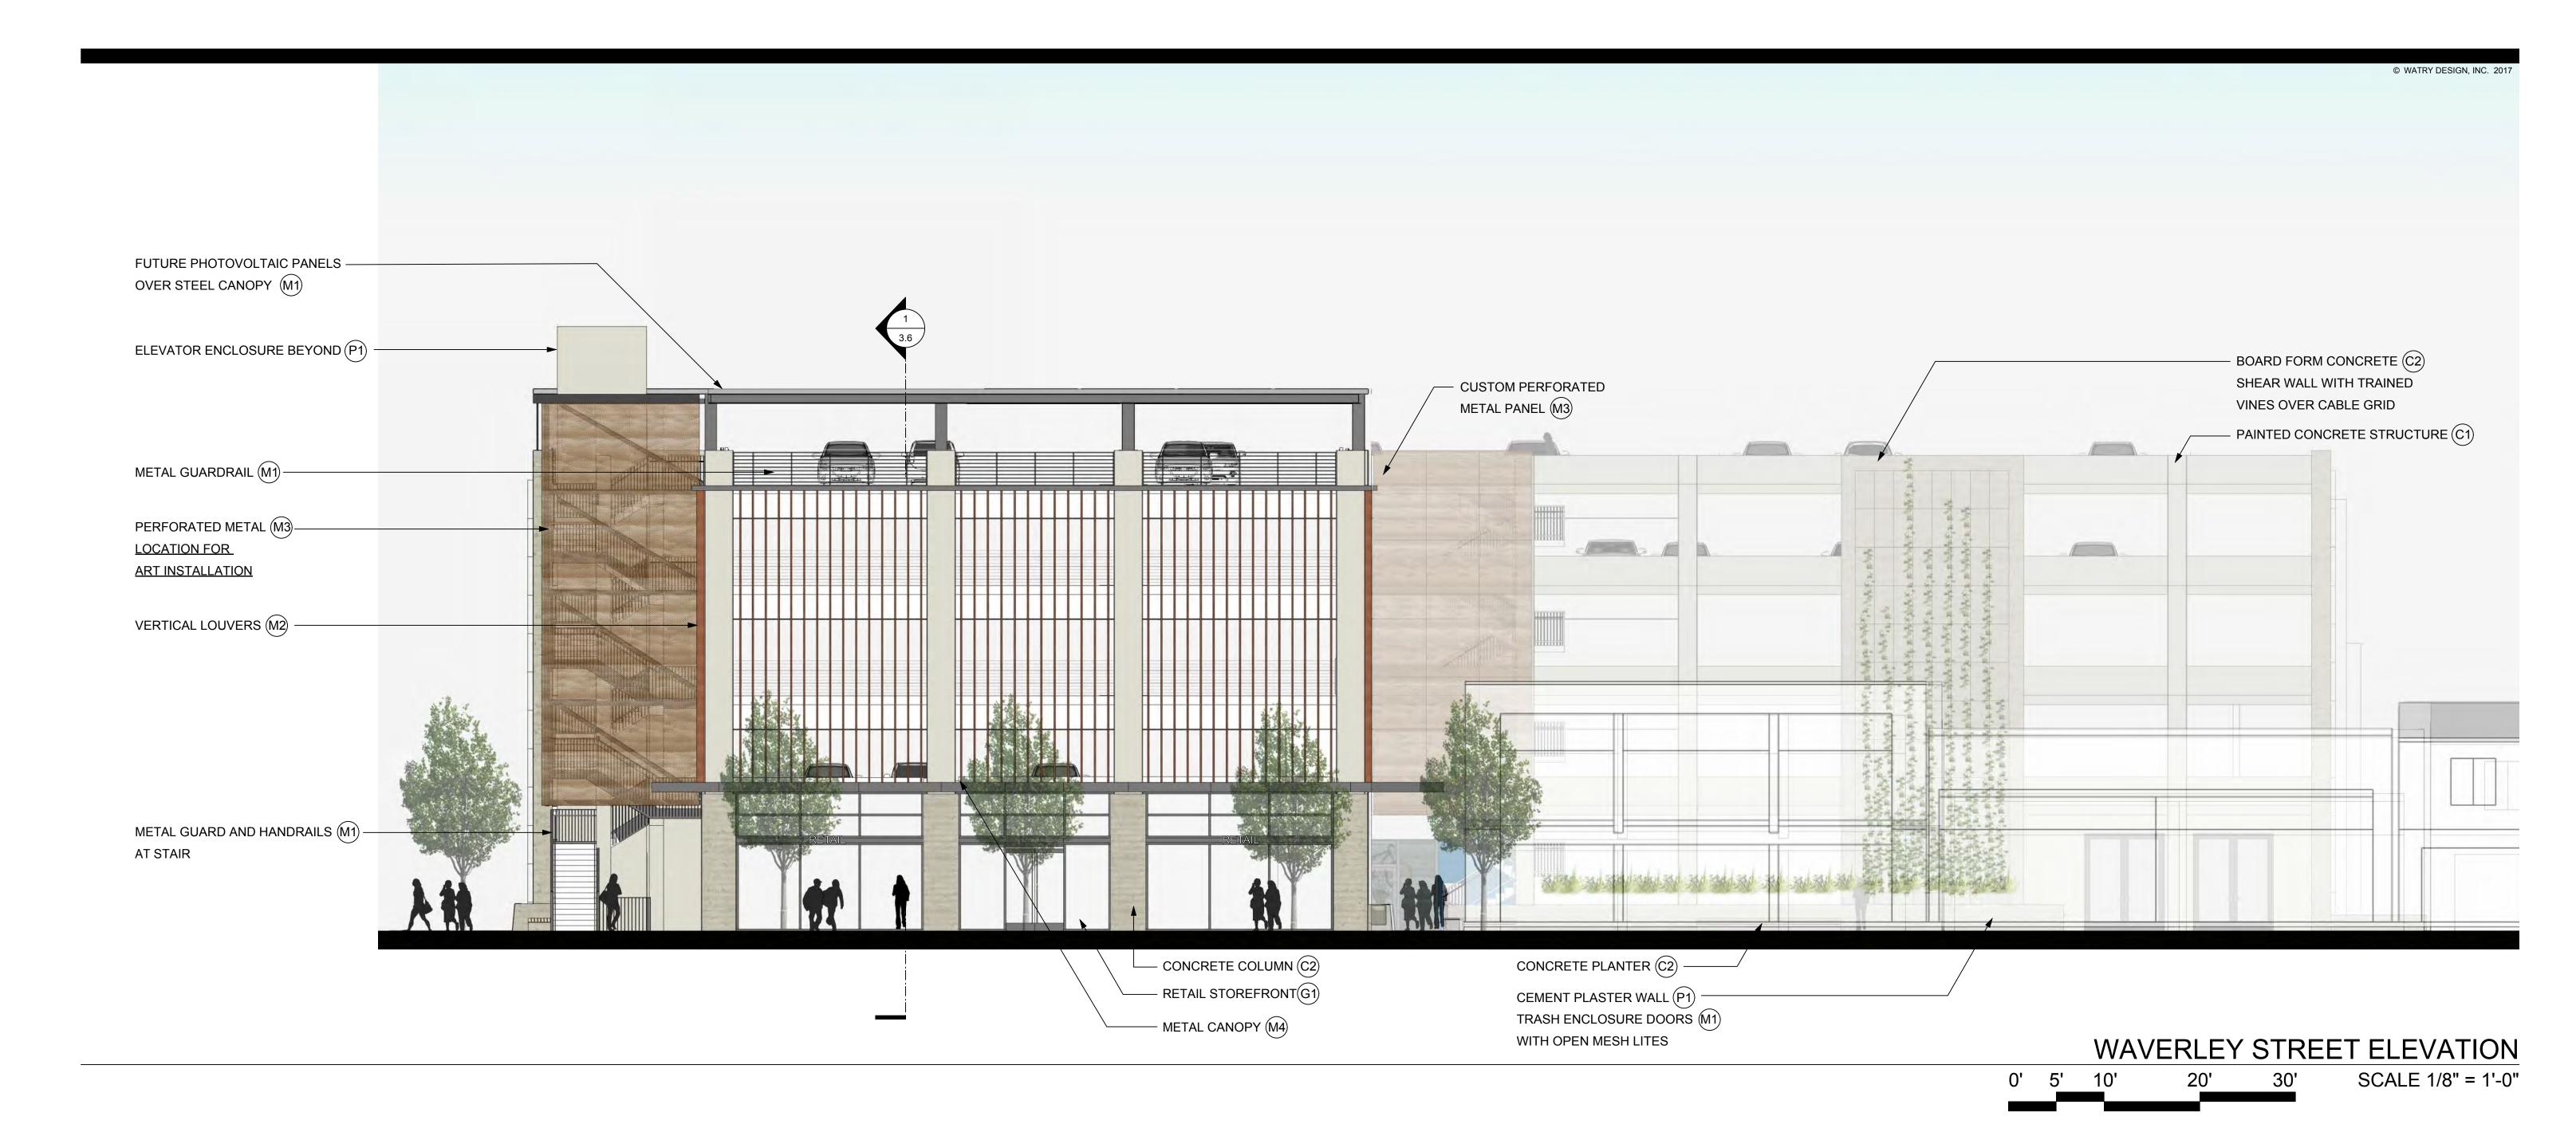


- PAINTED CONCRETE STRUCTURE CAST-IN-PLACE CONCRETE WITH TEX-COTE FINISH, 'SAND' TEXTURE, 'WHISPER GREY T-127' COLOR
- BOARD FORM CONCRETE CONCRETE NATURAL COLOR
- RETAIL STOREFRONT SYSTEM **CLEAR TEMPERED GLAZING** WITHIN DARK ANODIZED ALUMINUM STOREFRONT FRAME
- PAINTED STEEL POSTS AND TRIM, GUARDRAIL AND PICKETS. GALVANIZED STEEL SHAPE, PAINT 'DARK BRONZE'
- **ALUMINUM SUNSHADE** 'LEVOLUX INFINITY' EXTRUDED ALUMINUM VERTICAL LOUVRE RECTANGLE PROFILE BLADE, 16" X 2" POLYESTER POWDER-COATED, 'TERRACOTTA' COLOR
- PERFORATED METAL PANEL CUSTOM PERFORATED ALUMINUM PANEL, COLOR 'BURNISHED BRONZE', 40% OPEN

- **M4** ALUMINUM COMPOSITE CANOPY COMPOSITE METAL PANELS, DARK BRONZE COLOR.
- **CEMENT PLASTER** SMOOTH CEMENT PLASTER, COLOR TO MATCH PAINTED CONCRETE
- STAINED WOOD BENCH 4 X 4 WESTERN RED CEDAR BOARDS WITH CLEAR MATTE FINISH

FINISH LEGEND

DATE ISSUED:

CLIENT NAME:

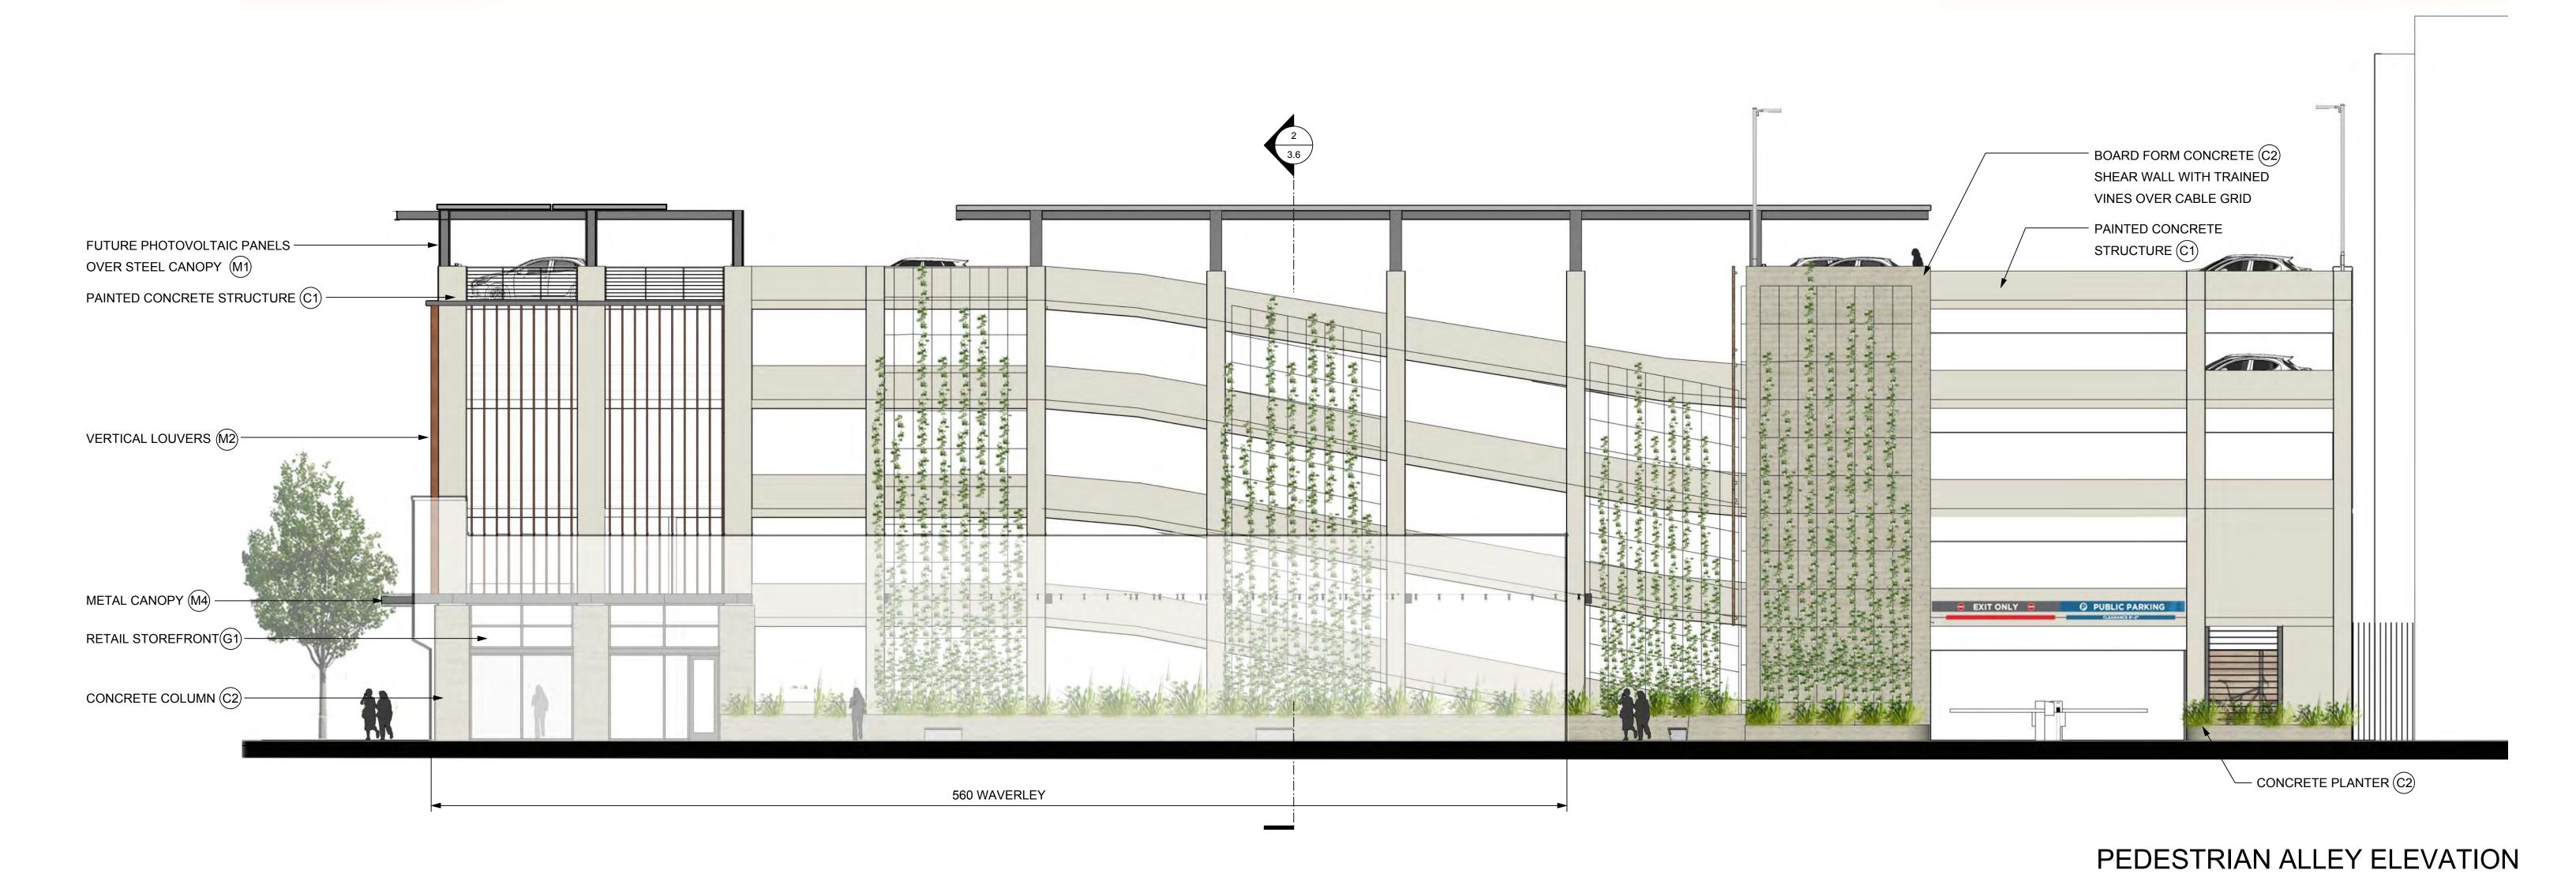

- C1 PAINTED CONCRETE STRUCTURE

 CAST-IN-PLACE CONCRETE WITH TEX-COTE FINISH,

 'SAND' TEXTURE, 'WHISPER GREY T-127' COLOR
- ©2 BOARD FORM CONCRETE CONCRETE
 NATURAL COLOR
- G1 RETAIL STOREFRONT SYSTEM
 CLEAR TEMPERED GLAZING
 WITHIN DARK ANODIZED ALUMINUM STOREFRONT FRAME
- M1 PAINTED STEEL POSTS AND TRIM, GUARDRAIL AND PICKETS.
 GALVANIZED STEEL SHAPE, PAINT 'DARK BRONZE'
- M2 ALUMINUM SUNSHADE

 'LEVOLUX INFINITY' EXTRUDED ALUMINUM VERTICAL LOUVRE

 RECTANGLE PROFILE BLADE, 16" X 2"

 POLYESTER POWDER-COATED, 'TERRACOTTA' COLOR
 - PERFORATED METAL PANEL

 CUSTOM PERFORATED ALUMINUM PANEL,

 COLOR 'BURNISHED BRONZE', 40% OPEN

M4) <u>ALUMINUM COMPOSITE CANOPY</u>
COMPOSITE METAL PANELS, DARK BRONZE COLOR.

30'

- P1 CEMENT PLASTER
 SMOOTH CEMENT PLASTER,
 COLOR TO MATCH PAINTED CONCRETE
- (1) <u>STAINED WOOD BENCH</u>
 4 X 4 WESTERN RED CEDAR BOARDS WITH CLEAR MATTE FINISH


FINISH LEGEND

SCALE 1/8" = 1'-0"




CLIENT NAME:

DATE ISSUED:

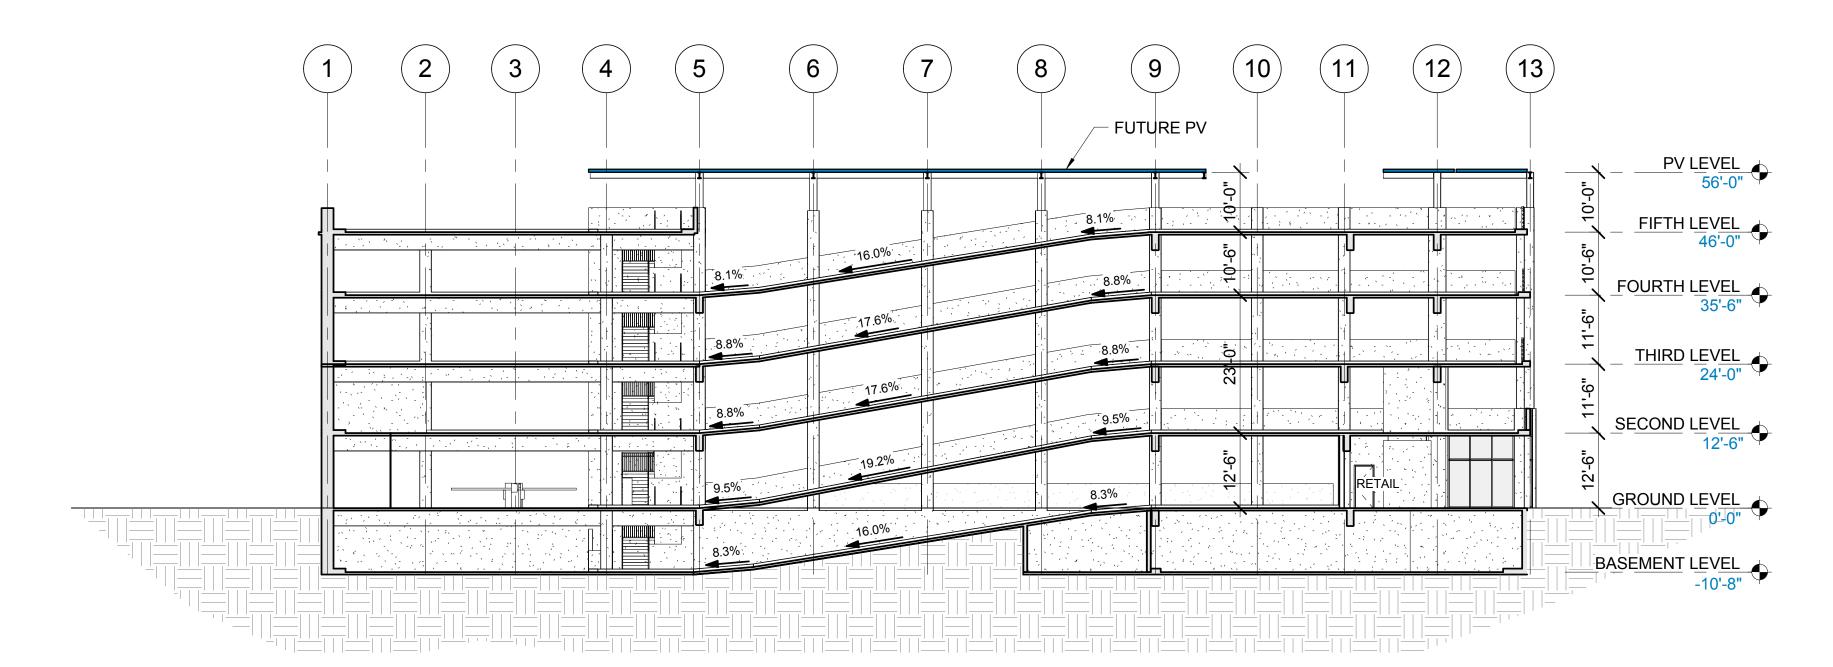




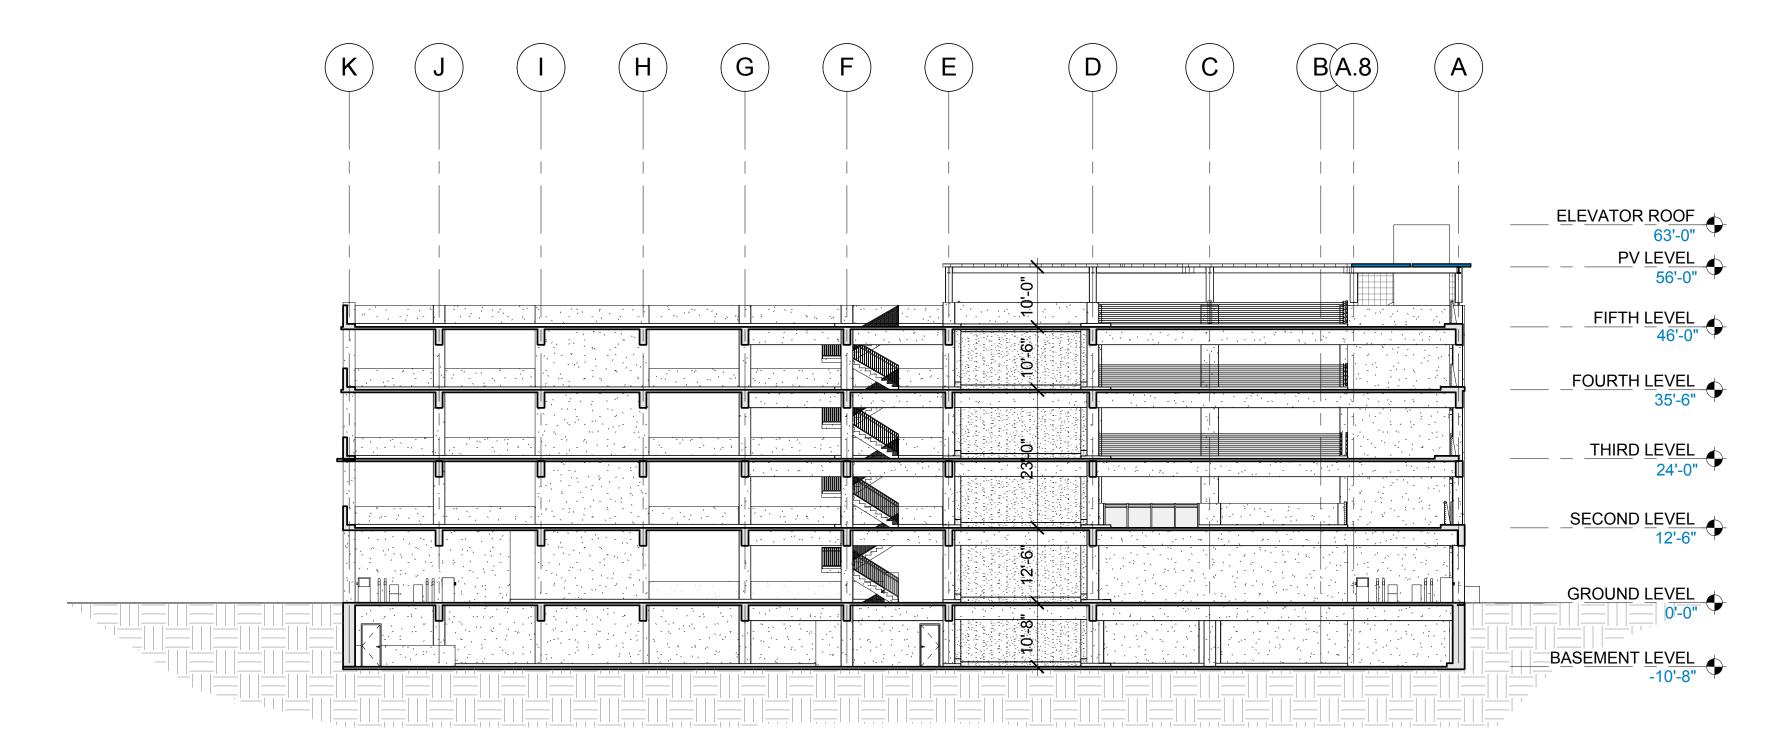






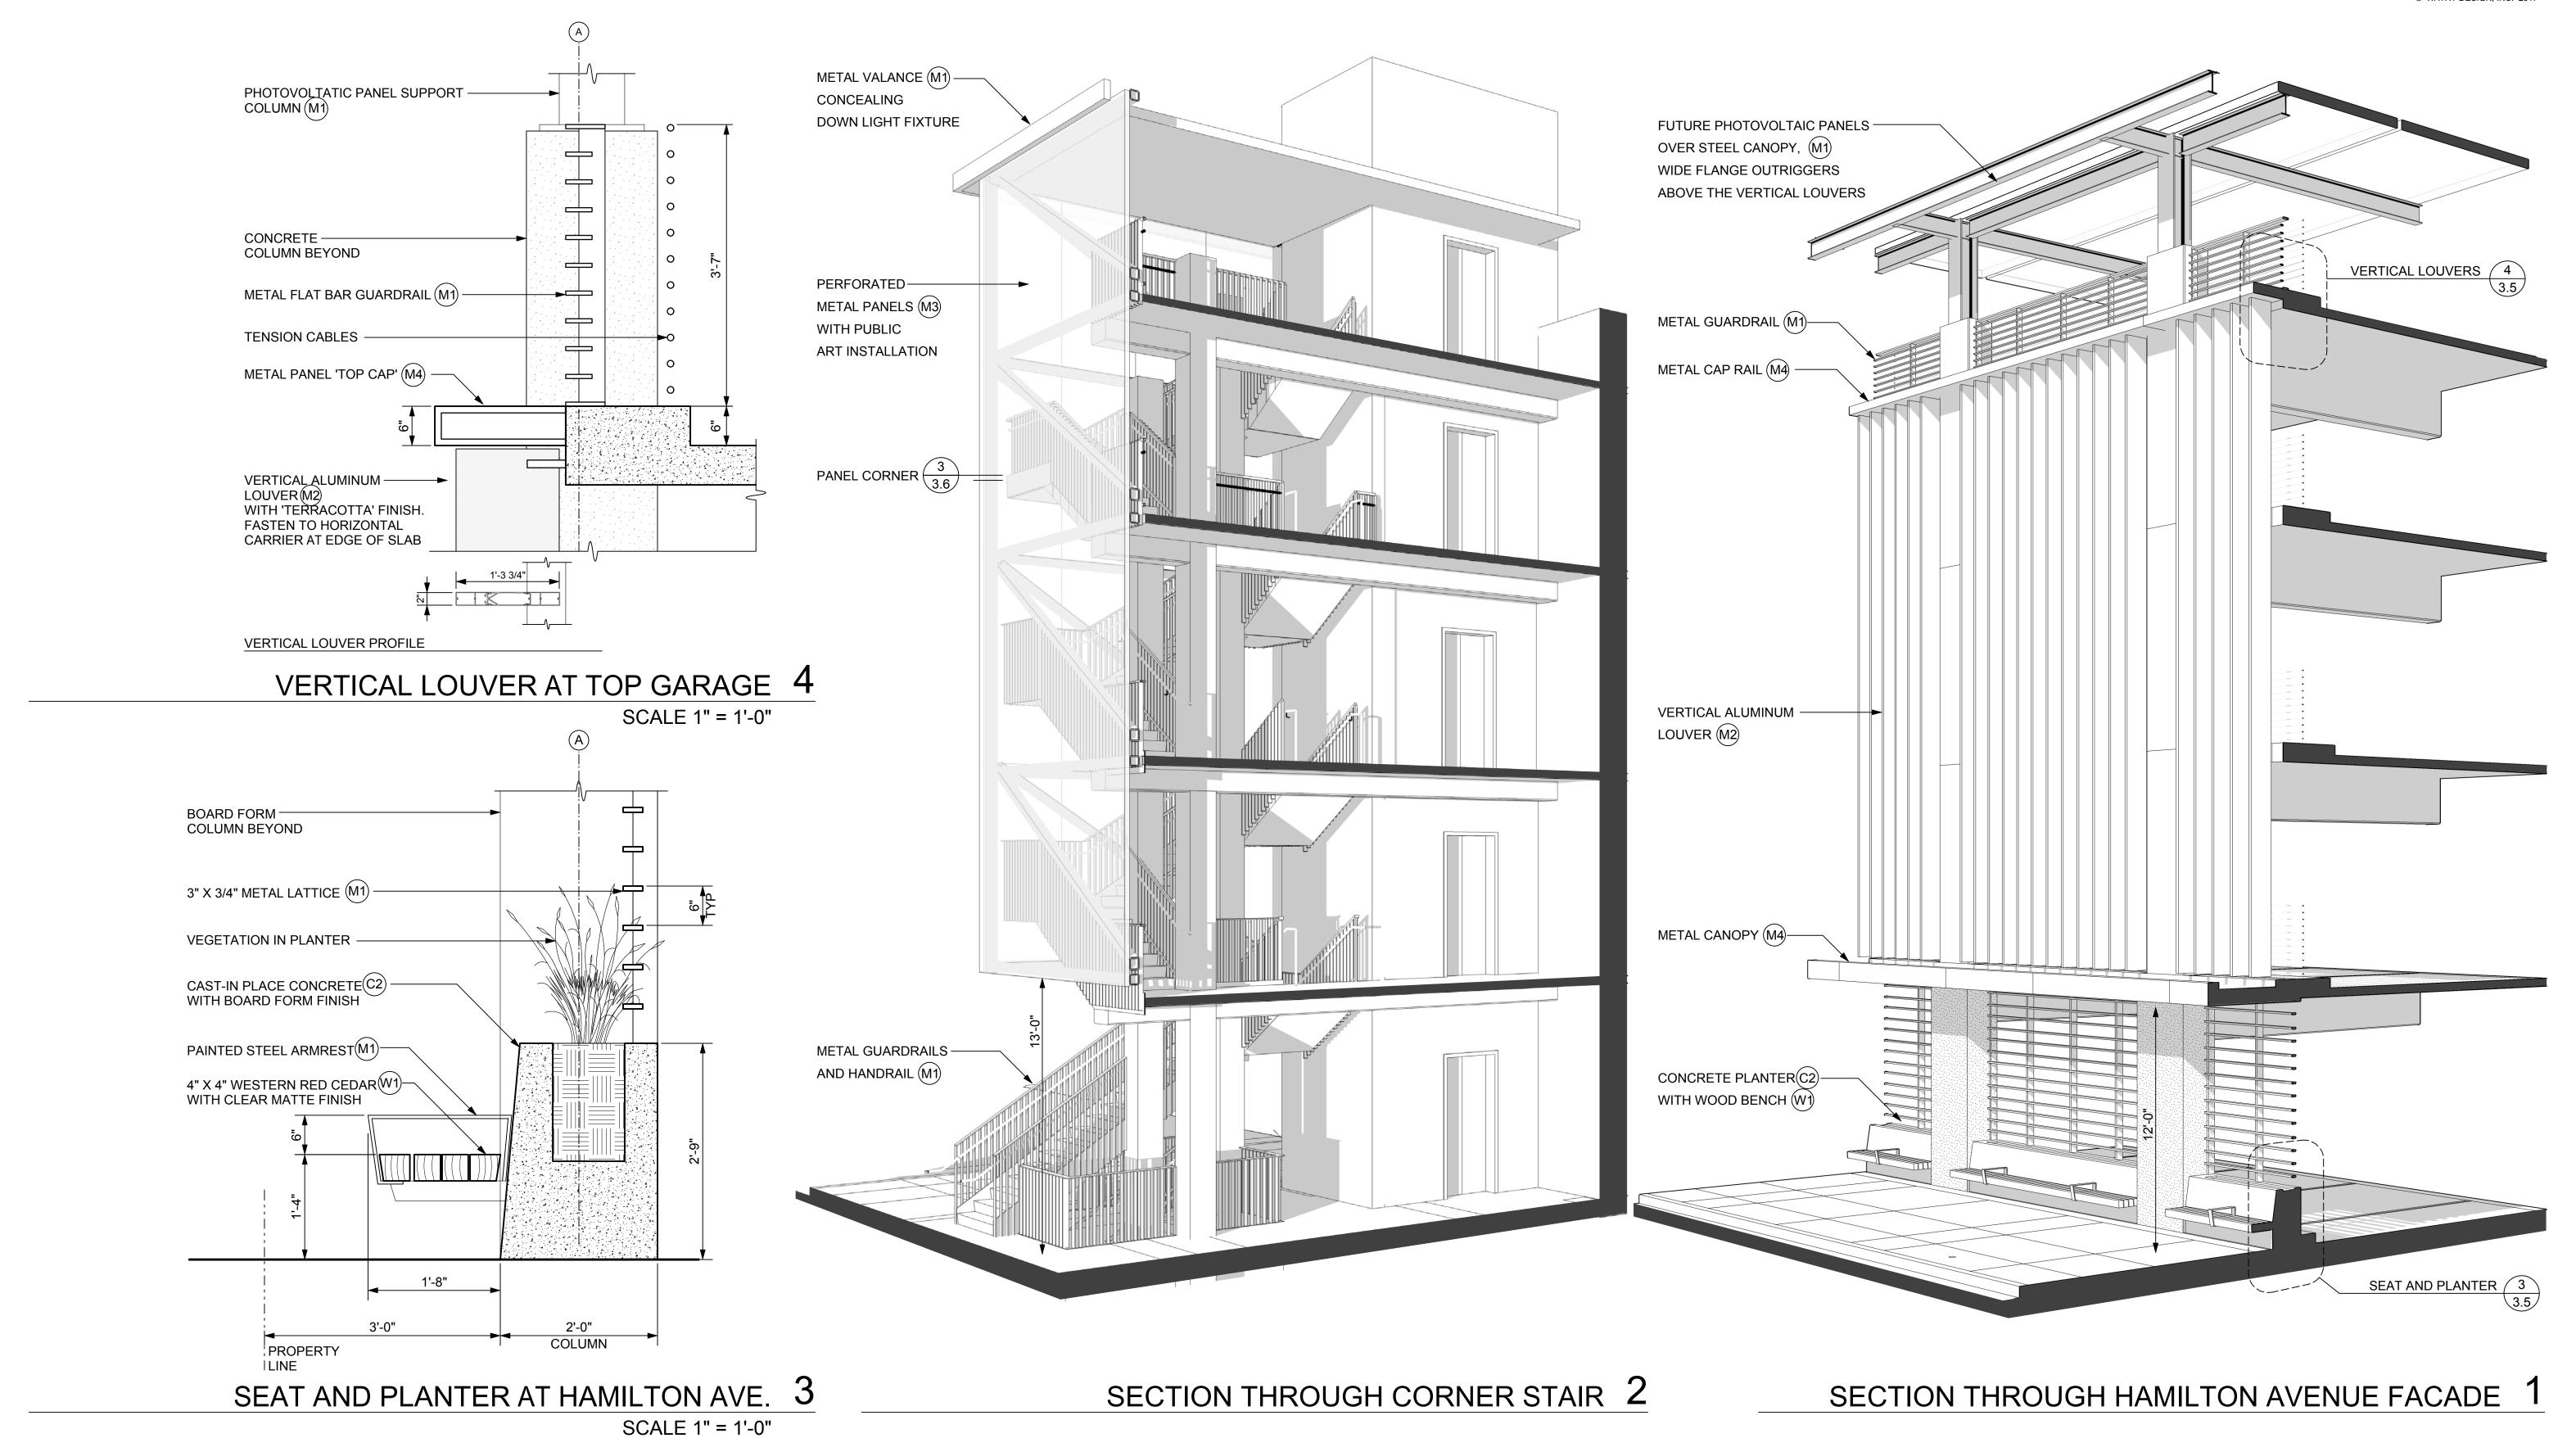





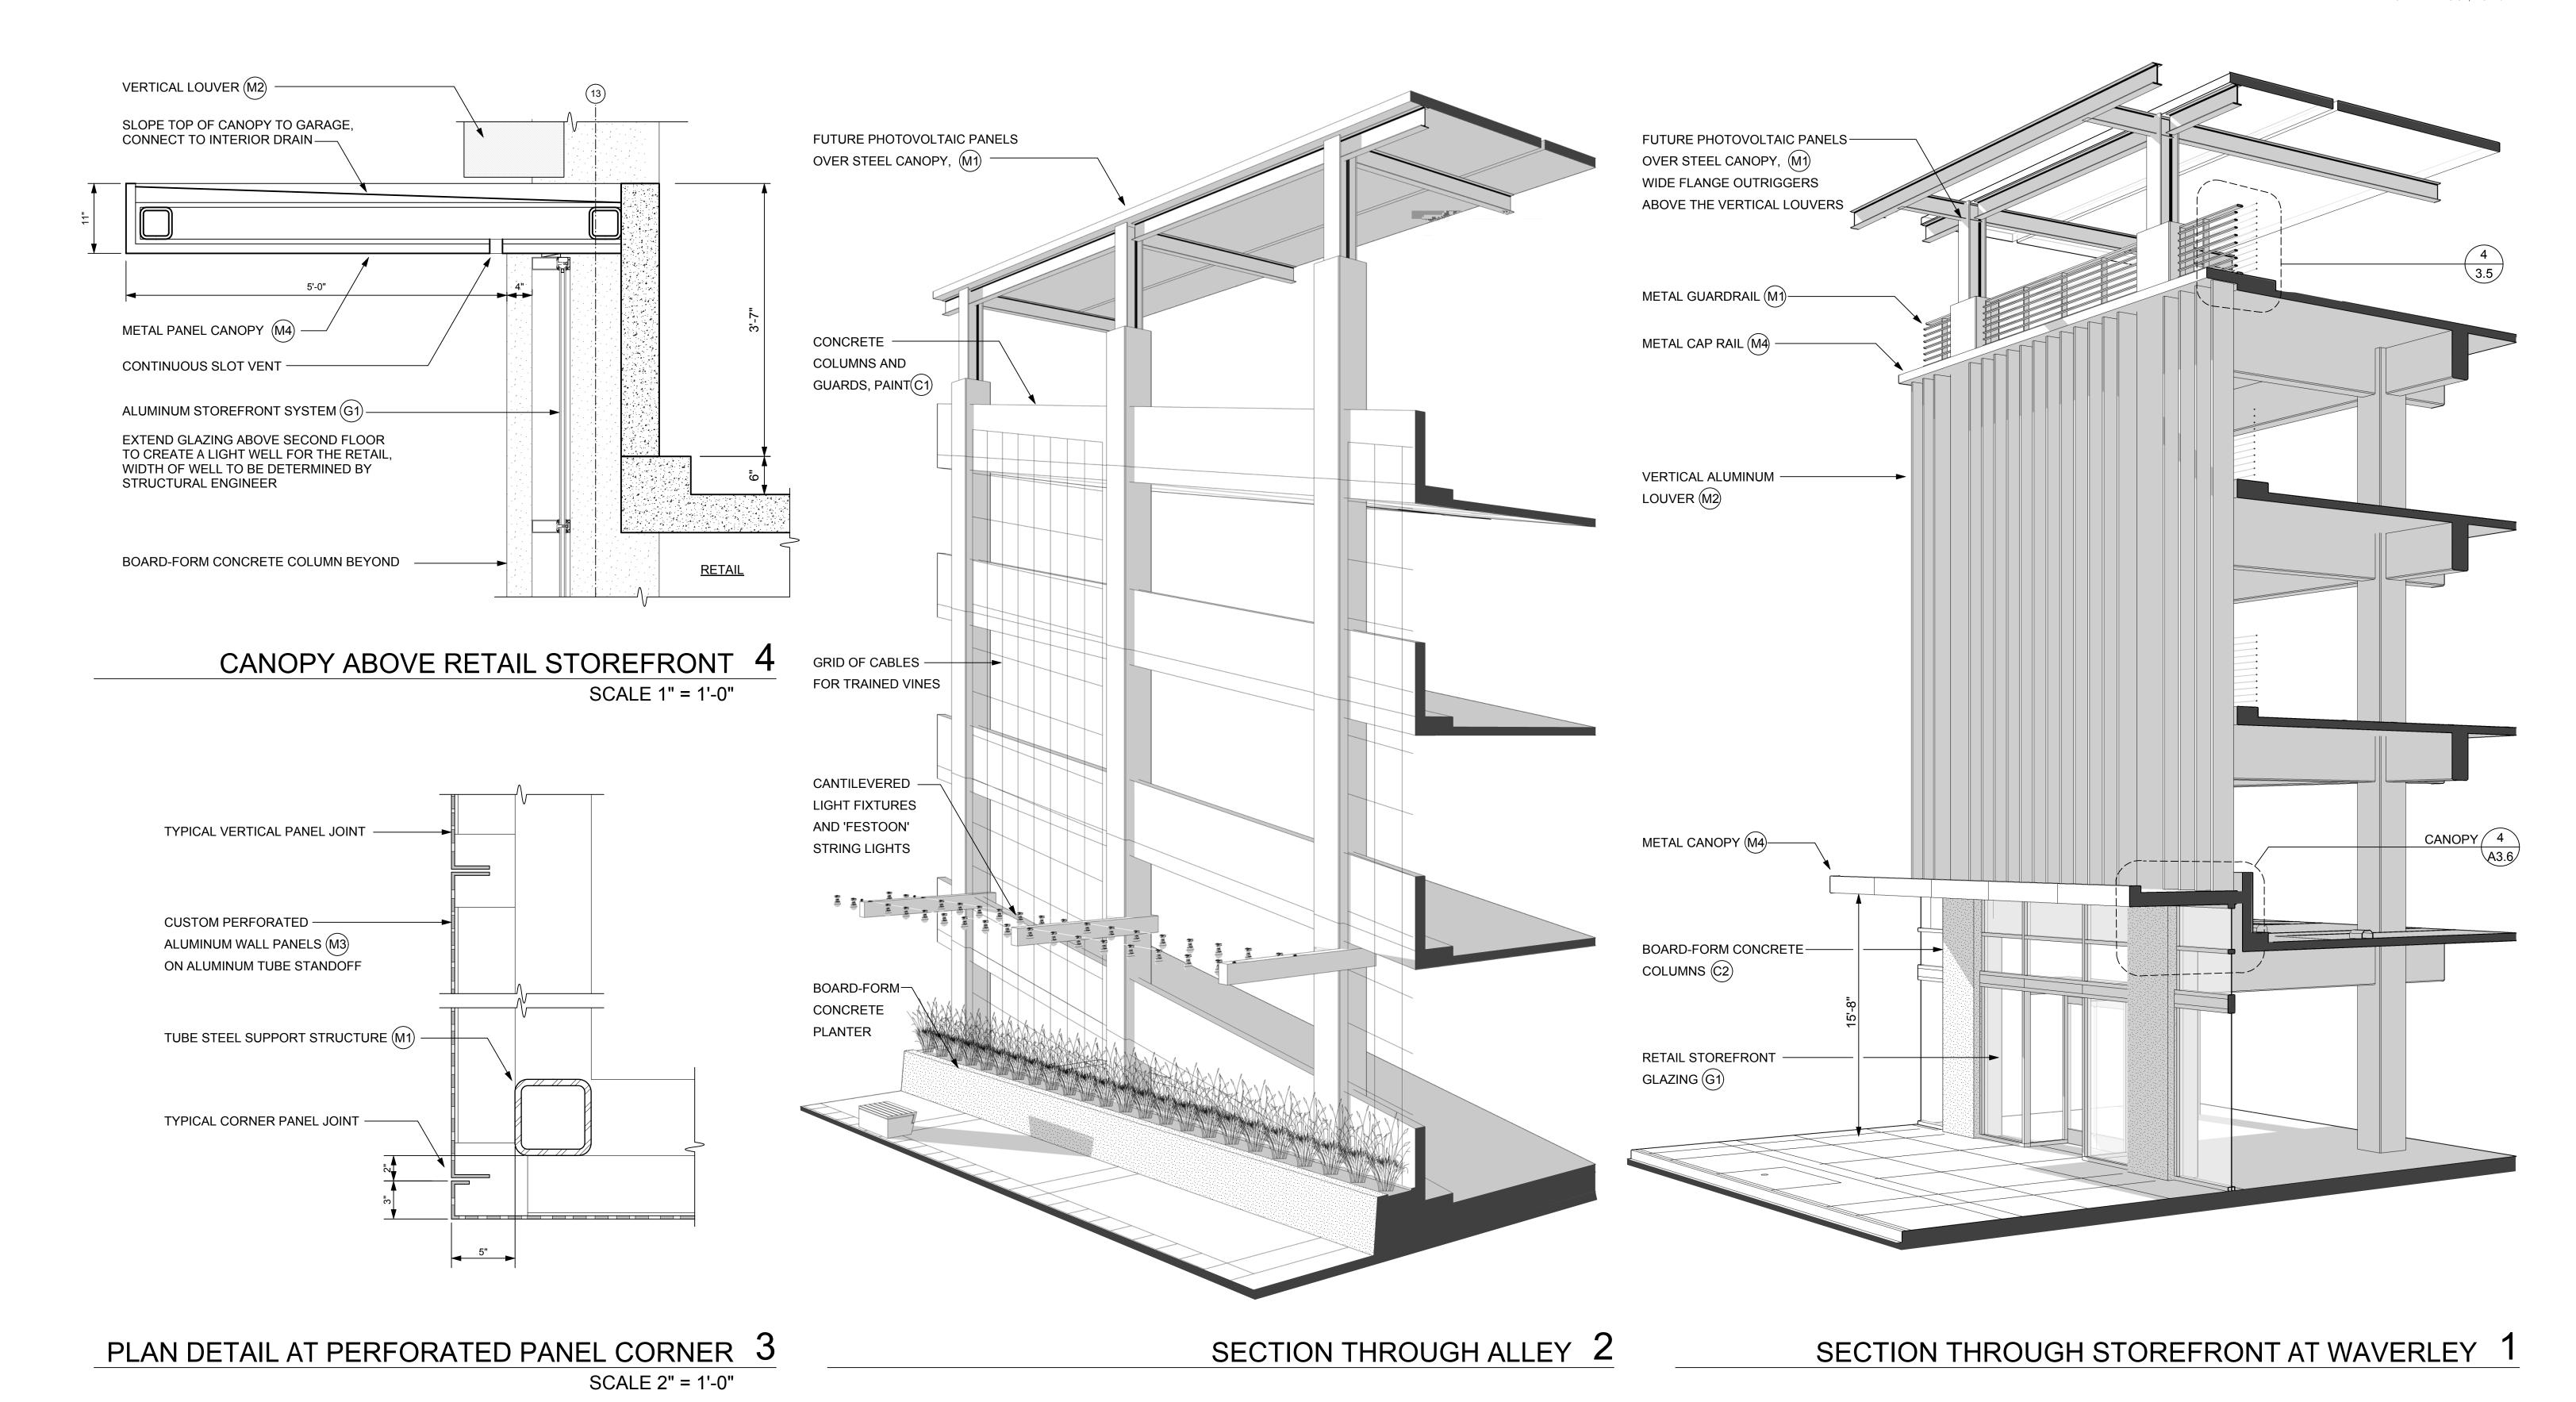







VIEW APPROACHING GARAGE ALONG HAMILTON 4



VIEW AT CORNER OF HAMILTON AND WAVERLEY 2



VIEW APPROACHING GARAGE ALONG WAVERLEY 2



VIEW OF WAVERLEY FACADE AND PEDESTRIAN ALLEY 1

DOWNTOWN PARKING GARAGE





VIEW OF BIKE STORAGE AREA WITHIN GARAGE 2



VIEW OF VEHICLE, BIKE AND PEDESTRIAN ENTRY 3




EYE HEIGHT VIEW AT CORNER PLAZA 1

DOWNTOWN PARKING GARAGE

SHEET NAME:




VIEW OF GARAGE AND SERVICE ALLEY FROM LANE 21 3

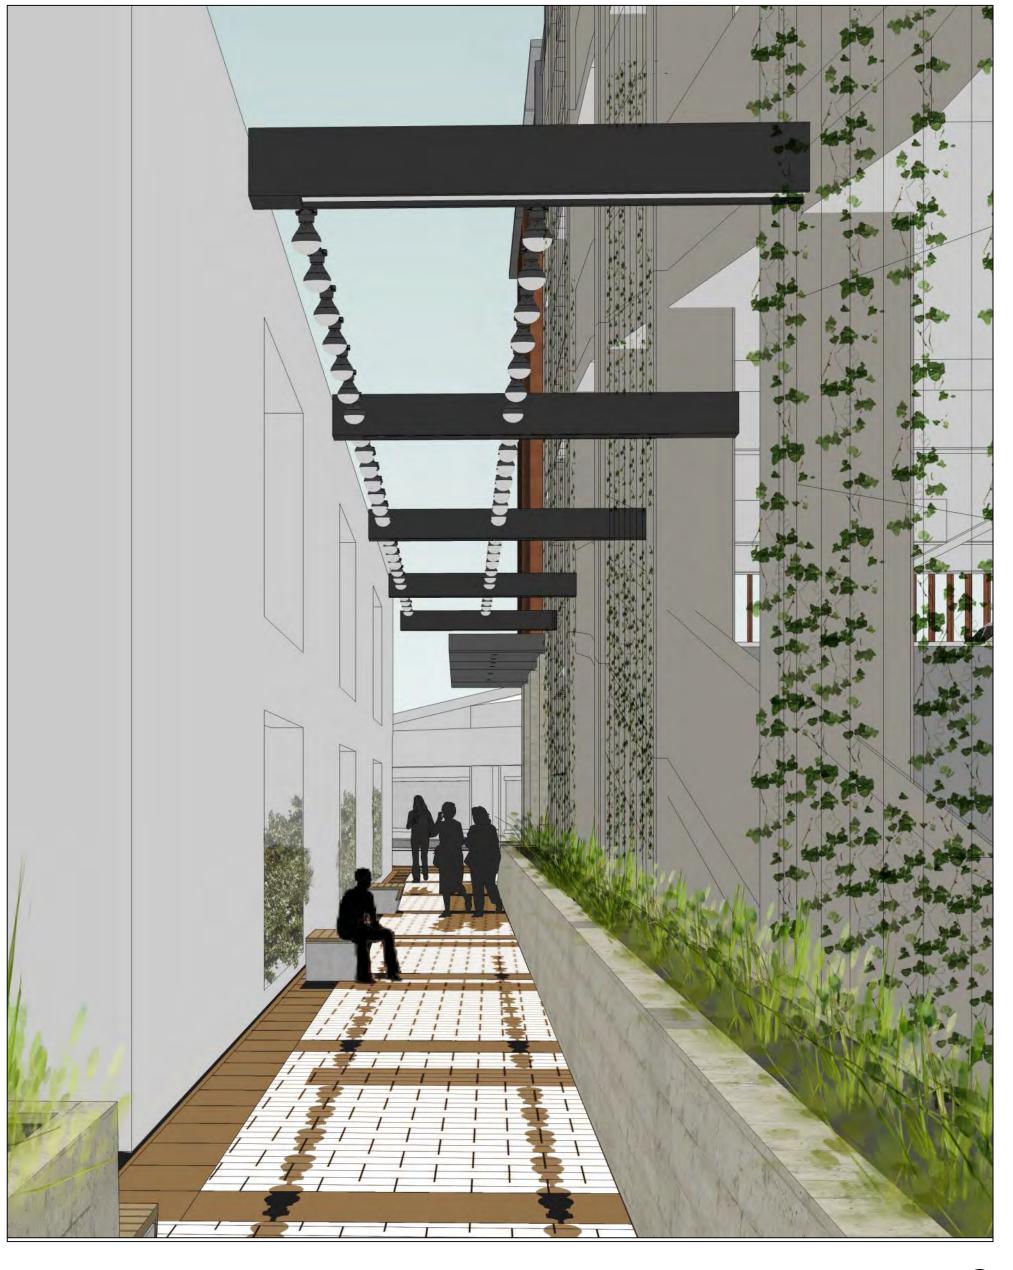


VIEW OF WAVERLEY ST. FROM PEDESTRIAN ALLEY 2





VIEW OF PEDESTRIAN ALLEY FROM WAVERLEY ST. 1

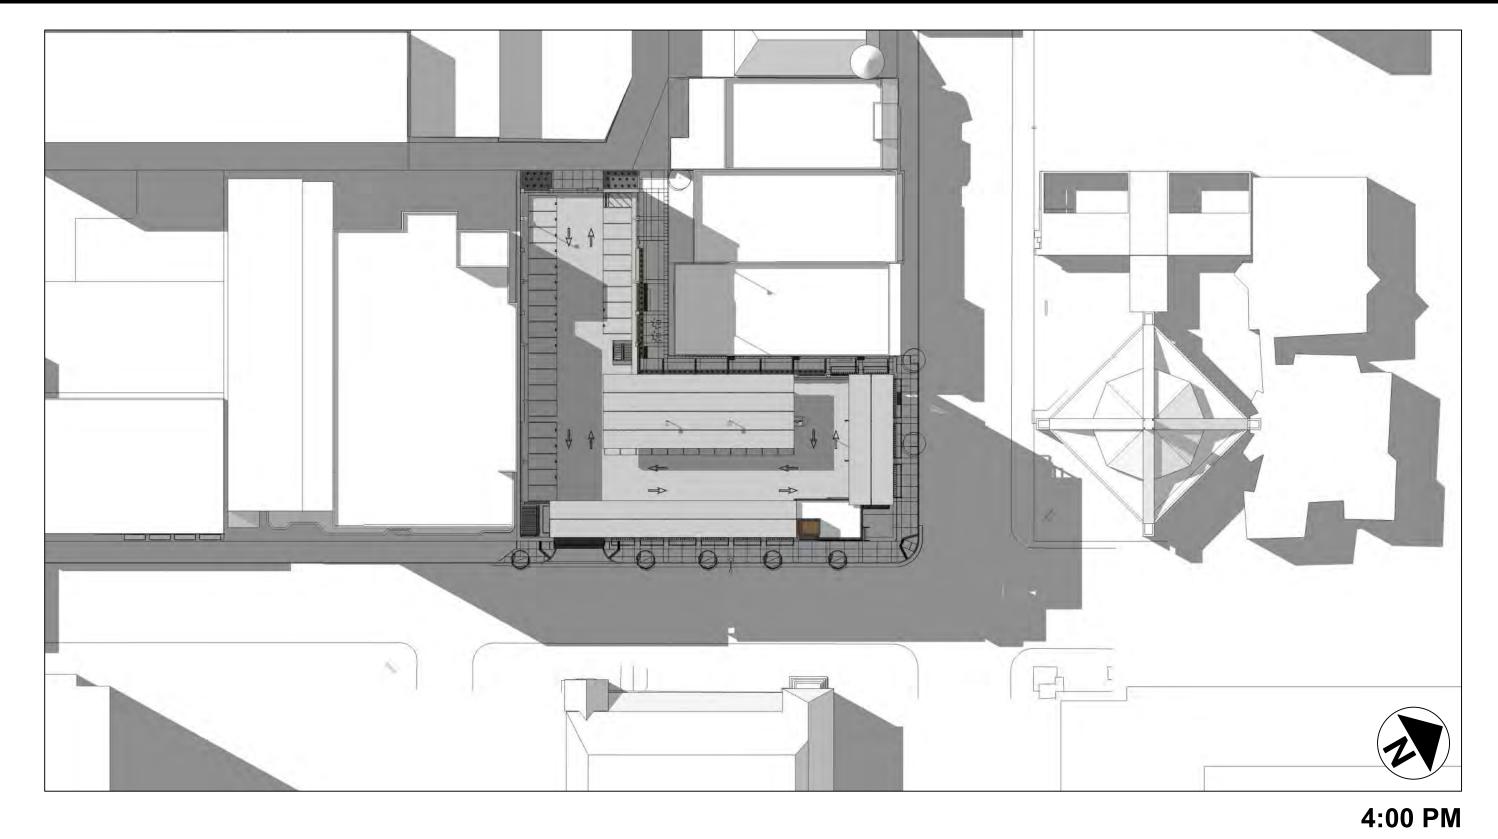

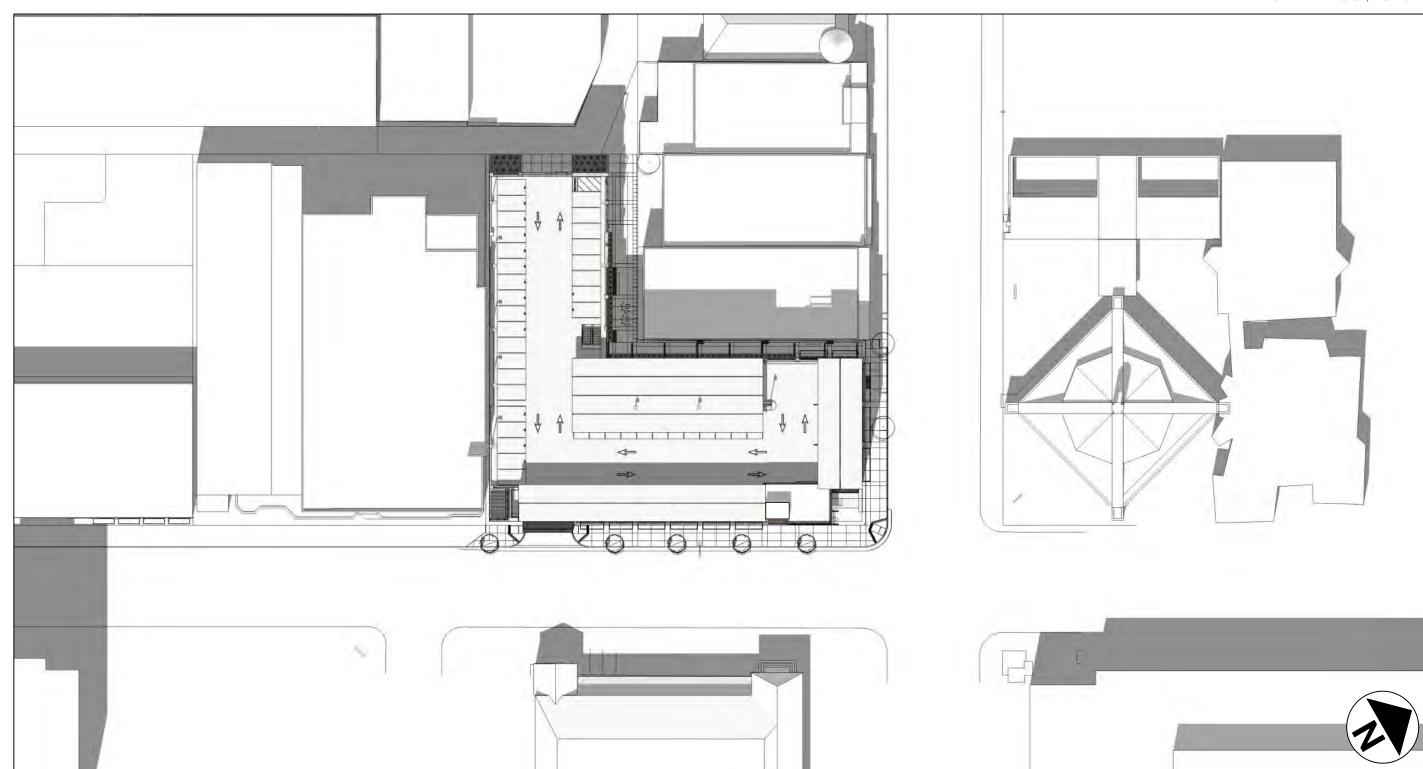

10:30 AM

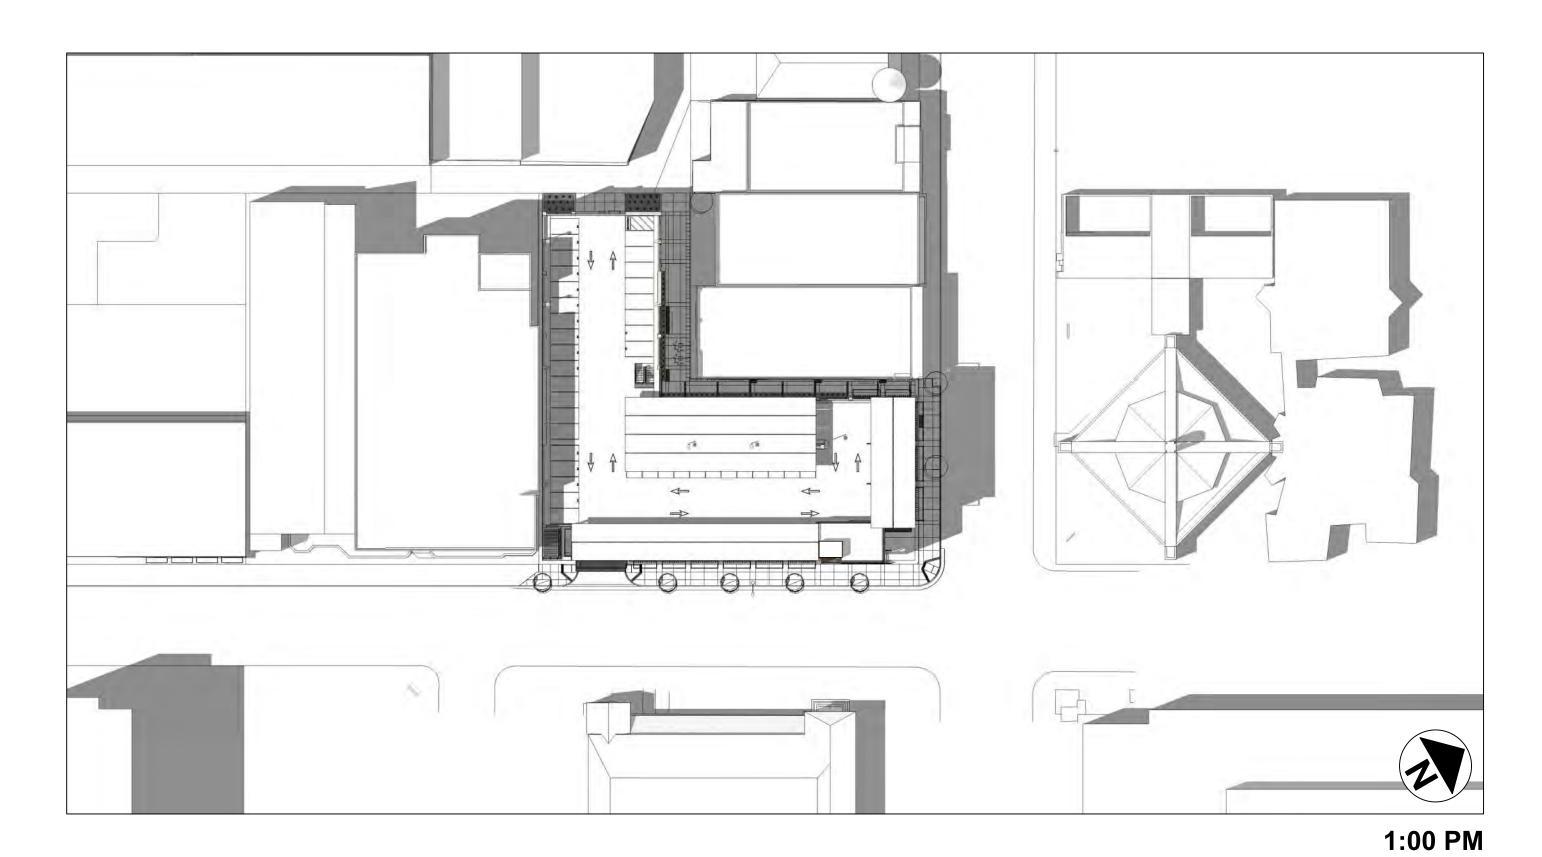


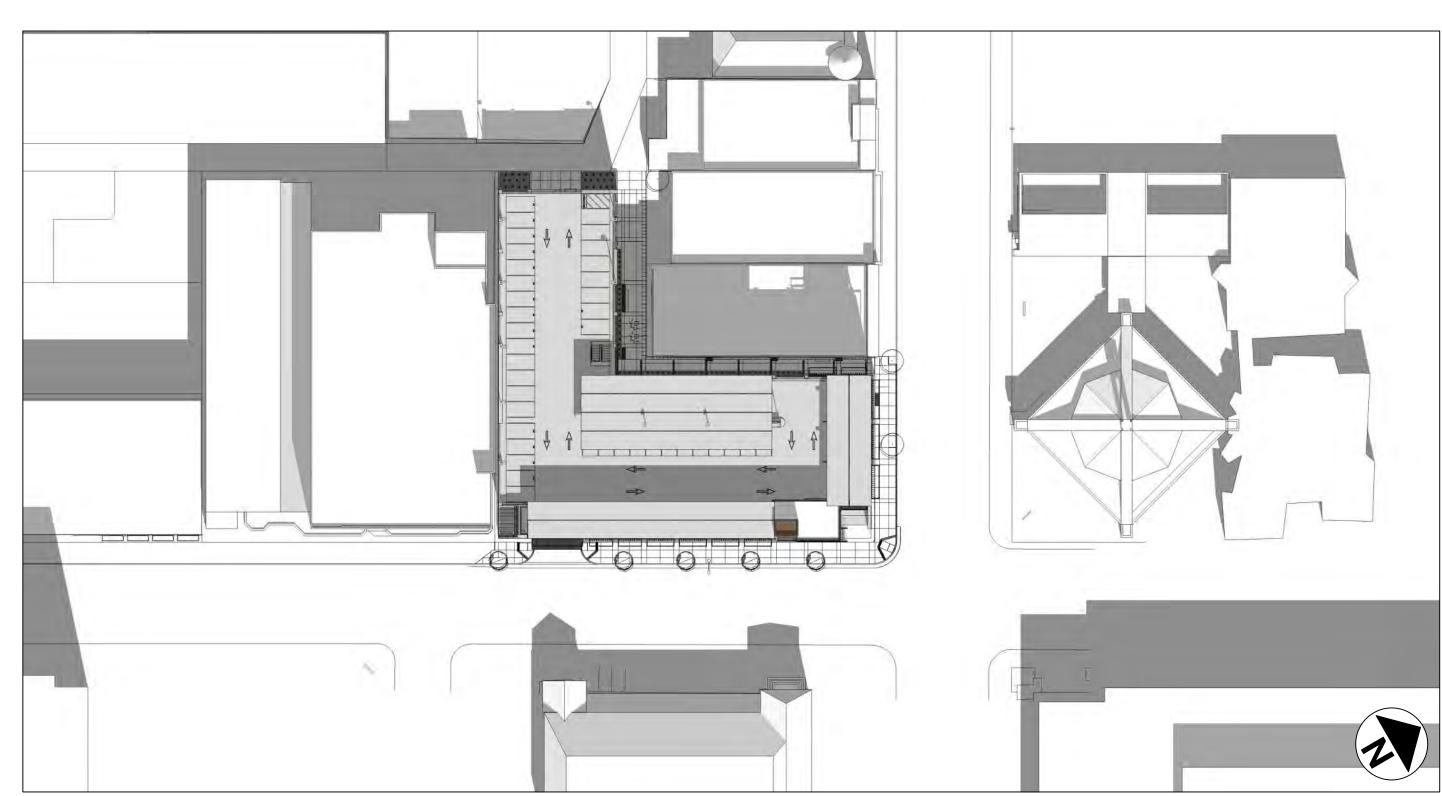


SHEET NAME:

MARCH 21ST GARAGE SHOWN WITH PHOTOVOLTAIC PANELS


9:00 AM

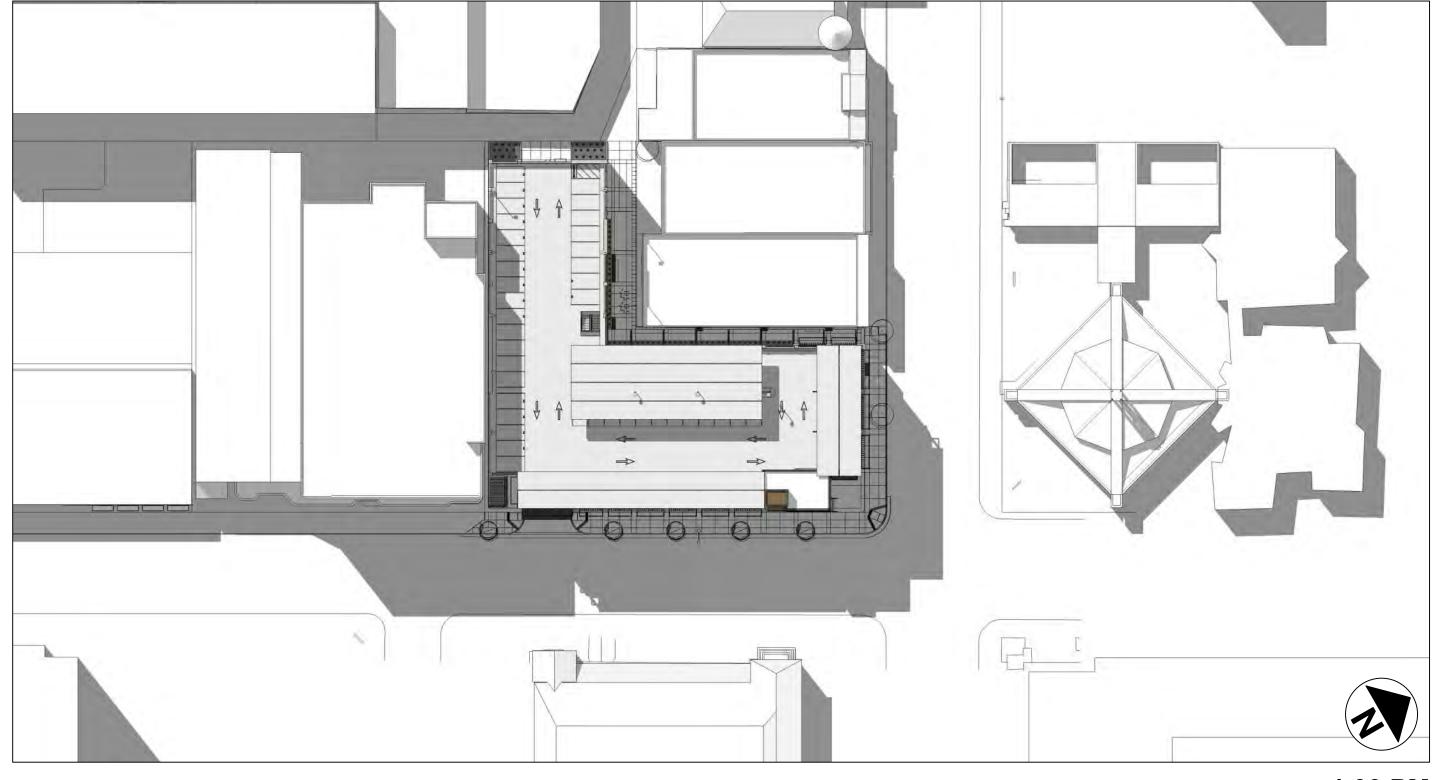


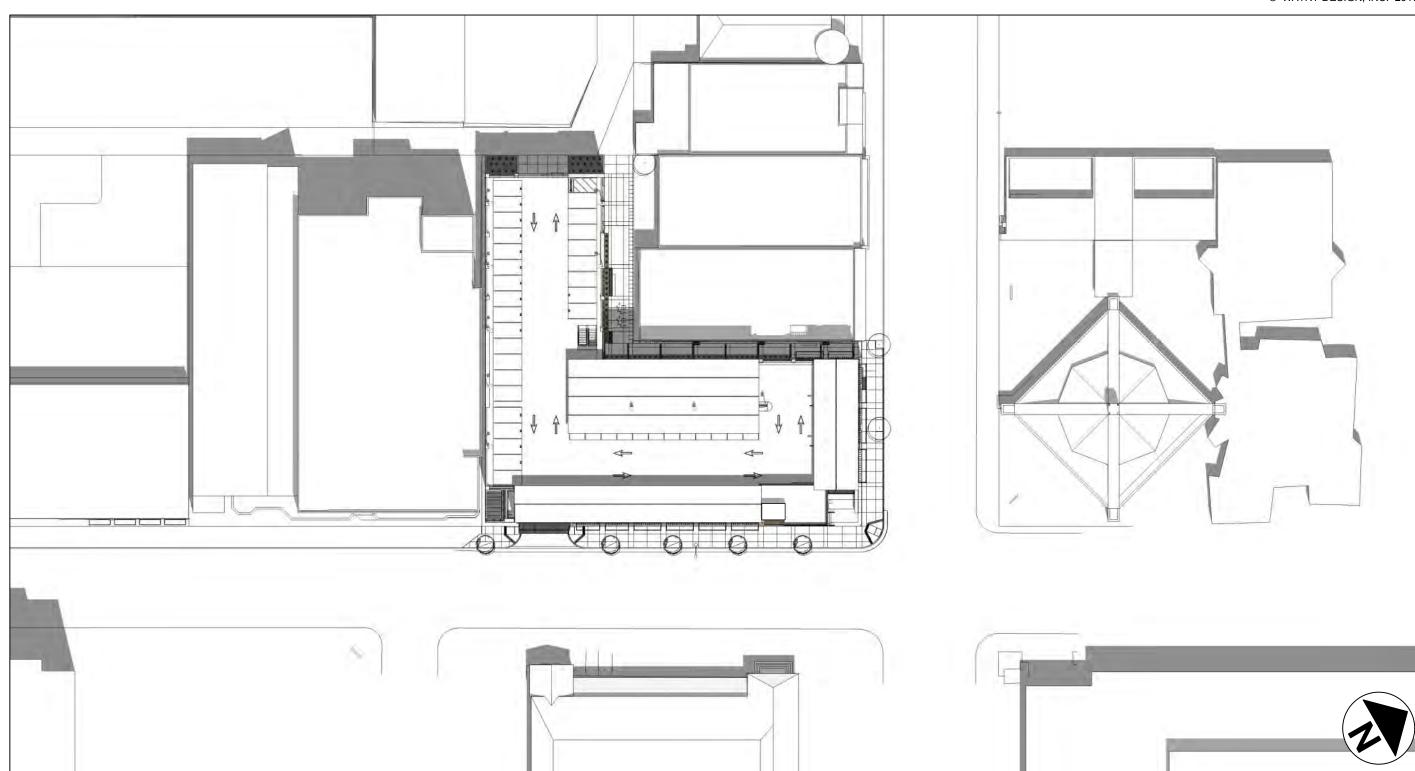


4:00 PM

10:30 AM

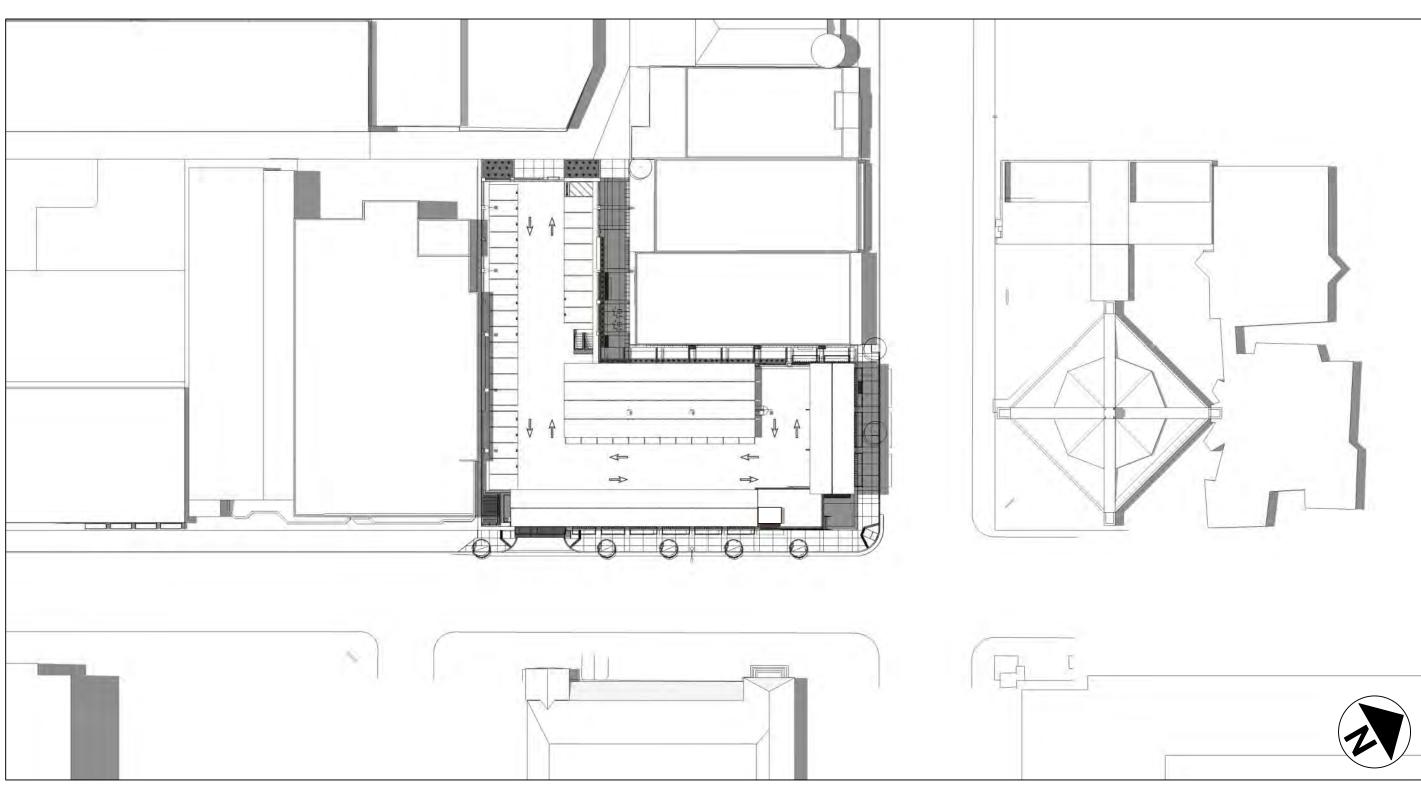

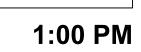

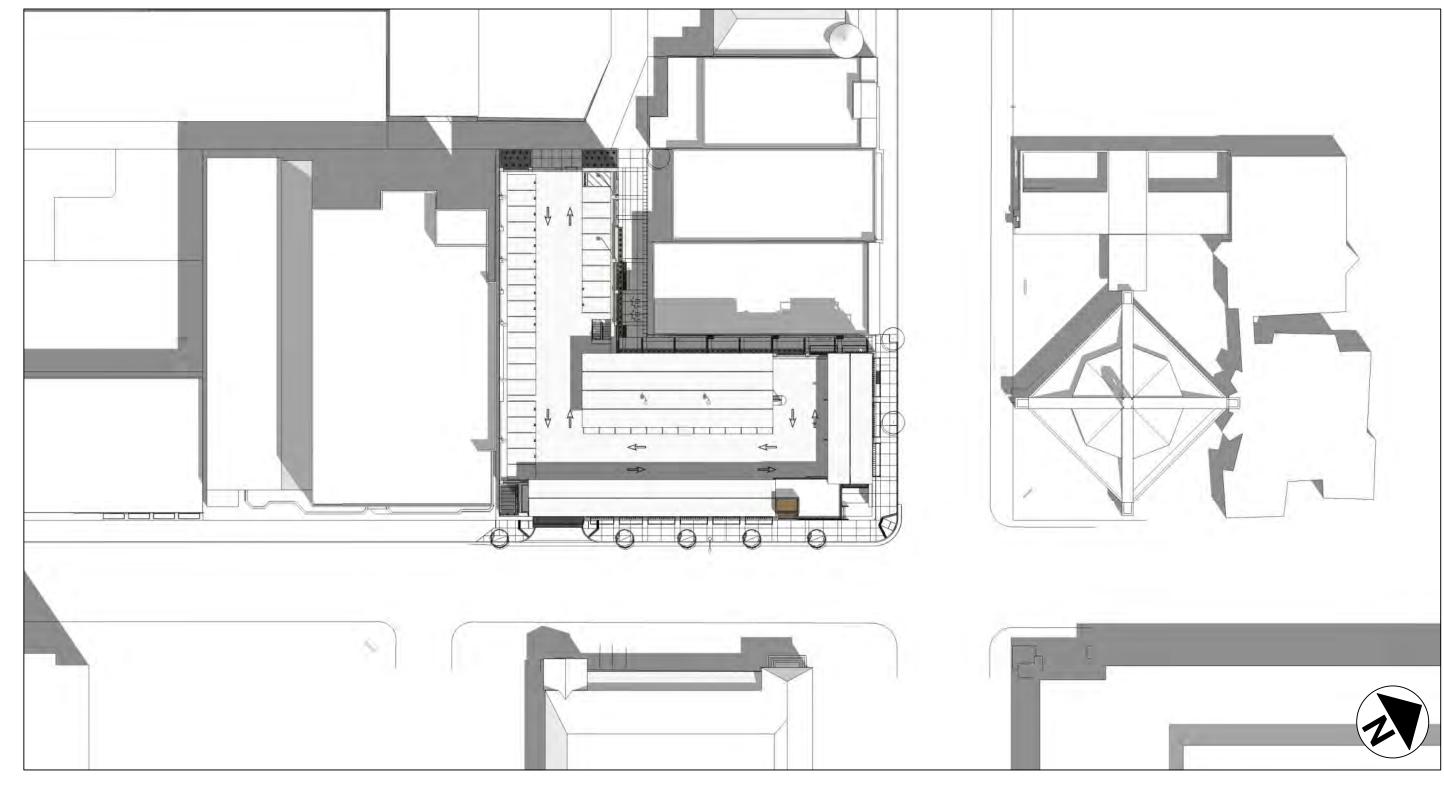



9:00 AM JUNE 21ST

GARAGE SHOWN WITH PHOTOVOLTAIC PANELS

DOWNTOWN PARKING GARAGE


SHEET NAME:

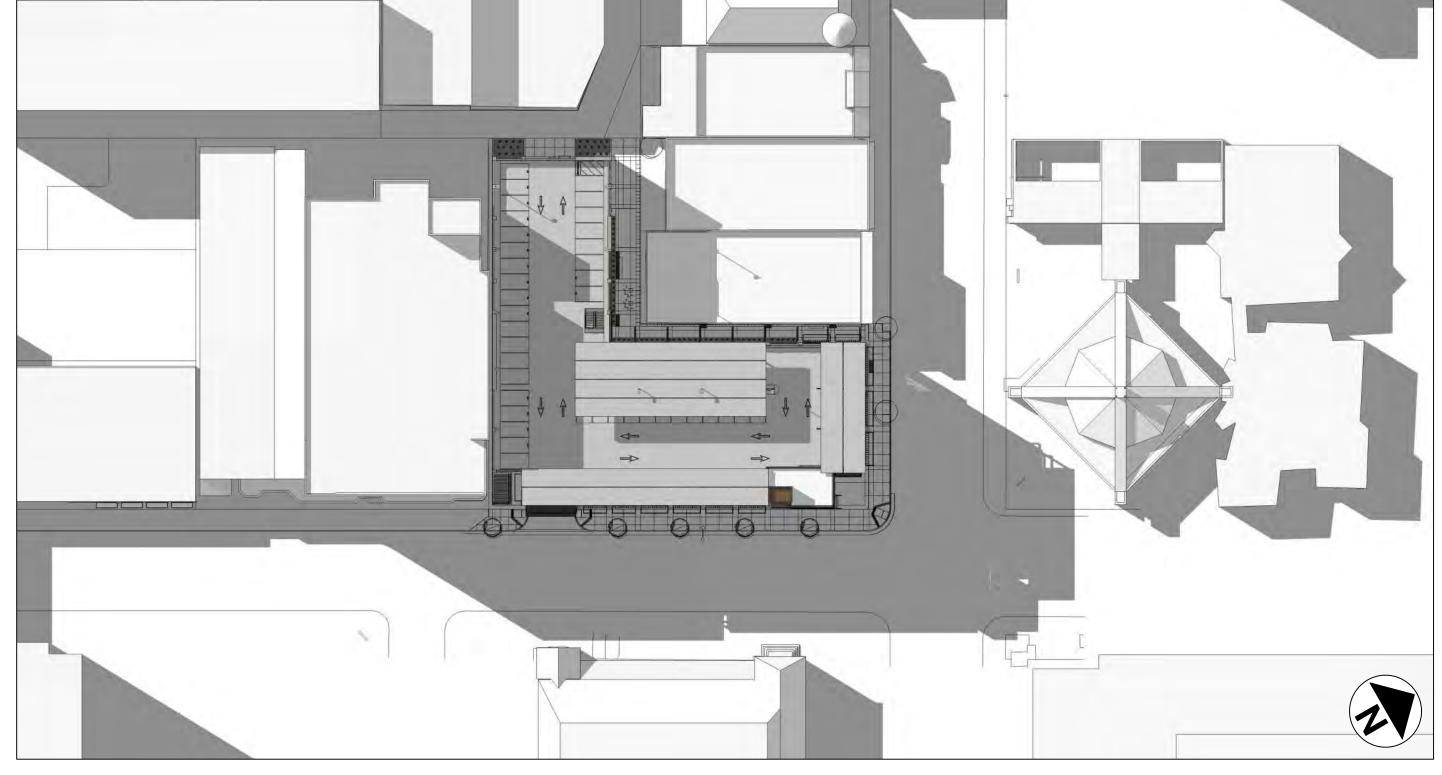

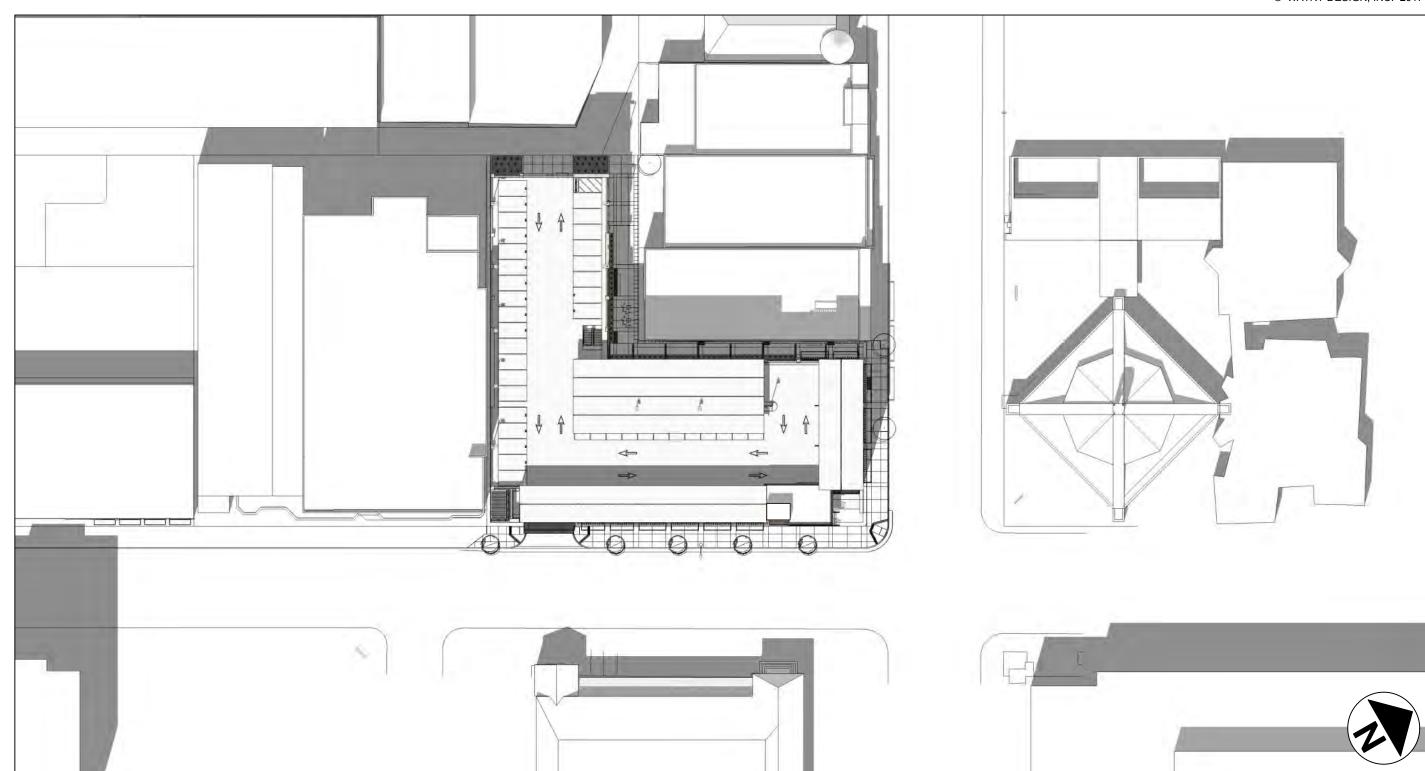


4:00 PM

10:30 AM

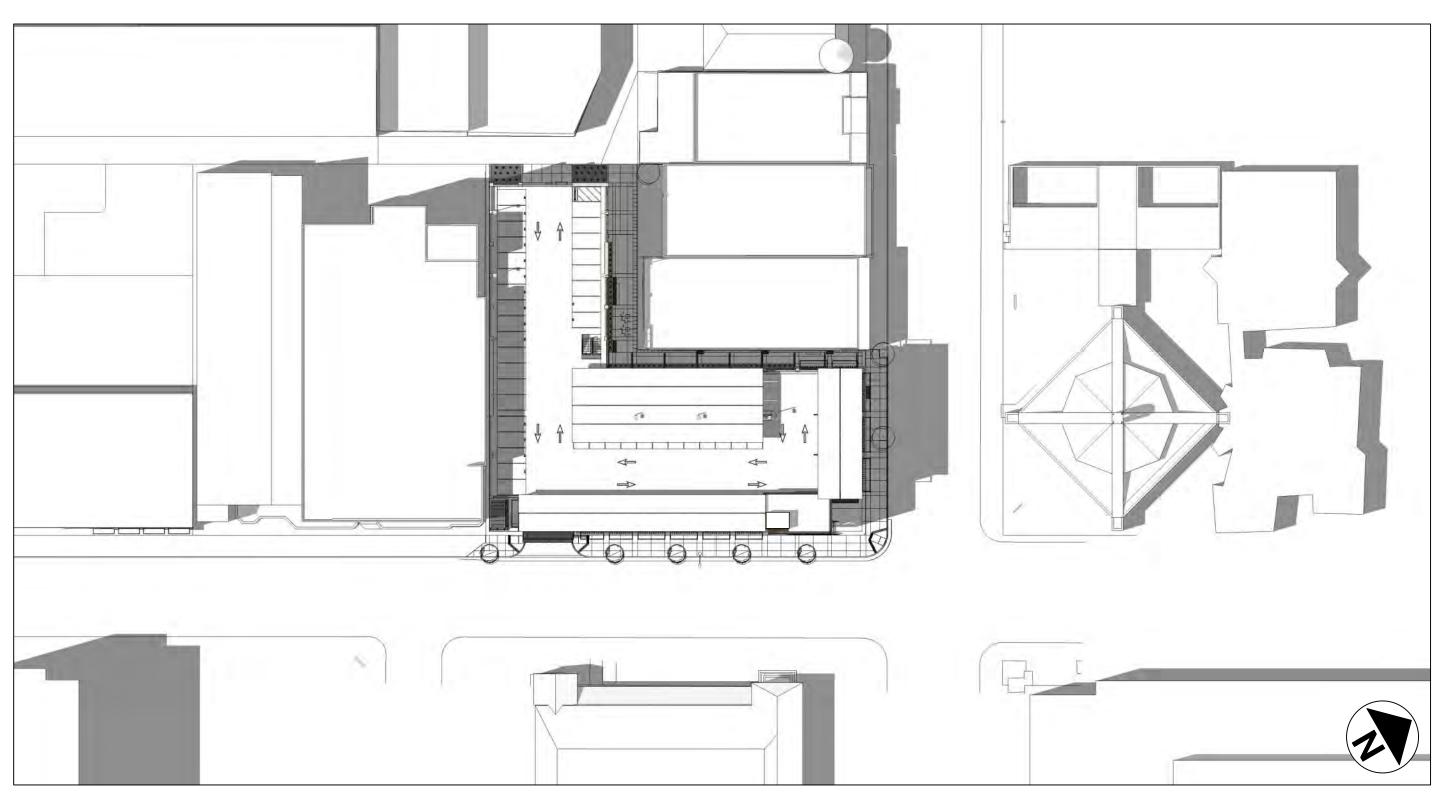


1:00 PM

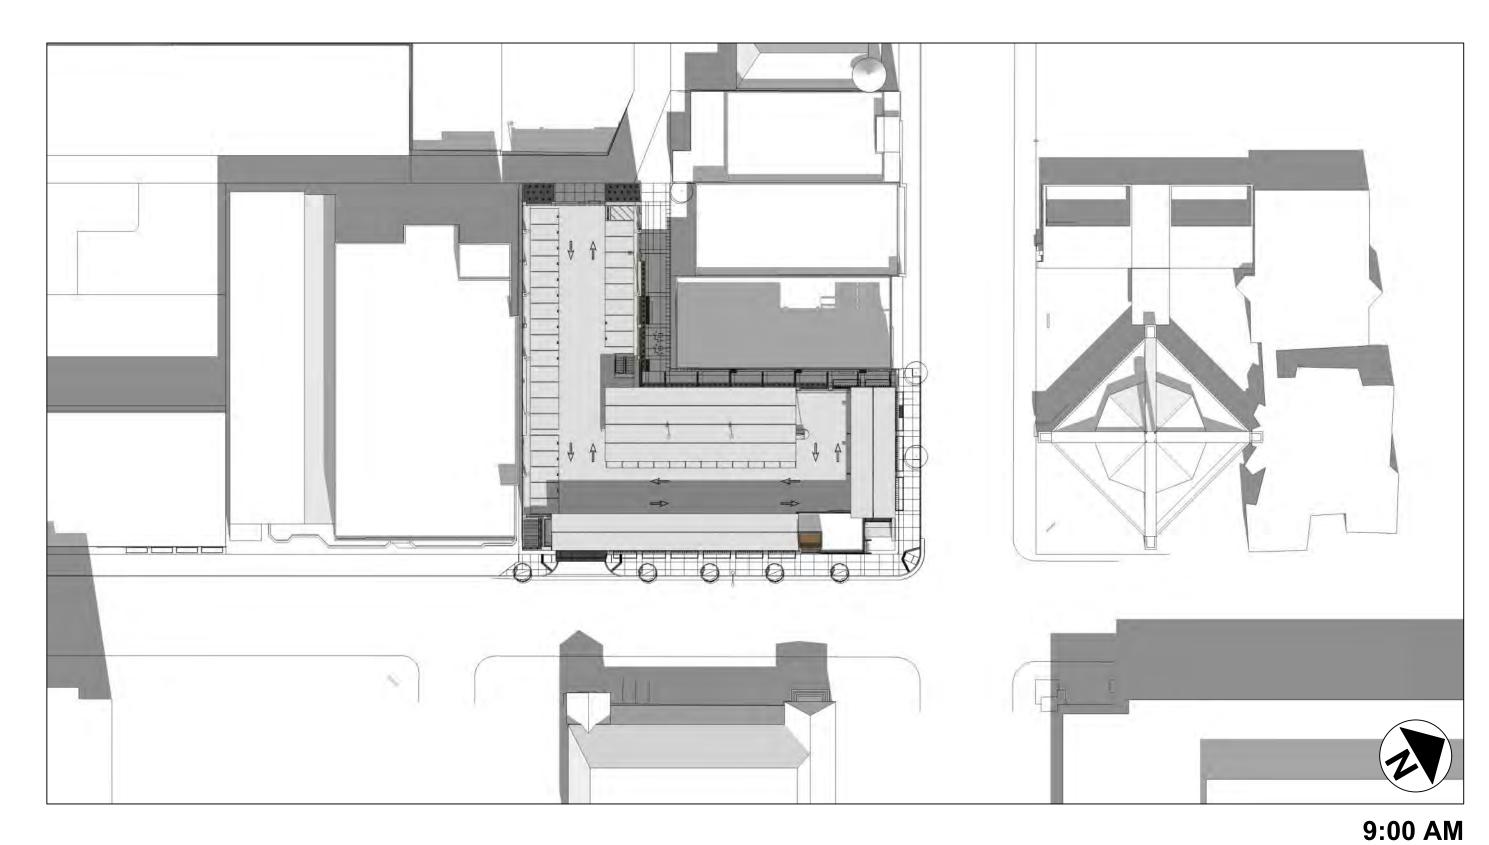


SEPTEMBER 21ST

GARAGE SHOWN WITH PHOTOVOLTAIC PANELS


SHEET NAME:

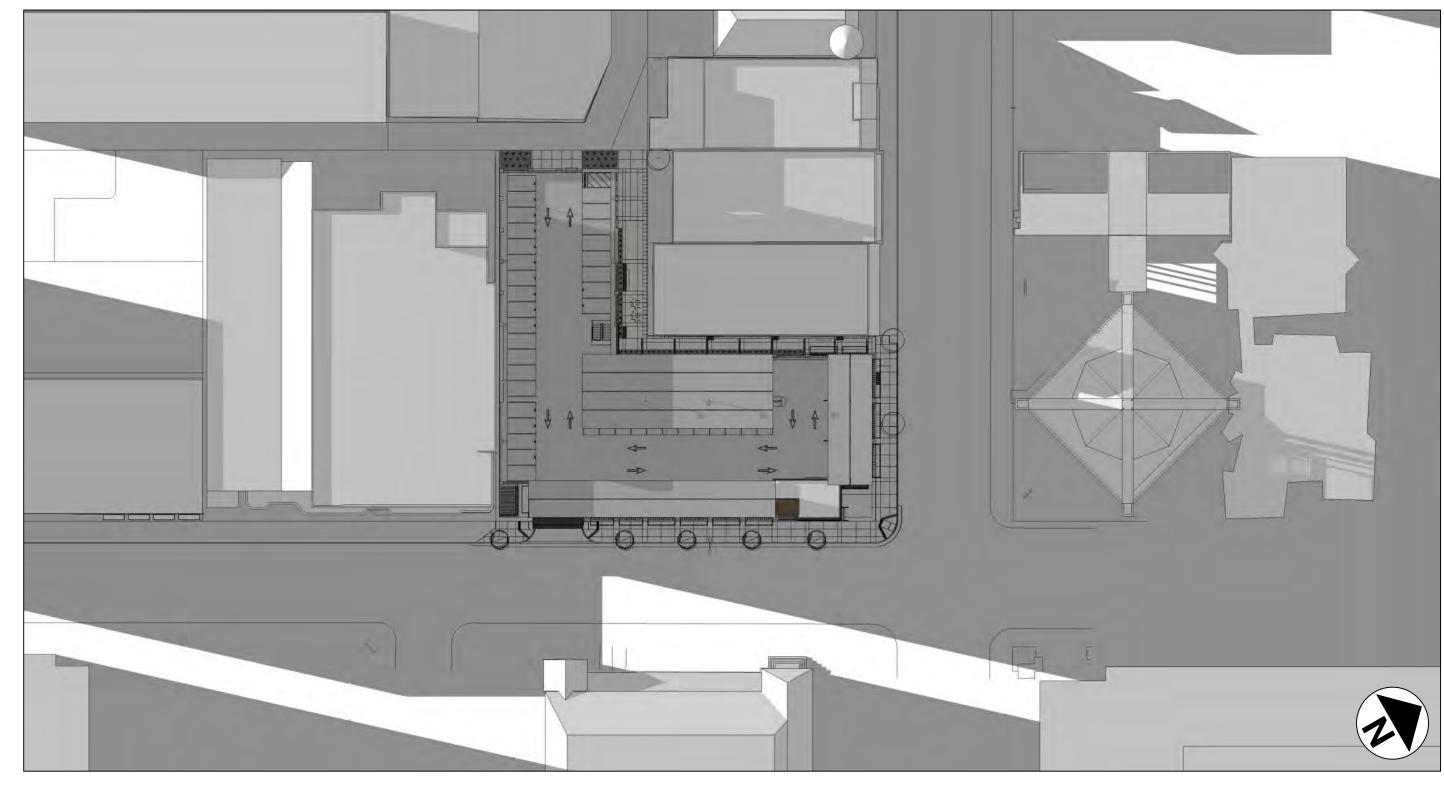

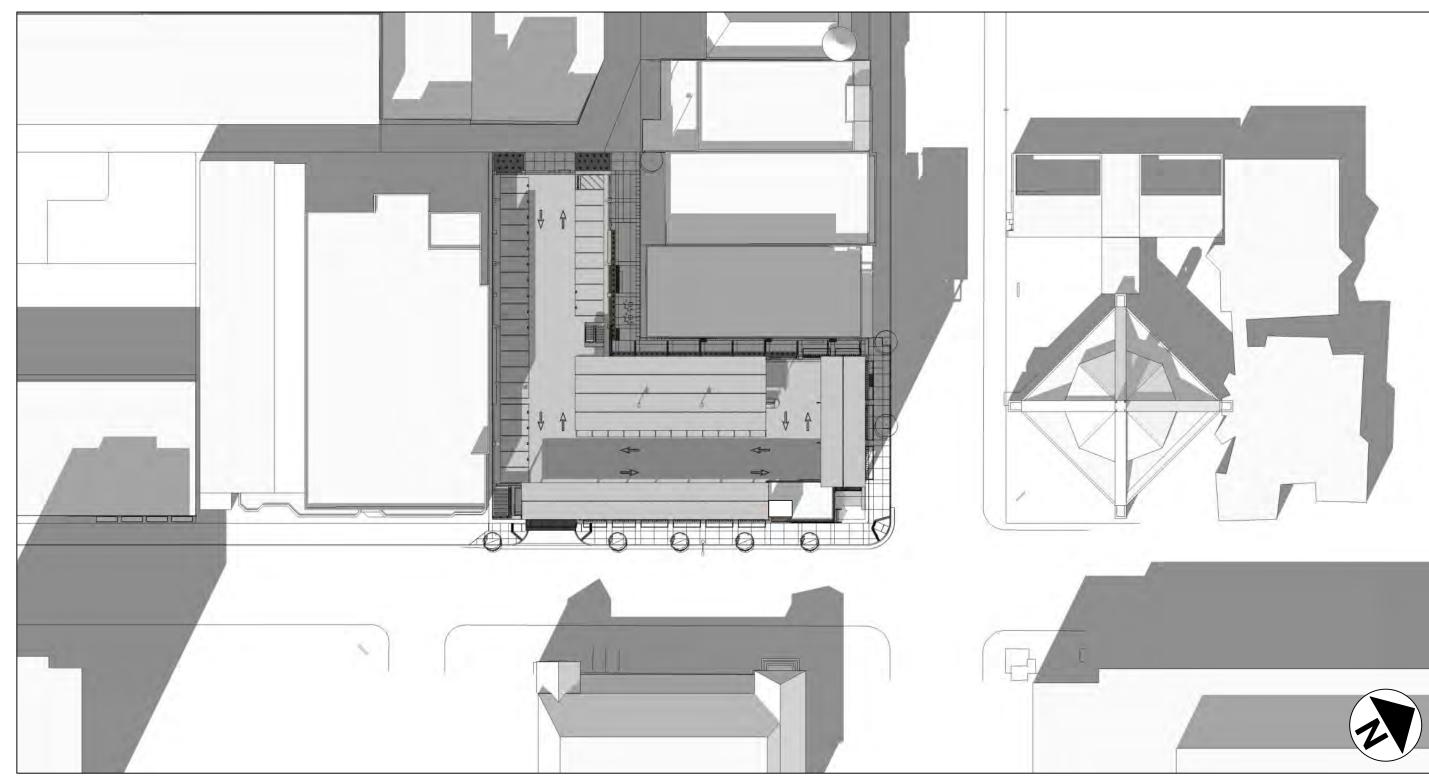


4:00 PM

10:30 AM

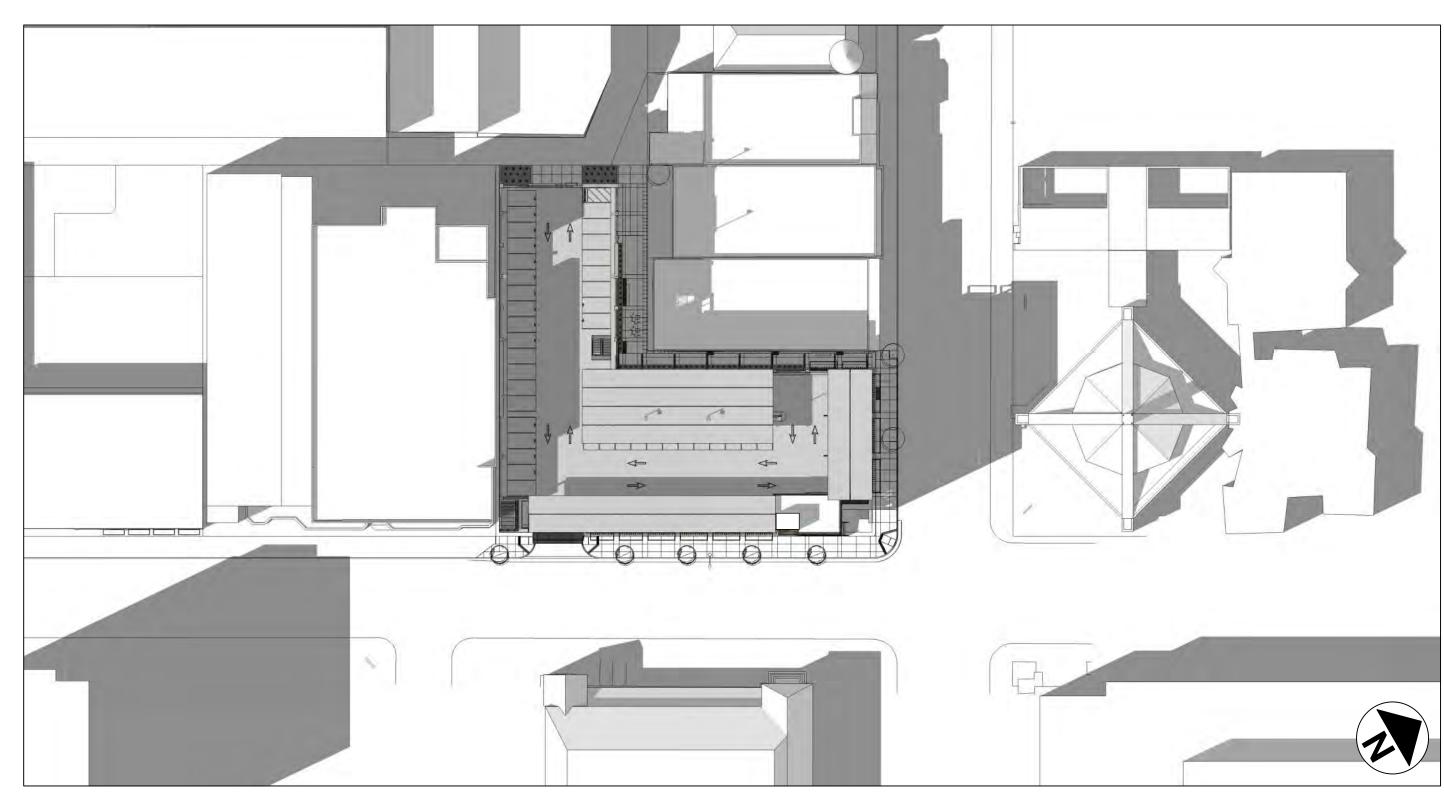


1:00 PM

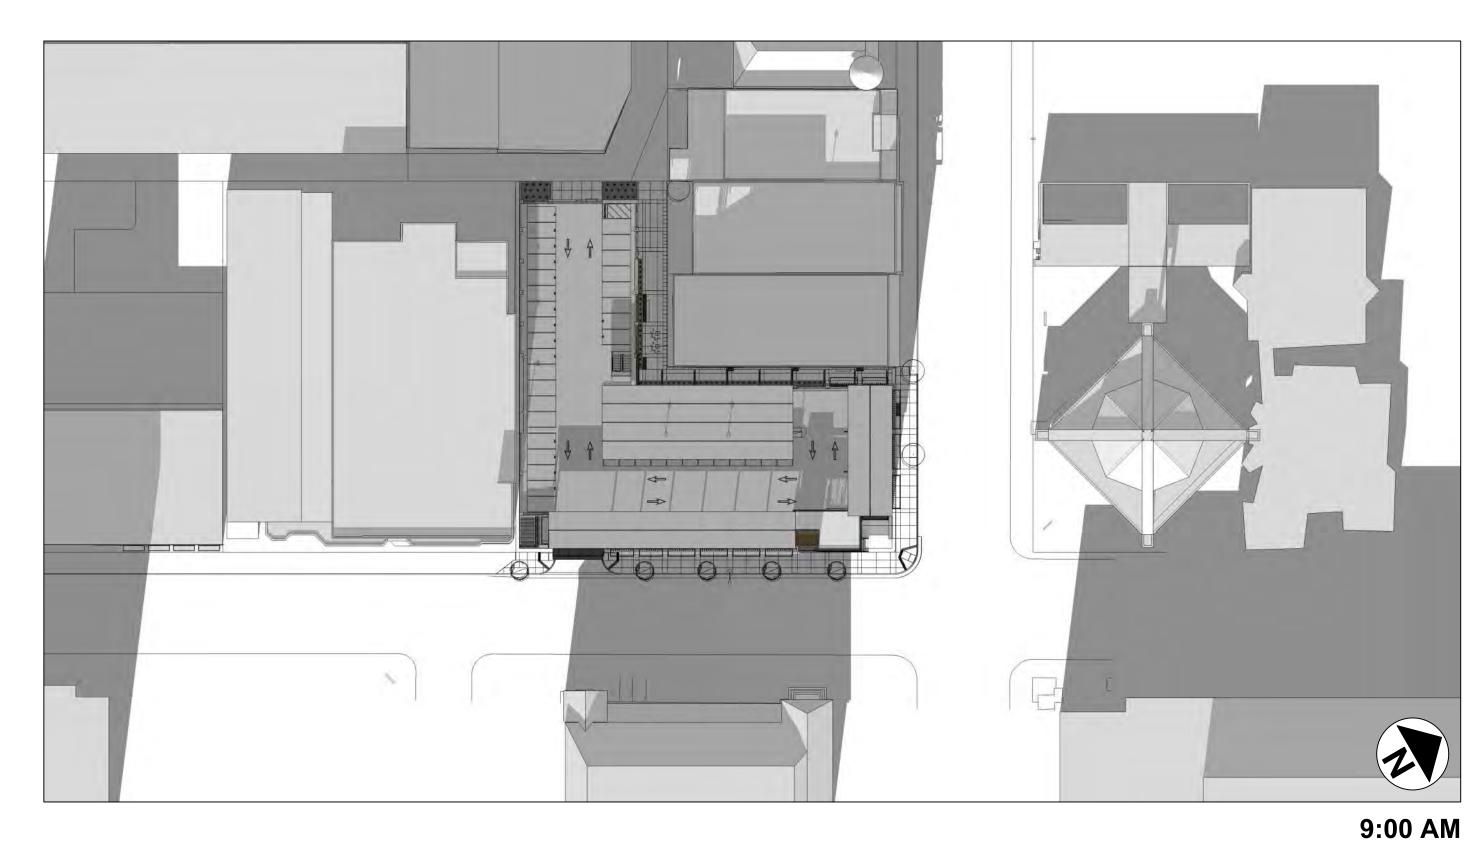


DECEMBER 21ST GARAGE SHOWN WITH PHOTOVOLTAIC PANELS




10:30 AM

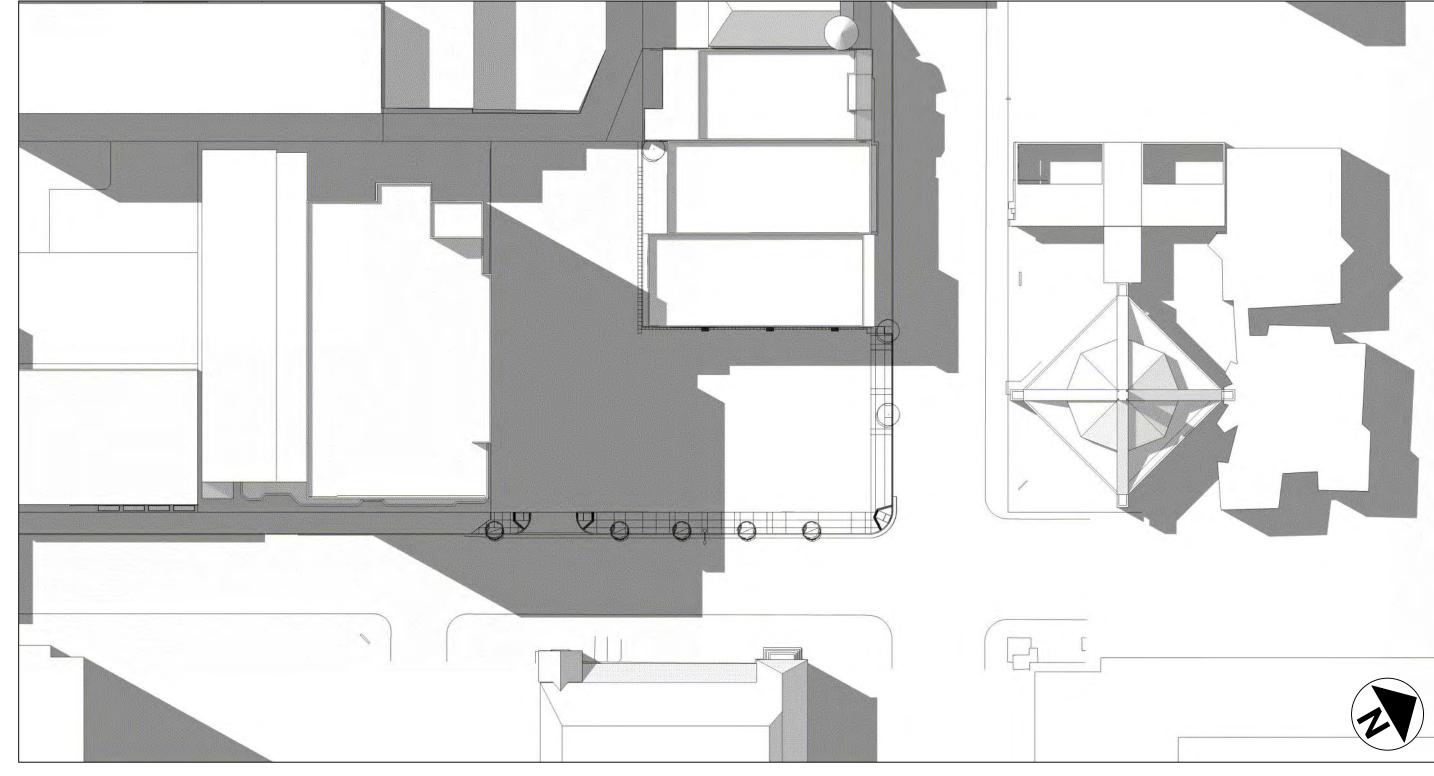


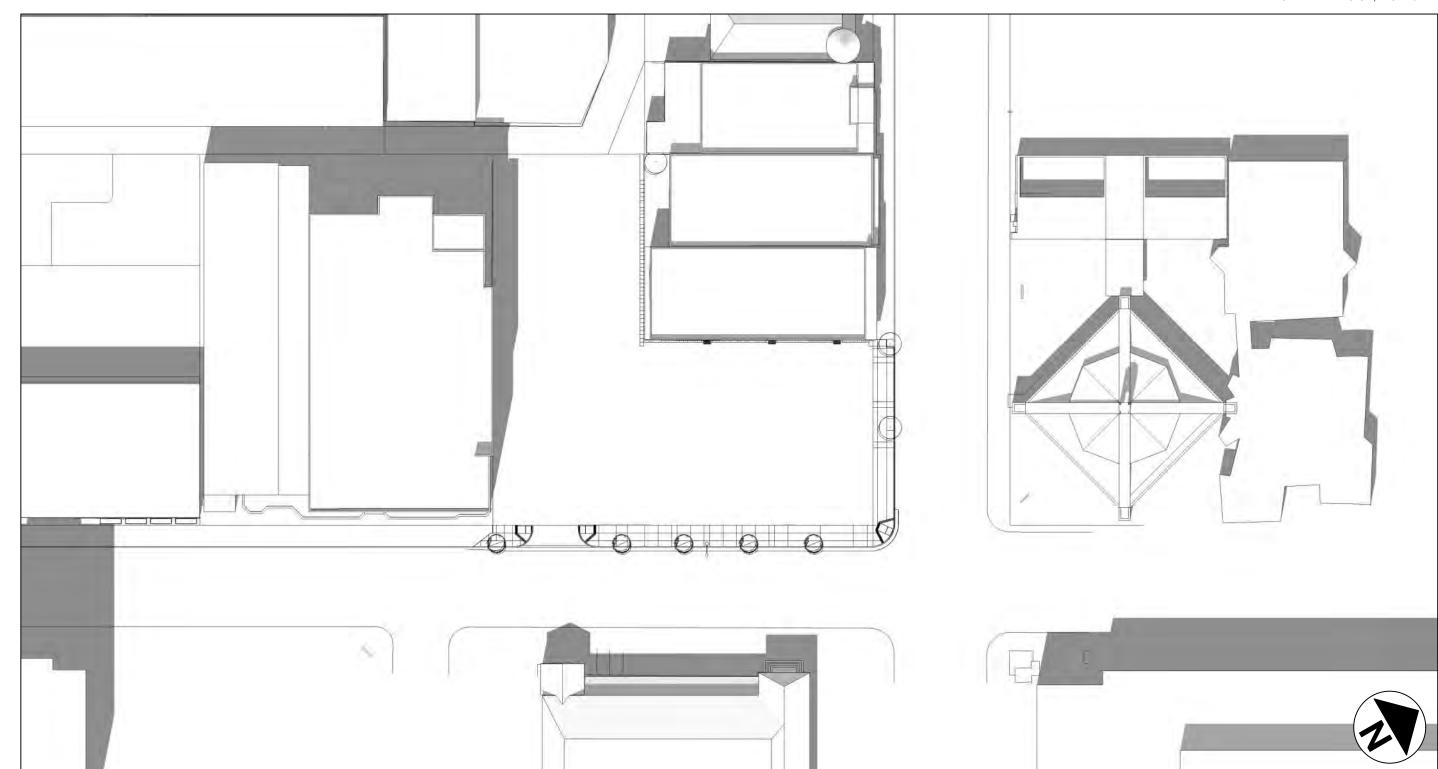

4:00 PM

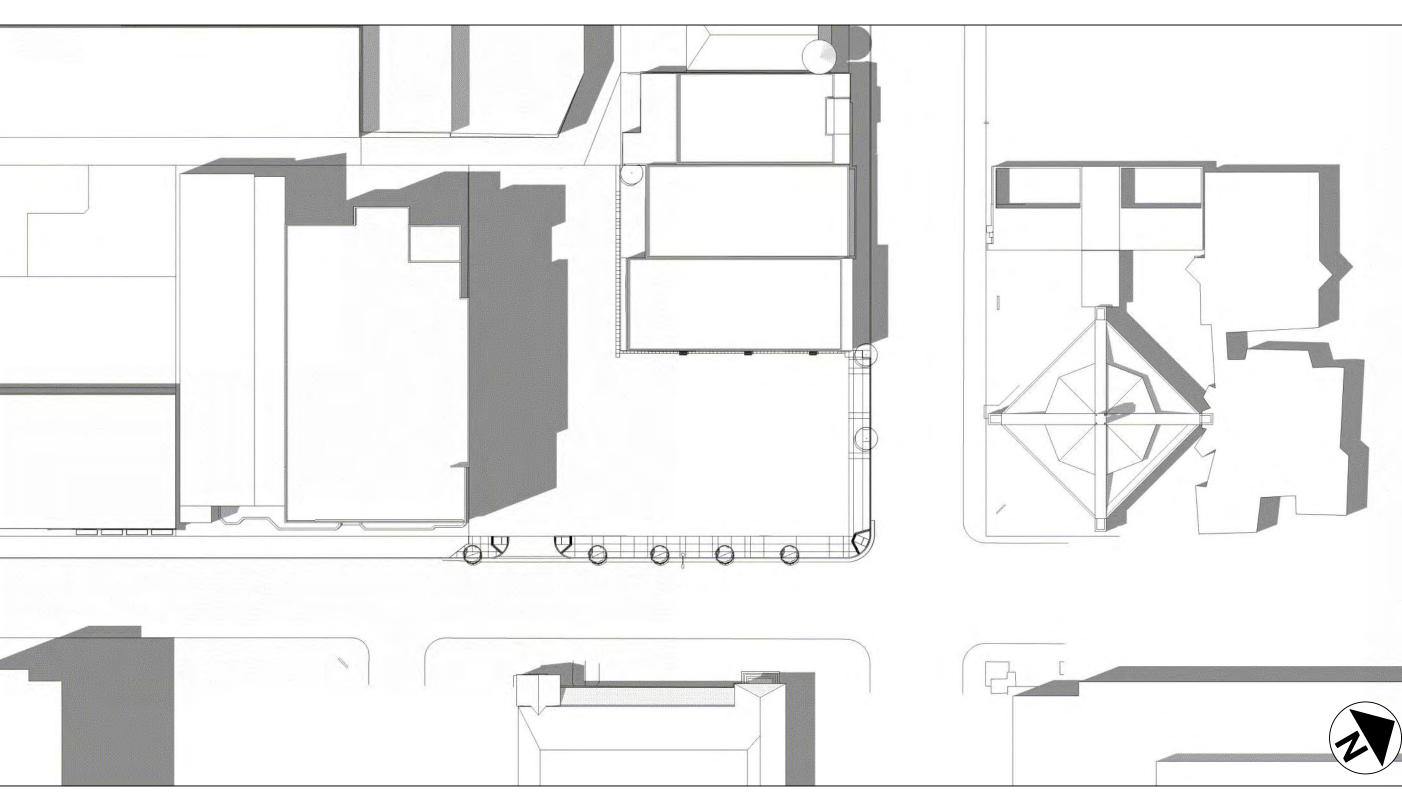


1:00 PM

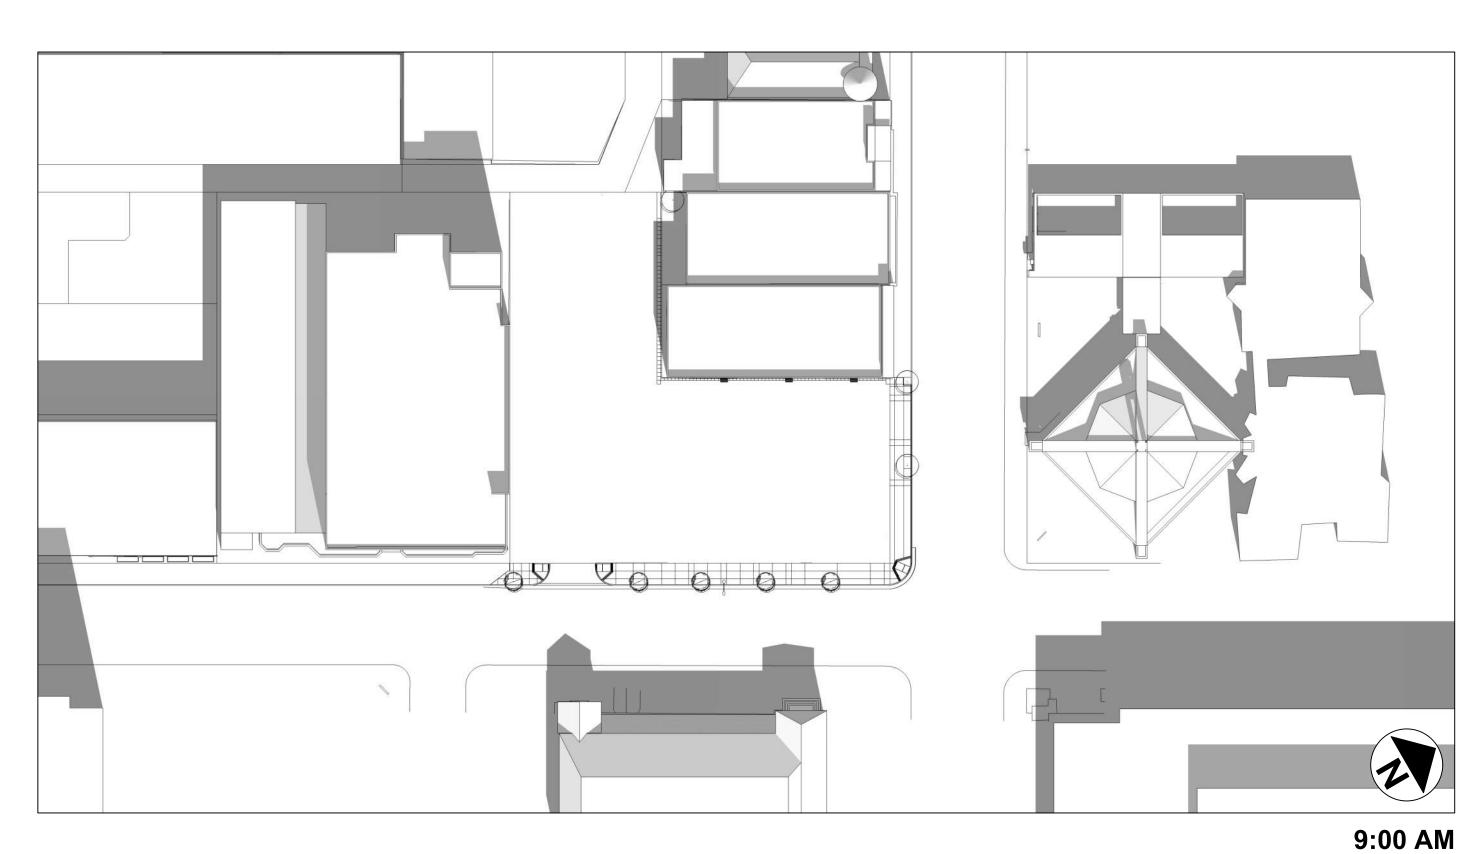


MARCH 21ST


EXISTING CONDITION (AT GRADE PARKING LOT)

10:30 AM

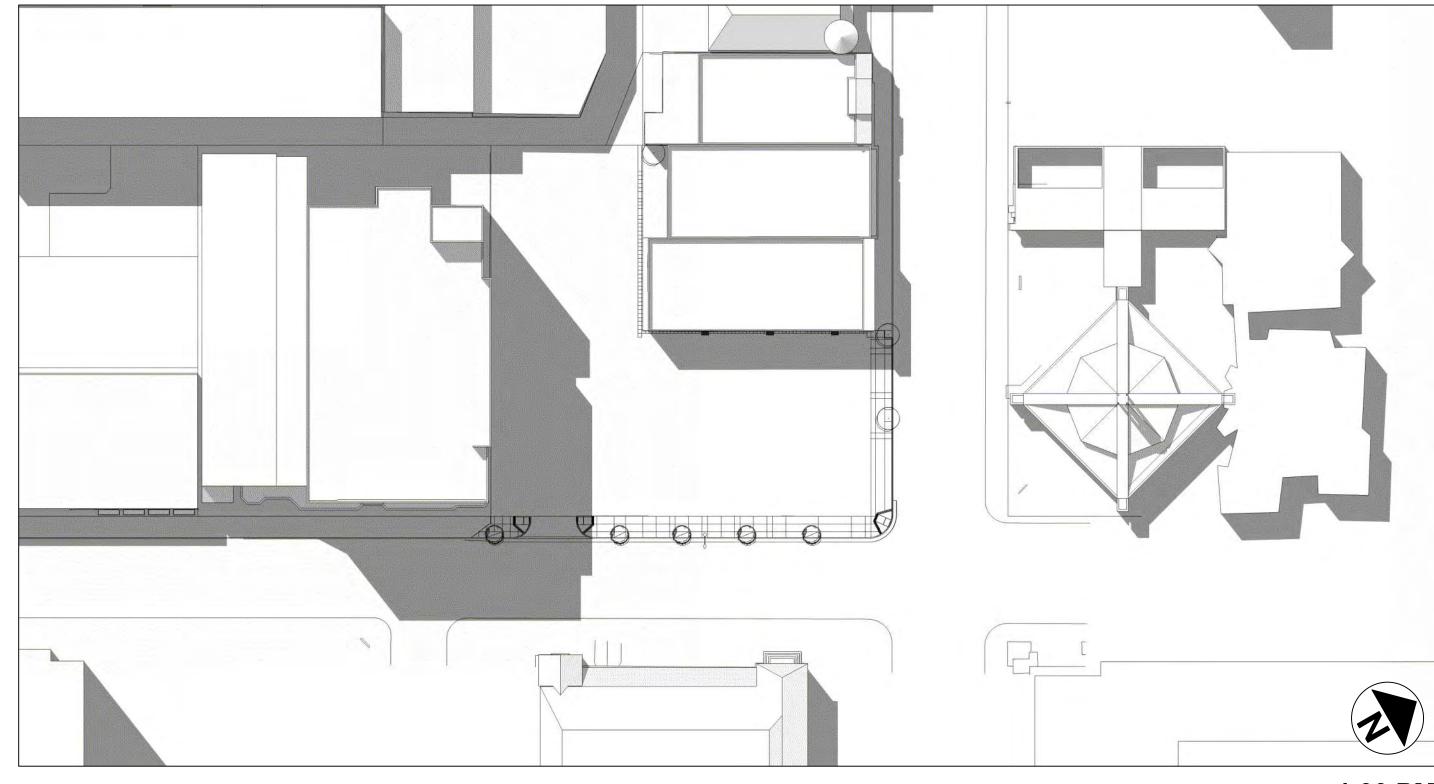

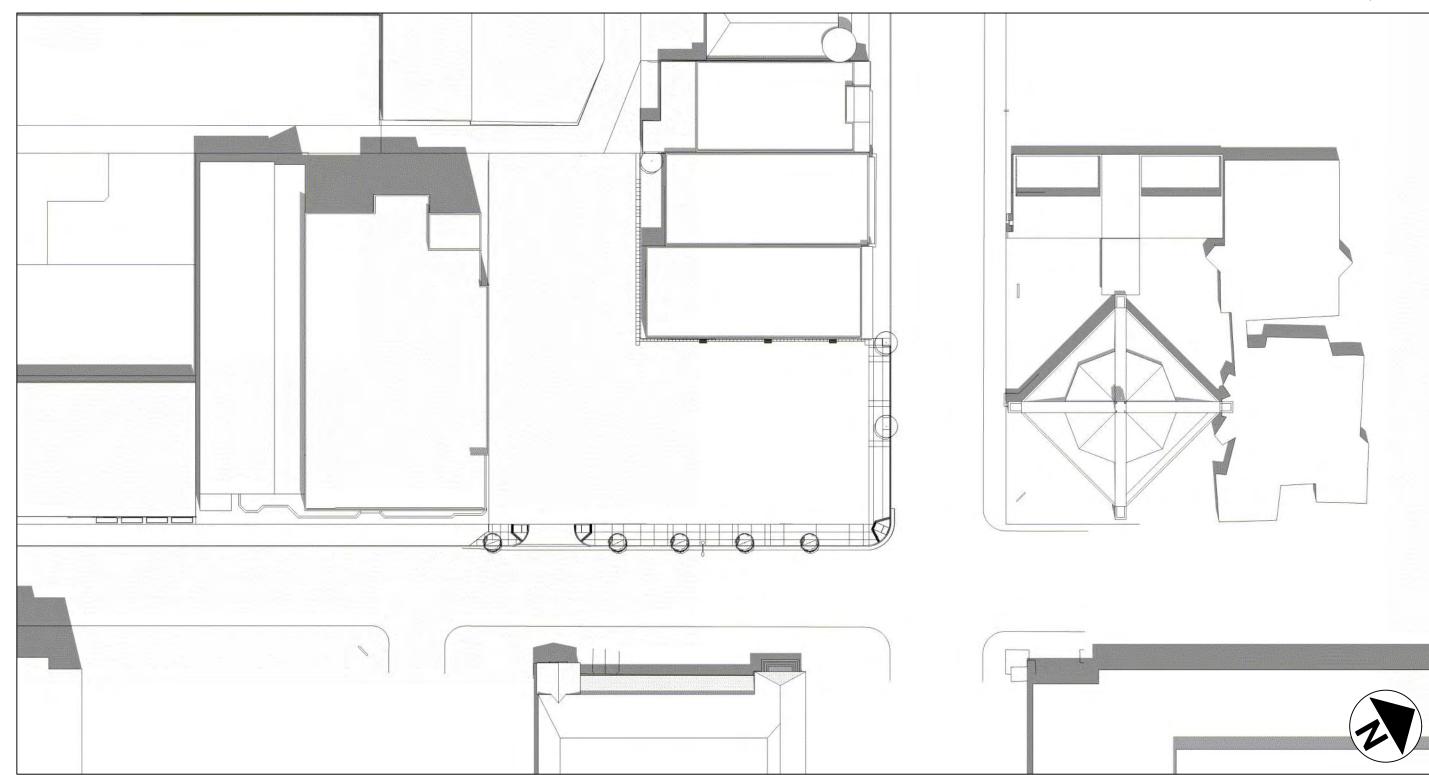

4:00 PM

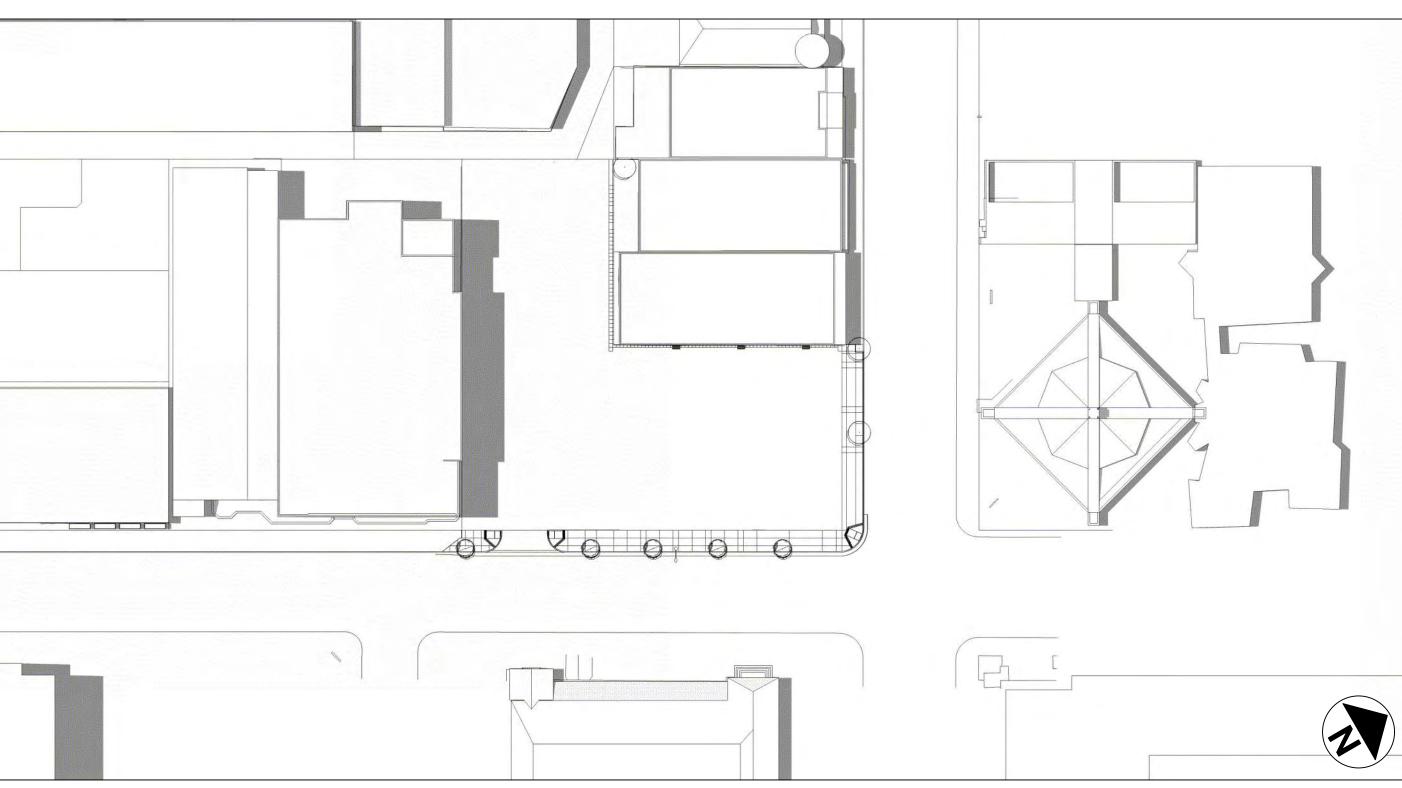

V 0 0 0 0


1:00 PM


9:00 AM **JUNE 21ST**


EXISTING CONDITION (AT GRADE PARKING LOT) SHEET NAME:



10:30 AM

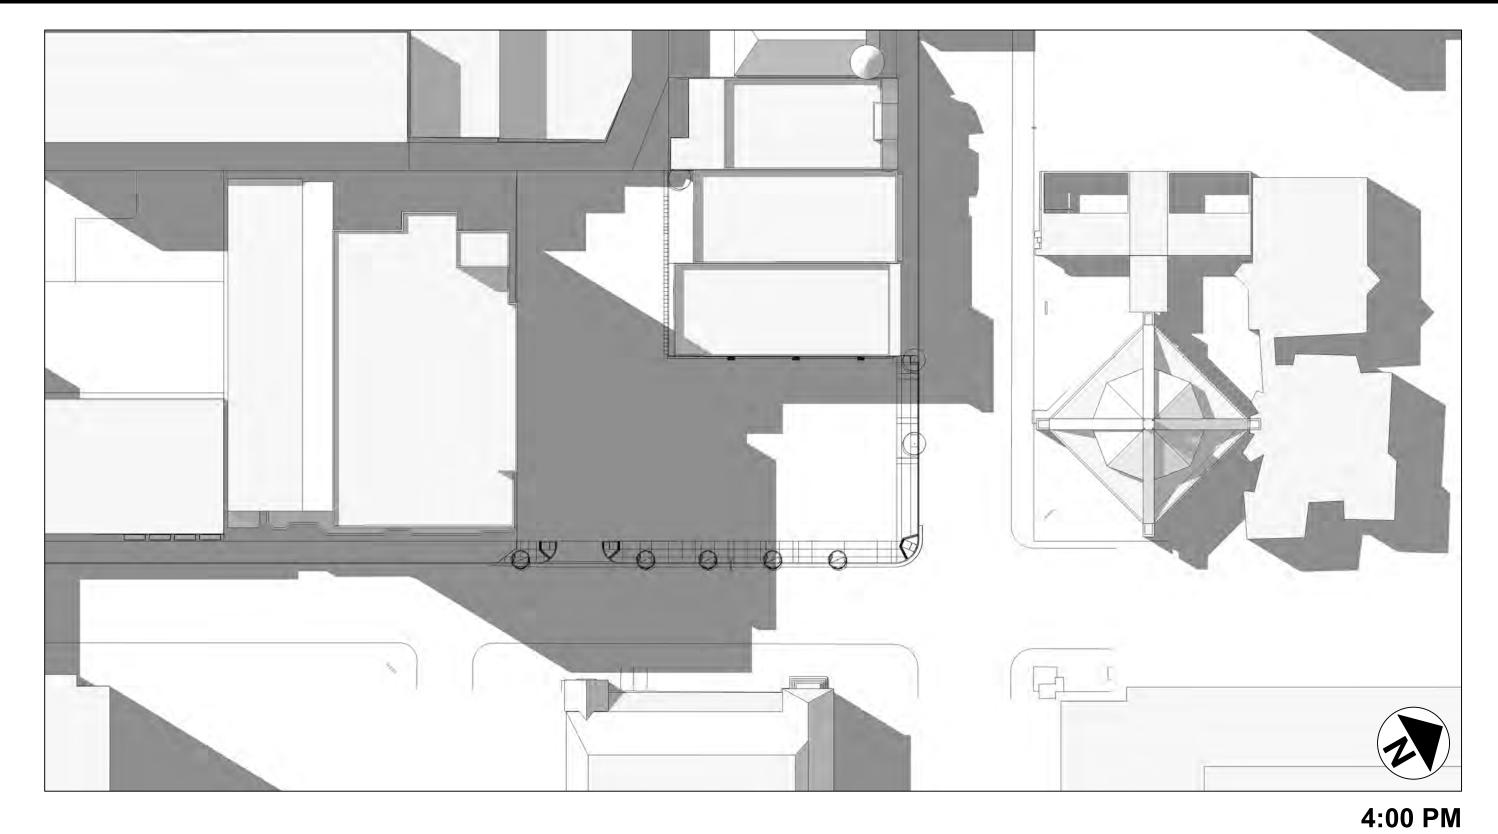

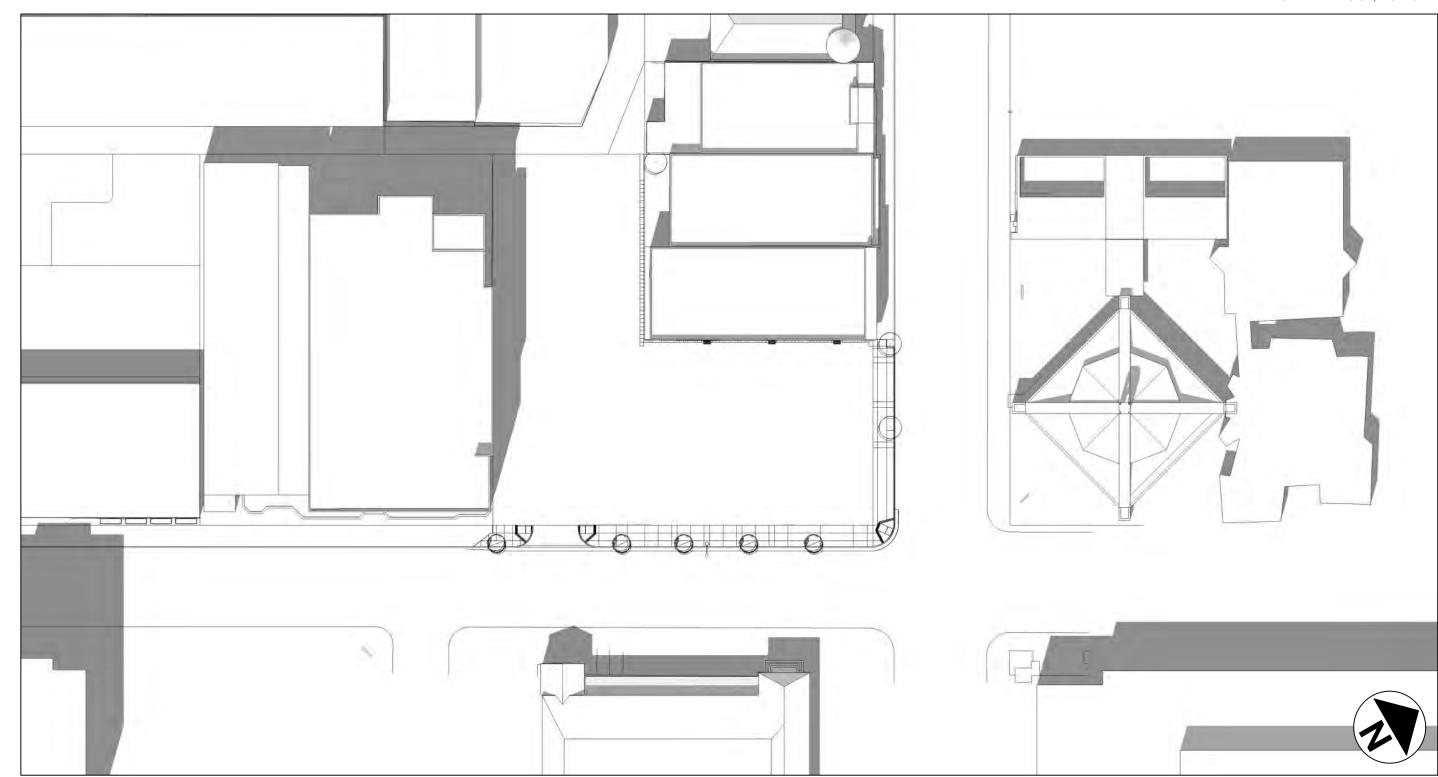


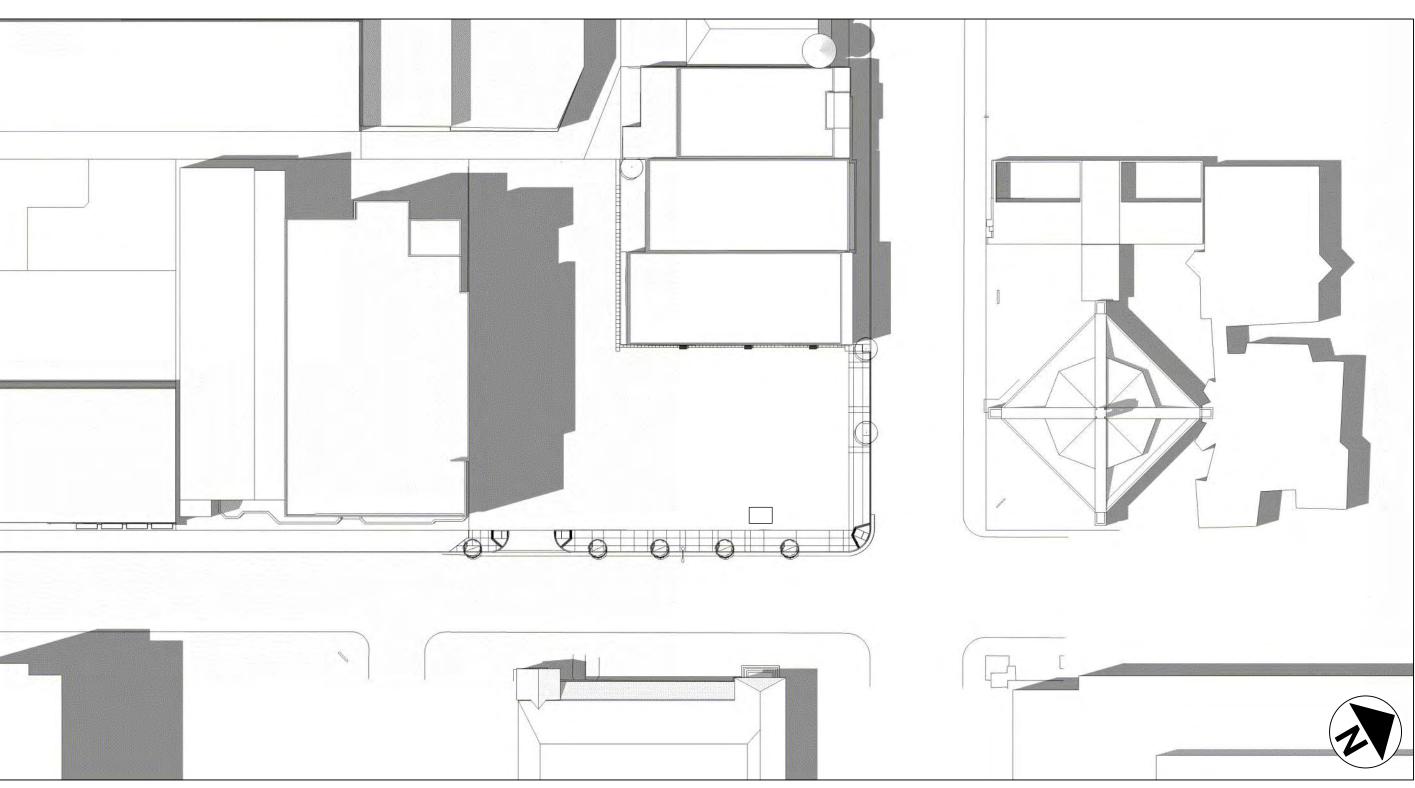


1:00 PM

9:00 AM SEPTEMBER 21ST EXISTING CONDITION (AT GRADE PARKING LOT)


SHEET NAME:

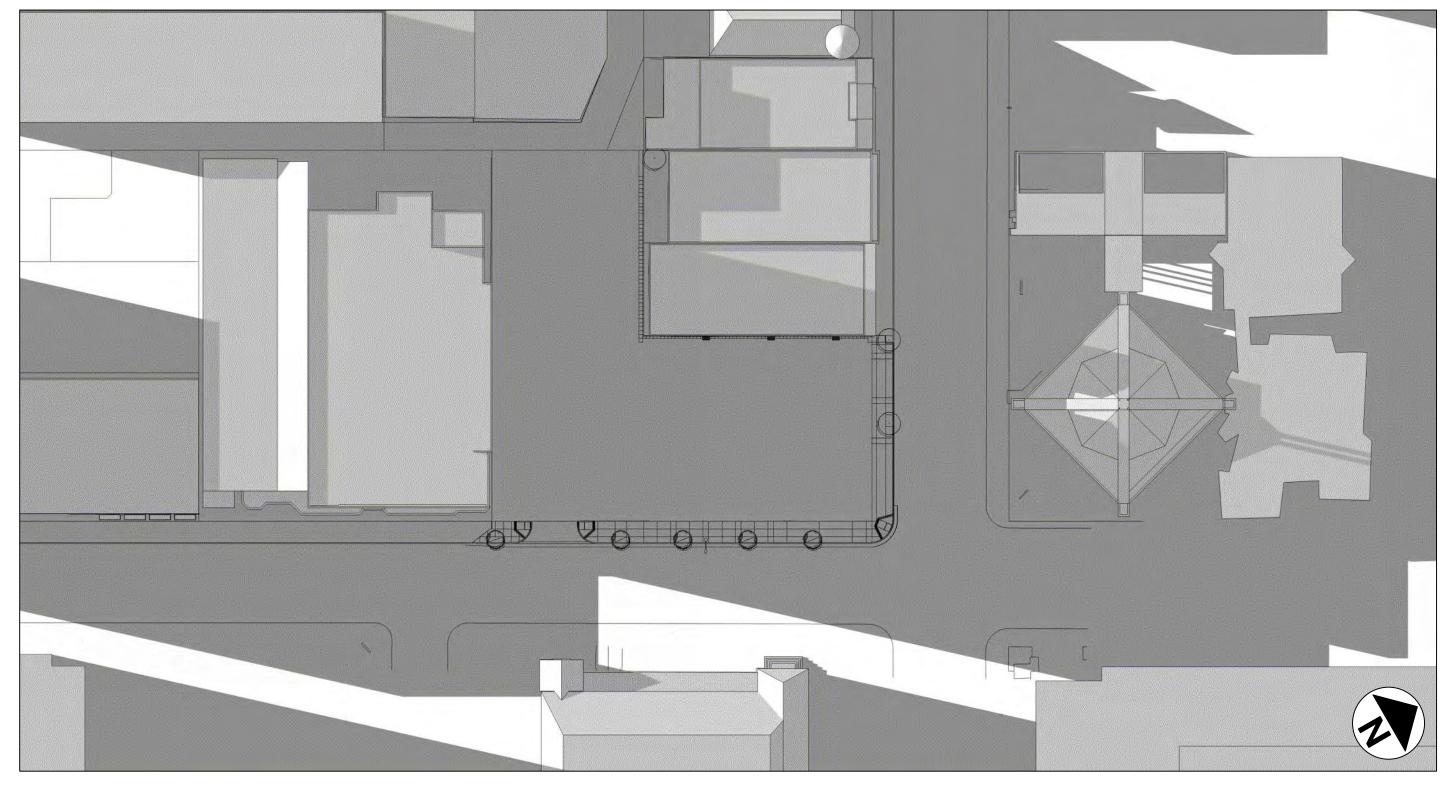

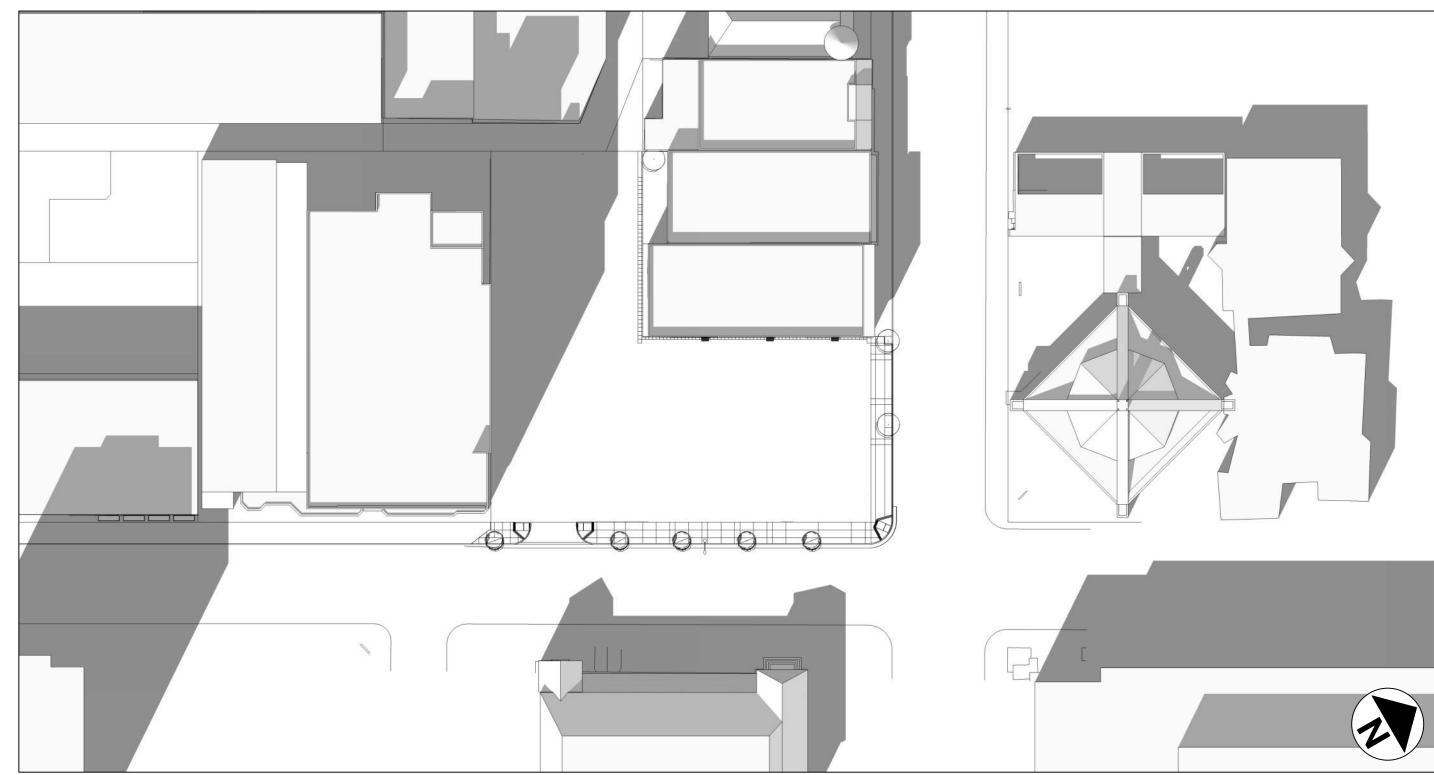


4:00 PM

10:30 AM

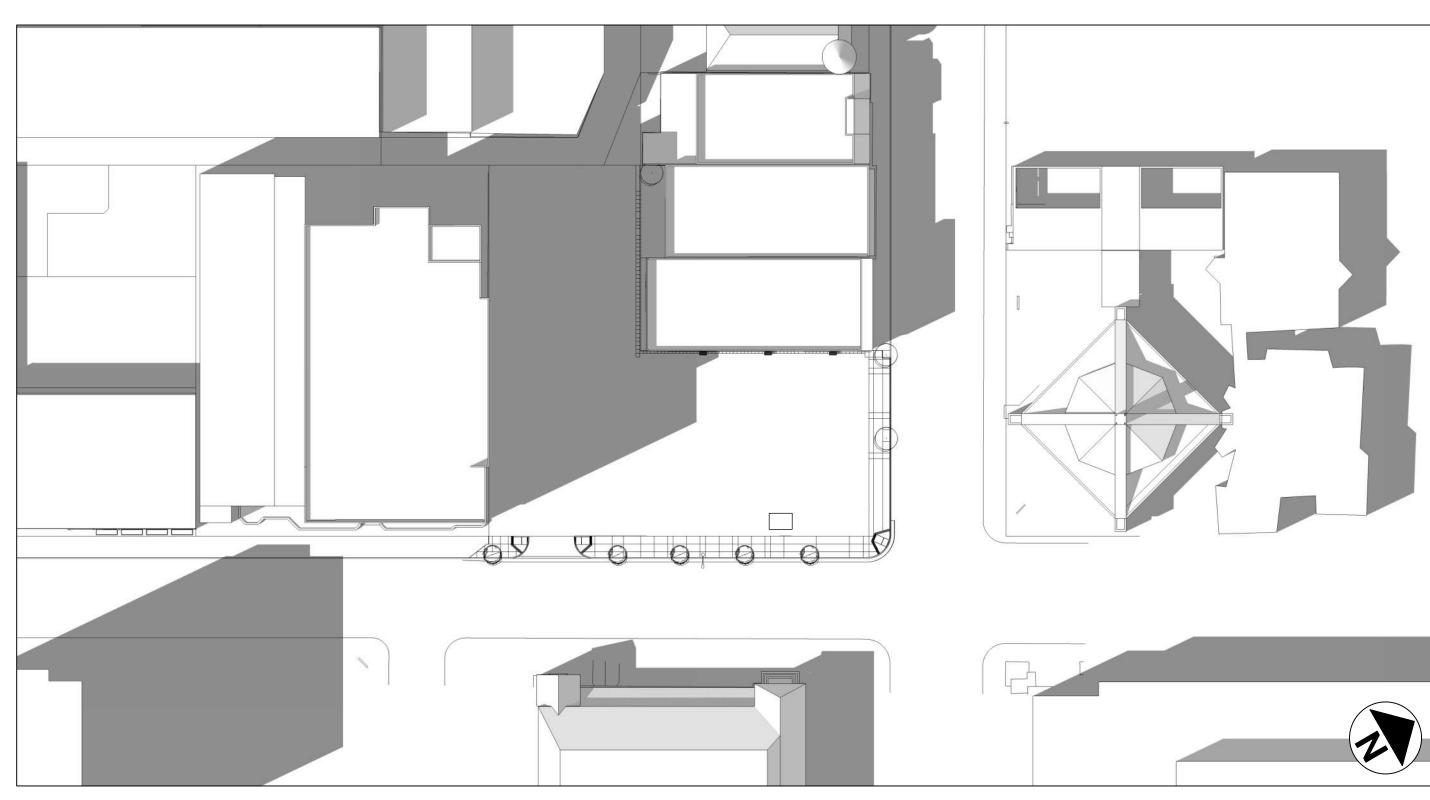


TECTS

1:00 PM

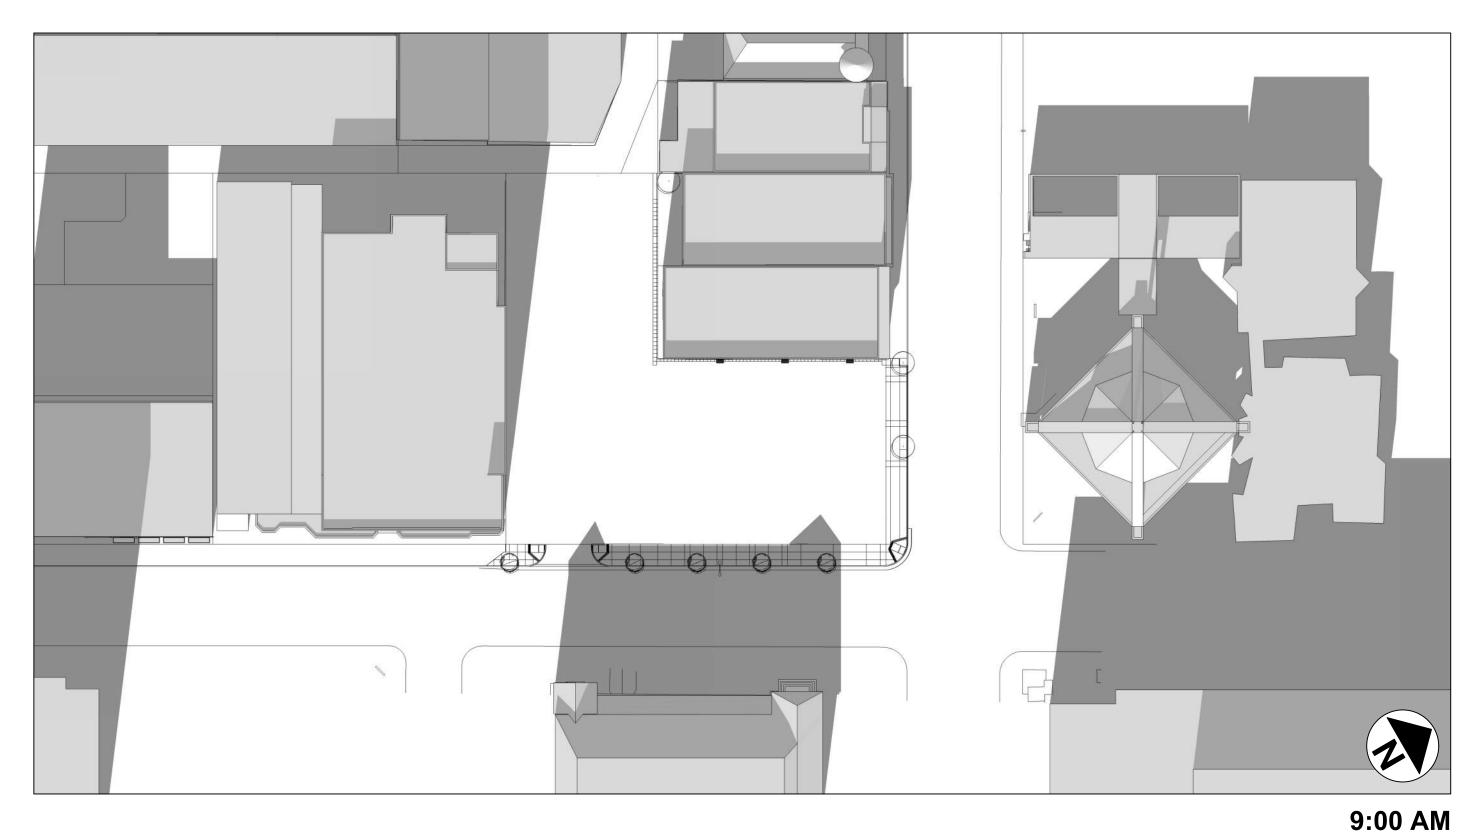


DECEMBER 21ST EXISTING CONDITION (AT GRADE PARKING LOT)

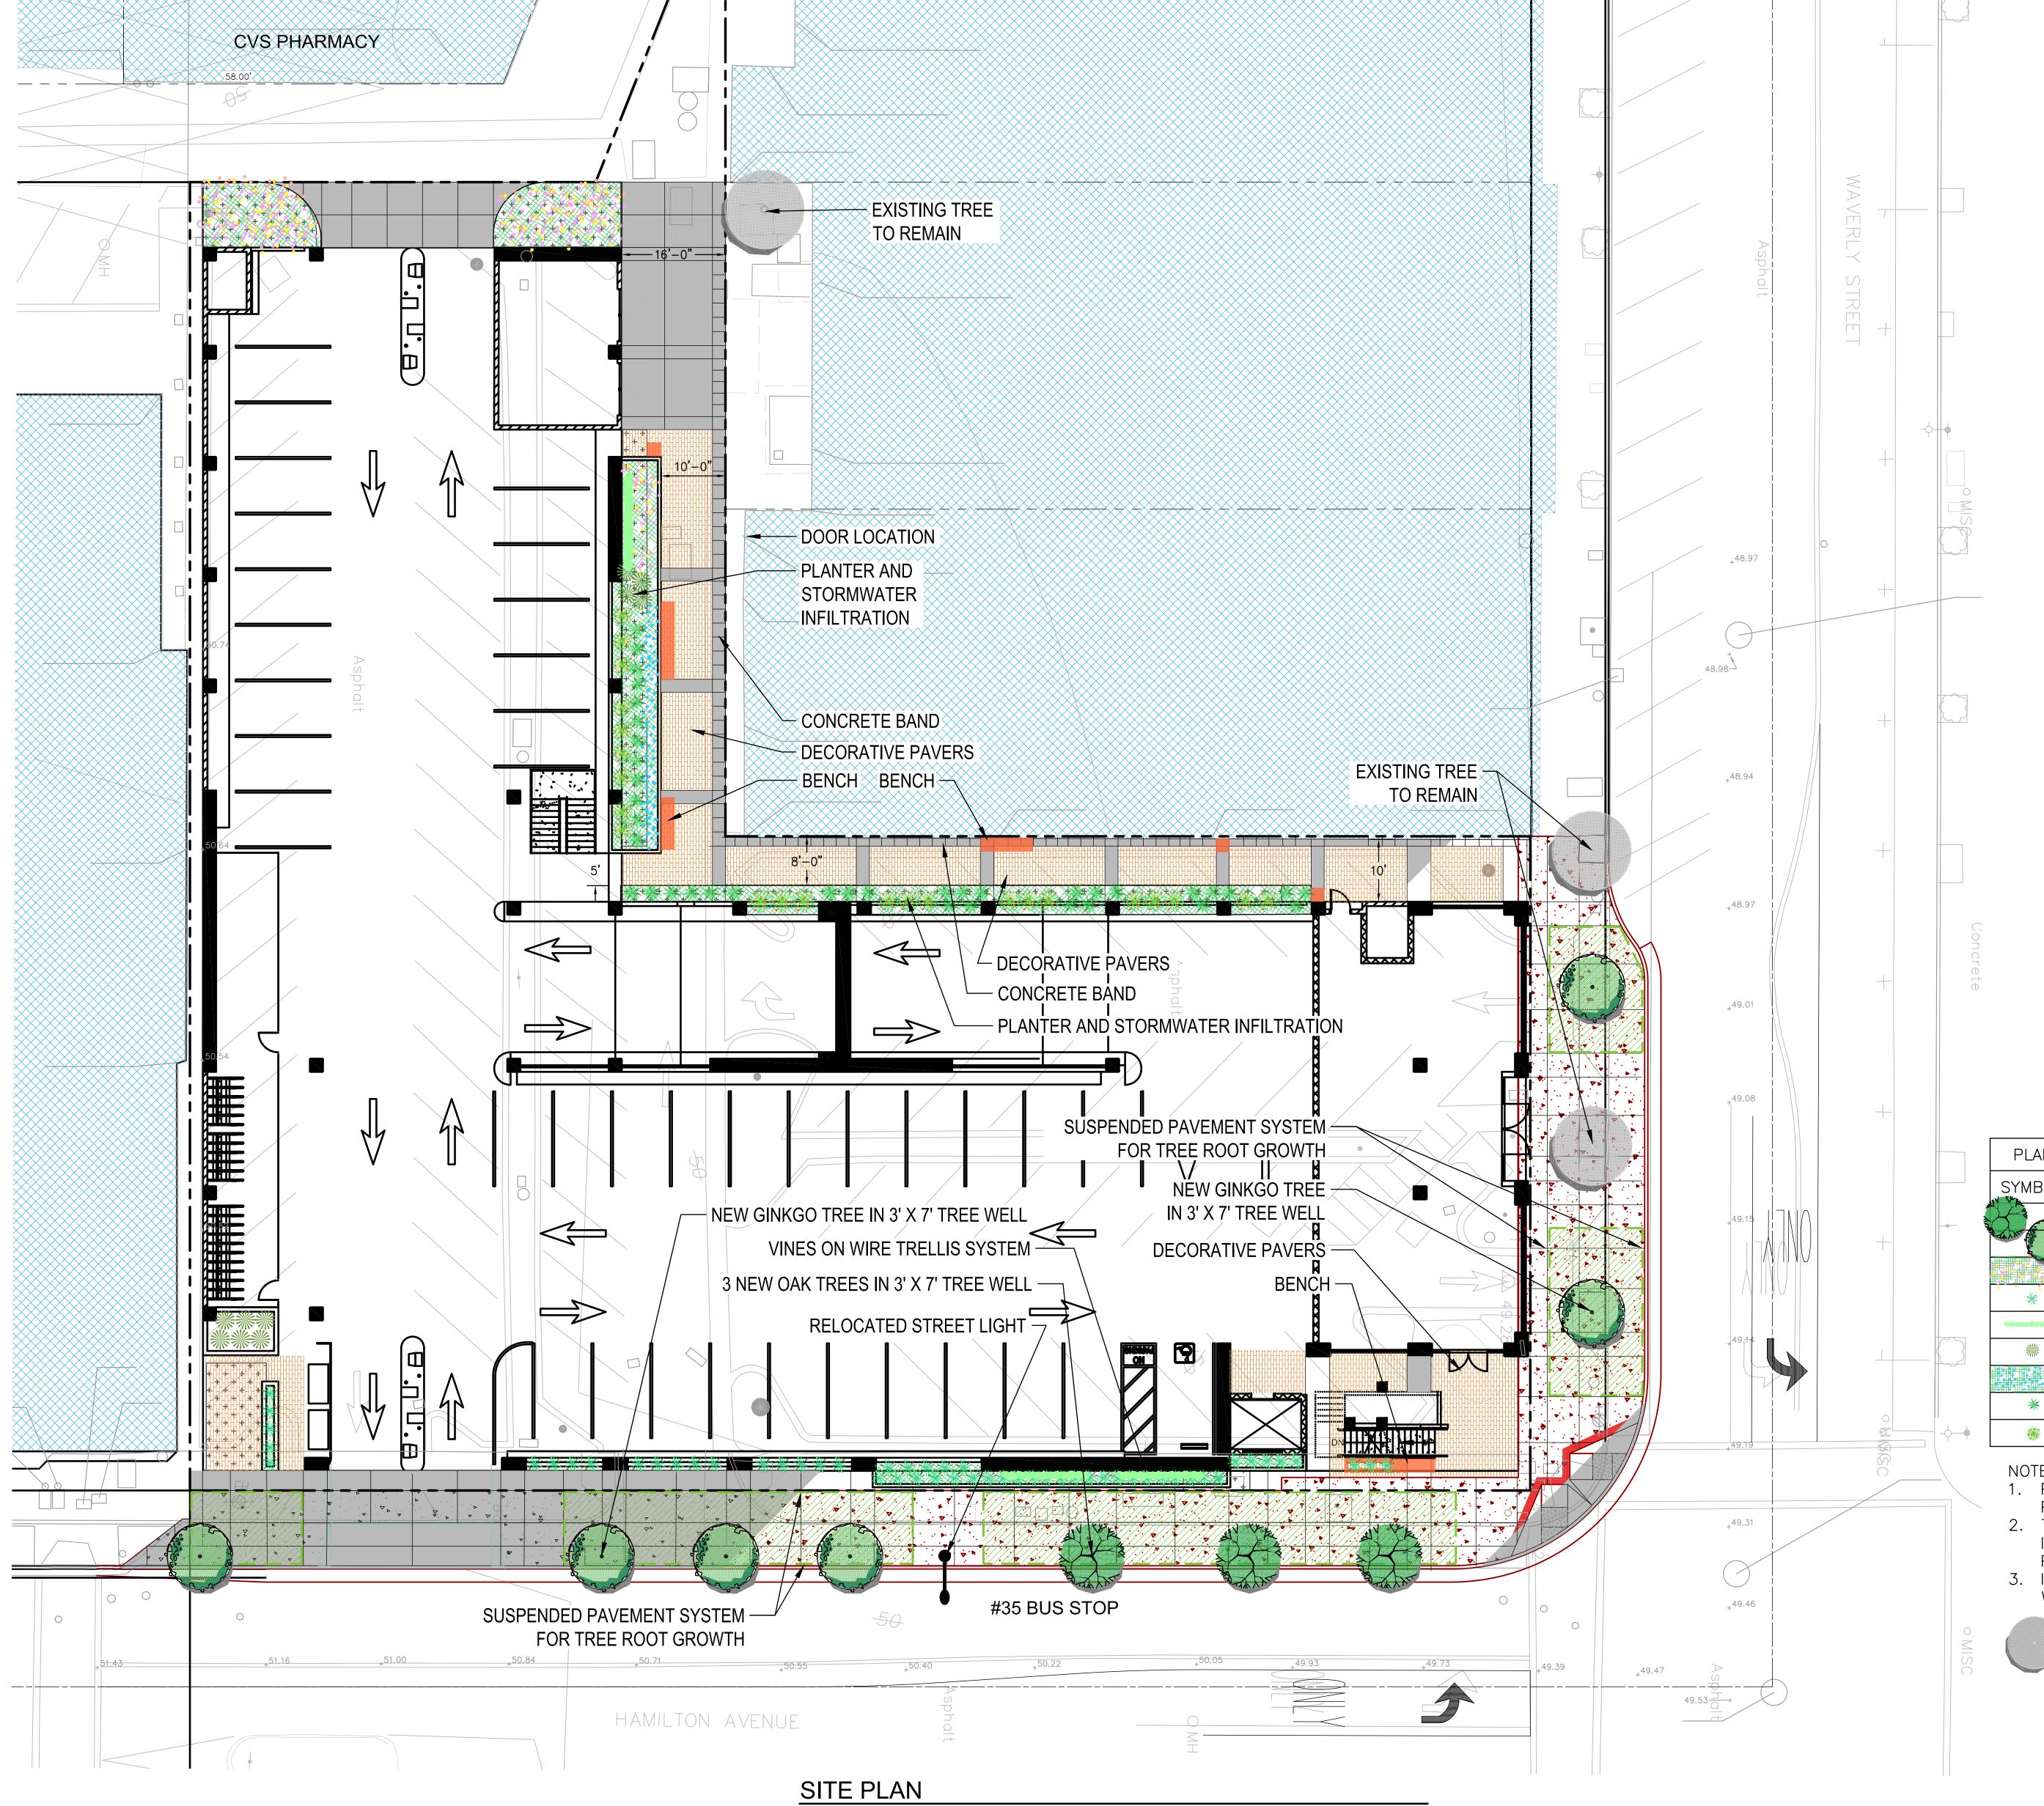




REFERENCE IMAGE 1 ALLEY CHARACTER

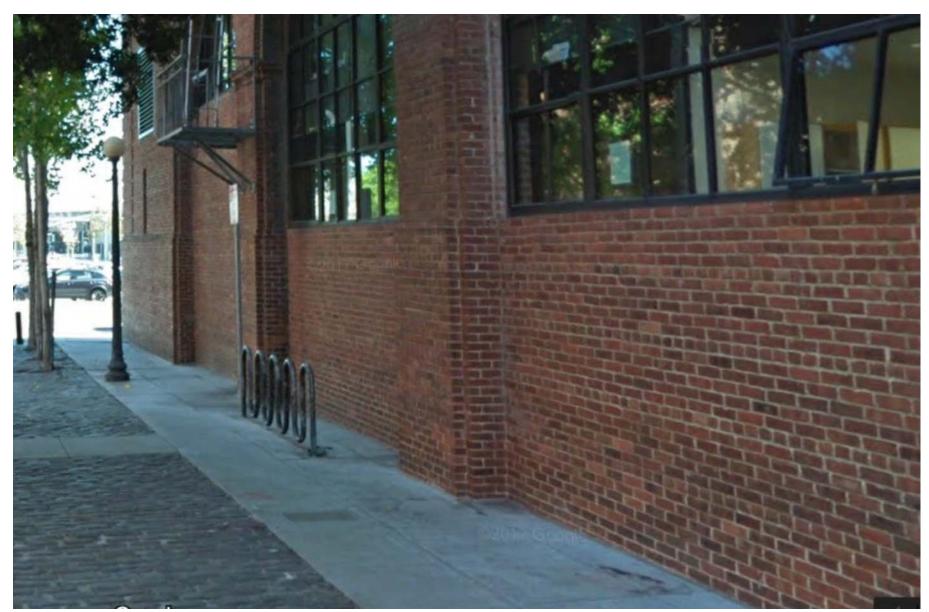

REFERENCE IMAGE 2 ALLEY CHARACTER

PLANT LIST & LEGEND										
SYMBOL	BOTANICAL NAME	COMMON NAME	SIZE	QUANTITY						
The state of the s	QUERCUS AGRIFOLIA	COAST LIVE OAK	24" BOX	3						
ALANS ASS.	GINKGO BILOBA	MAIDENHAIR TREE	24" BOX	6						
	ACHILLEA MILLEFOLIUM 'SUMMER PASTELS'	SUMMER PASTELS YARROW	5 G.C.	125						
*	PENNESETUM SPATHIOLATUM	SLENDER VELDT GRASS	5 G.C.	55						
400000000	VITUS CALIFORNICA	CALIFORNIA GRAPE	5 G.C.	24						
*	MUHLENBERGIA CAPILARIS	PINK MUHLEY	5 G.C.	10						
	PENSTEMON SPECIOSUS	ROYAL PENSTEMON	5 G.C.	30						
*	POLYSTICHUM MUNITUM	SWORD FERN	5 G.C.	38						
***	RIBES SANGUINEUM	RED CURRANT	5 G.C.	23						

- 1. PLANTING AREAS IN THE ALLEYWAY WILL BE FLUSH WITH THE PAVEMENT. ALL OTHER PLANTERS ARE RAISED ABOVE PAVEMENT LEVEL.
- WITHIN THE STRUCTURE IN A MECHANICAL AND ELECTRICAL SERVICE ROOM.

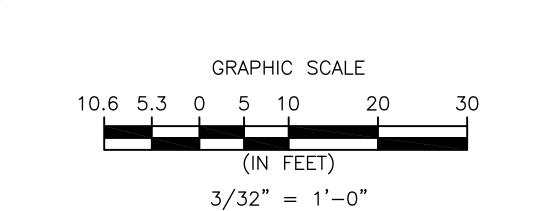

EXISTING TREE TO REMAIN. REFER TO

ARBORISTS REPORT.



249 Front Street San Francisco, CA P. 415.291.8960 F.415.291.9463 cal. lic. #2690 www.merrill-morris.com

Merris




TUMBLED PAVERS WITH RUSTIC TEXTURE



'PLANK' PAVERS - SMOOTH LINEAR FORM




GINKGO STREET TREE - fall color

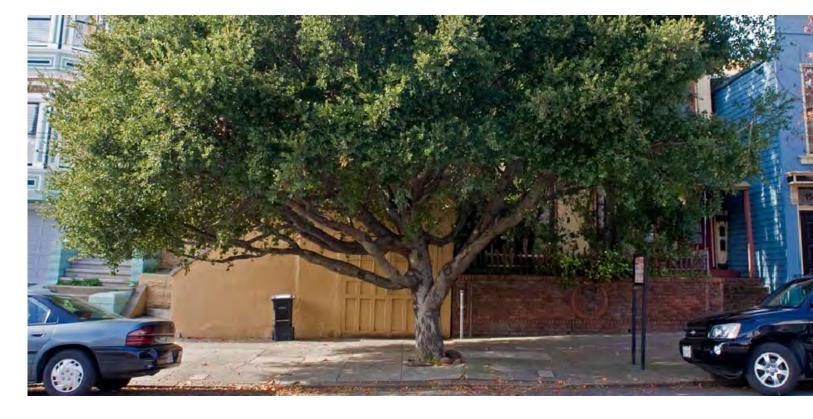

COAST LIVE OAK

DECORATIVE PAVER OPTIONS PAVERS CAN BE PERVIOUS TO AID STORM WATER MANAGEMENT

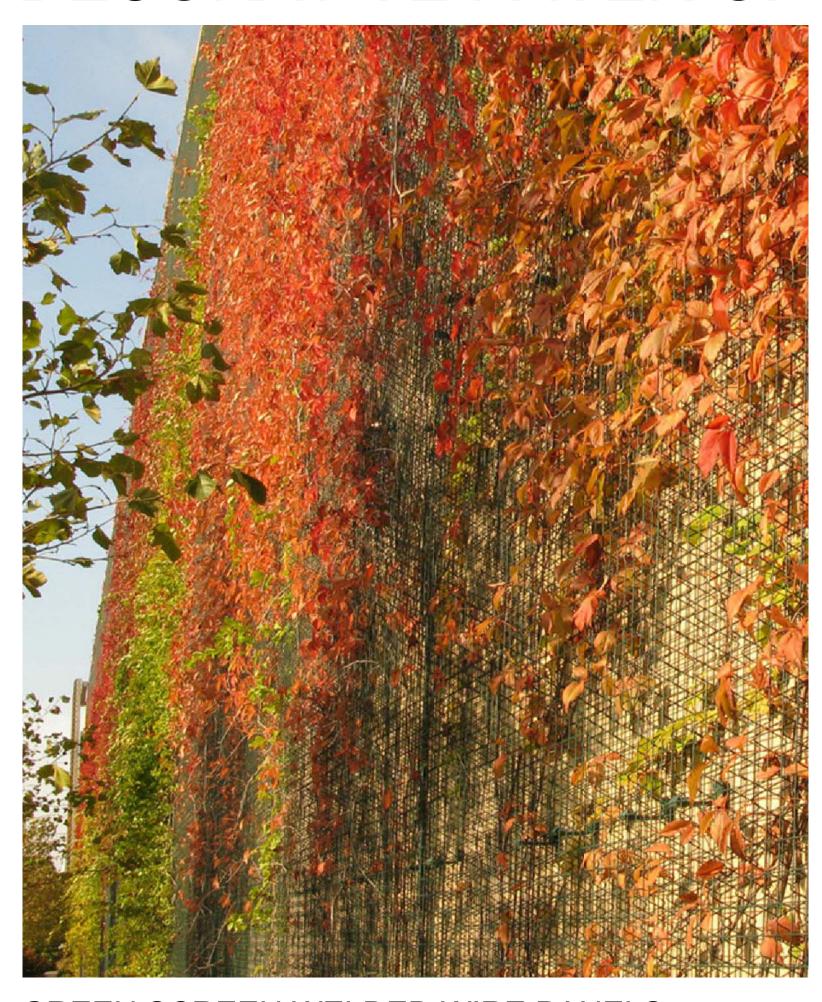

GREEN SCREEN WELDED WIRE PANELS

POST AND STAINLESS STEEL WIRE SYSTEM

TREES - GINKGO TO MATCH EXISTING STREET TREES TO REMAIN, OAK AS MITIGATION FOR REMOVAL OF EXISTING



CALIFORNIA GRAPE DECIDUOUS VINE THAT PROVIDES SHADE IN SUMMER, FALL COLOR, AND LIGHT IN WINTER WHEN LEAVES FALL OFF. SUN OR SHADE TOLERANT.

VINE - TO BE TRAINED TO GROW ON EITHER THE GREENSCREEN OR THE WIRE TRELLIS SYSTEM



SWORD FERN EVERGREEN PERENNIAL TO 3 FEET



IN SPRING. DOES WELL IN



EVERGREEN GROUNDCOVER TO

EVERGREEN GROUNDCOVER





SLENDER VELDT GRASS PERENNIAL GRASS TO 2 FEET

TRELLIS OPTIONS



TIMBERFORM 'COLOSSUS' - SIMPLE & TIMELESS



LANDSCAPE FORMS 'PARALLEL' - FORM SIMILAR TO BUILT-IN BENCH ON HAMILTON STREET

COYOTE MINT EVERGREEN GROUNDCOVER TO 2 FEET TALL. DOES WELL IN SHADE.





DUNE SEDGE EVERGREEN GROUNDCOVER TO 2 GRASS-LIKE EVERGREEN SHADE TOLERANT.

BENCH OPTIONS FOR ALLEY PASSAGE

WOOD IS THE MOST COMFORTABLE MATERIAL TO SIT ON



PROJECT NUMBER:

16-138 DOWNTOWN PARKING GARAGE

ARB 4.2- MATERIALS AND PLANT SELECTIONS

SHADE TOLERANT.

San Francisco, CA F.415.291.9463 cal. lic. #2690 www.merrill-morris.com


DATE ISSUED:

07/12/18

Morris

249 Front Street

CITY OF PALO ALTO

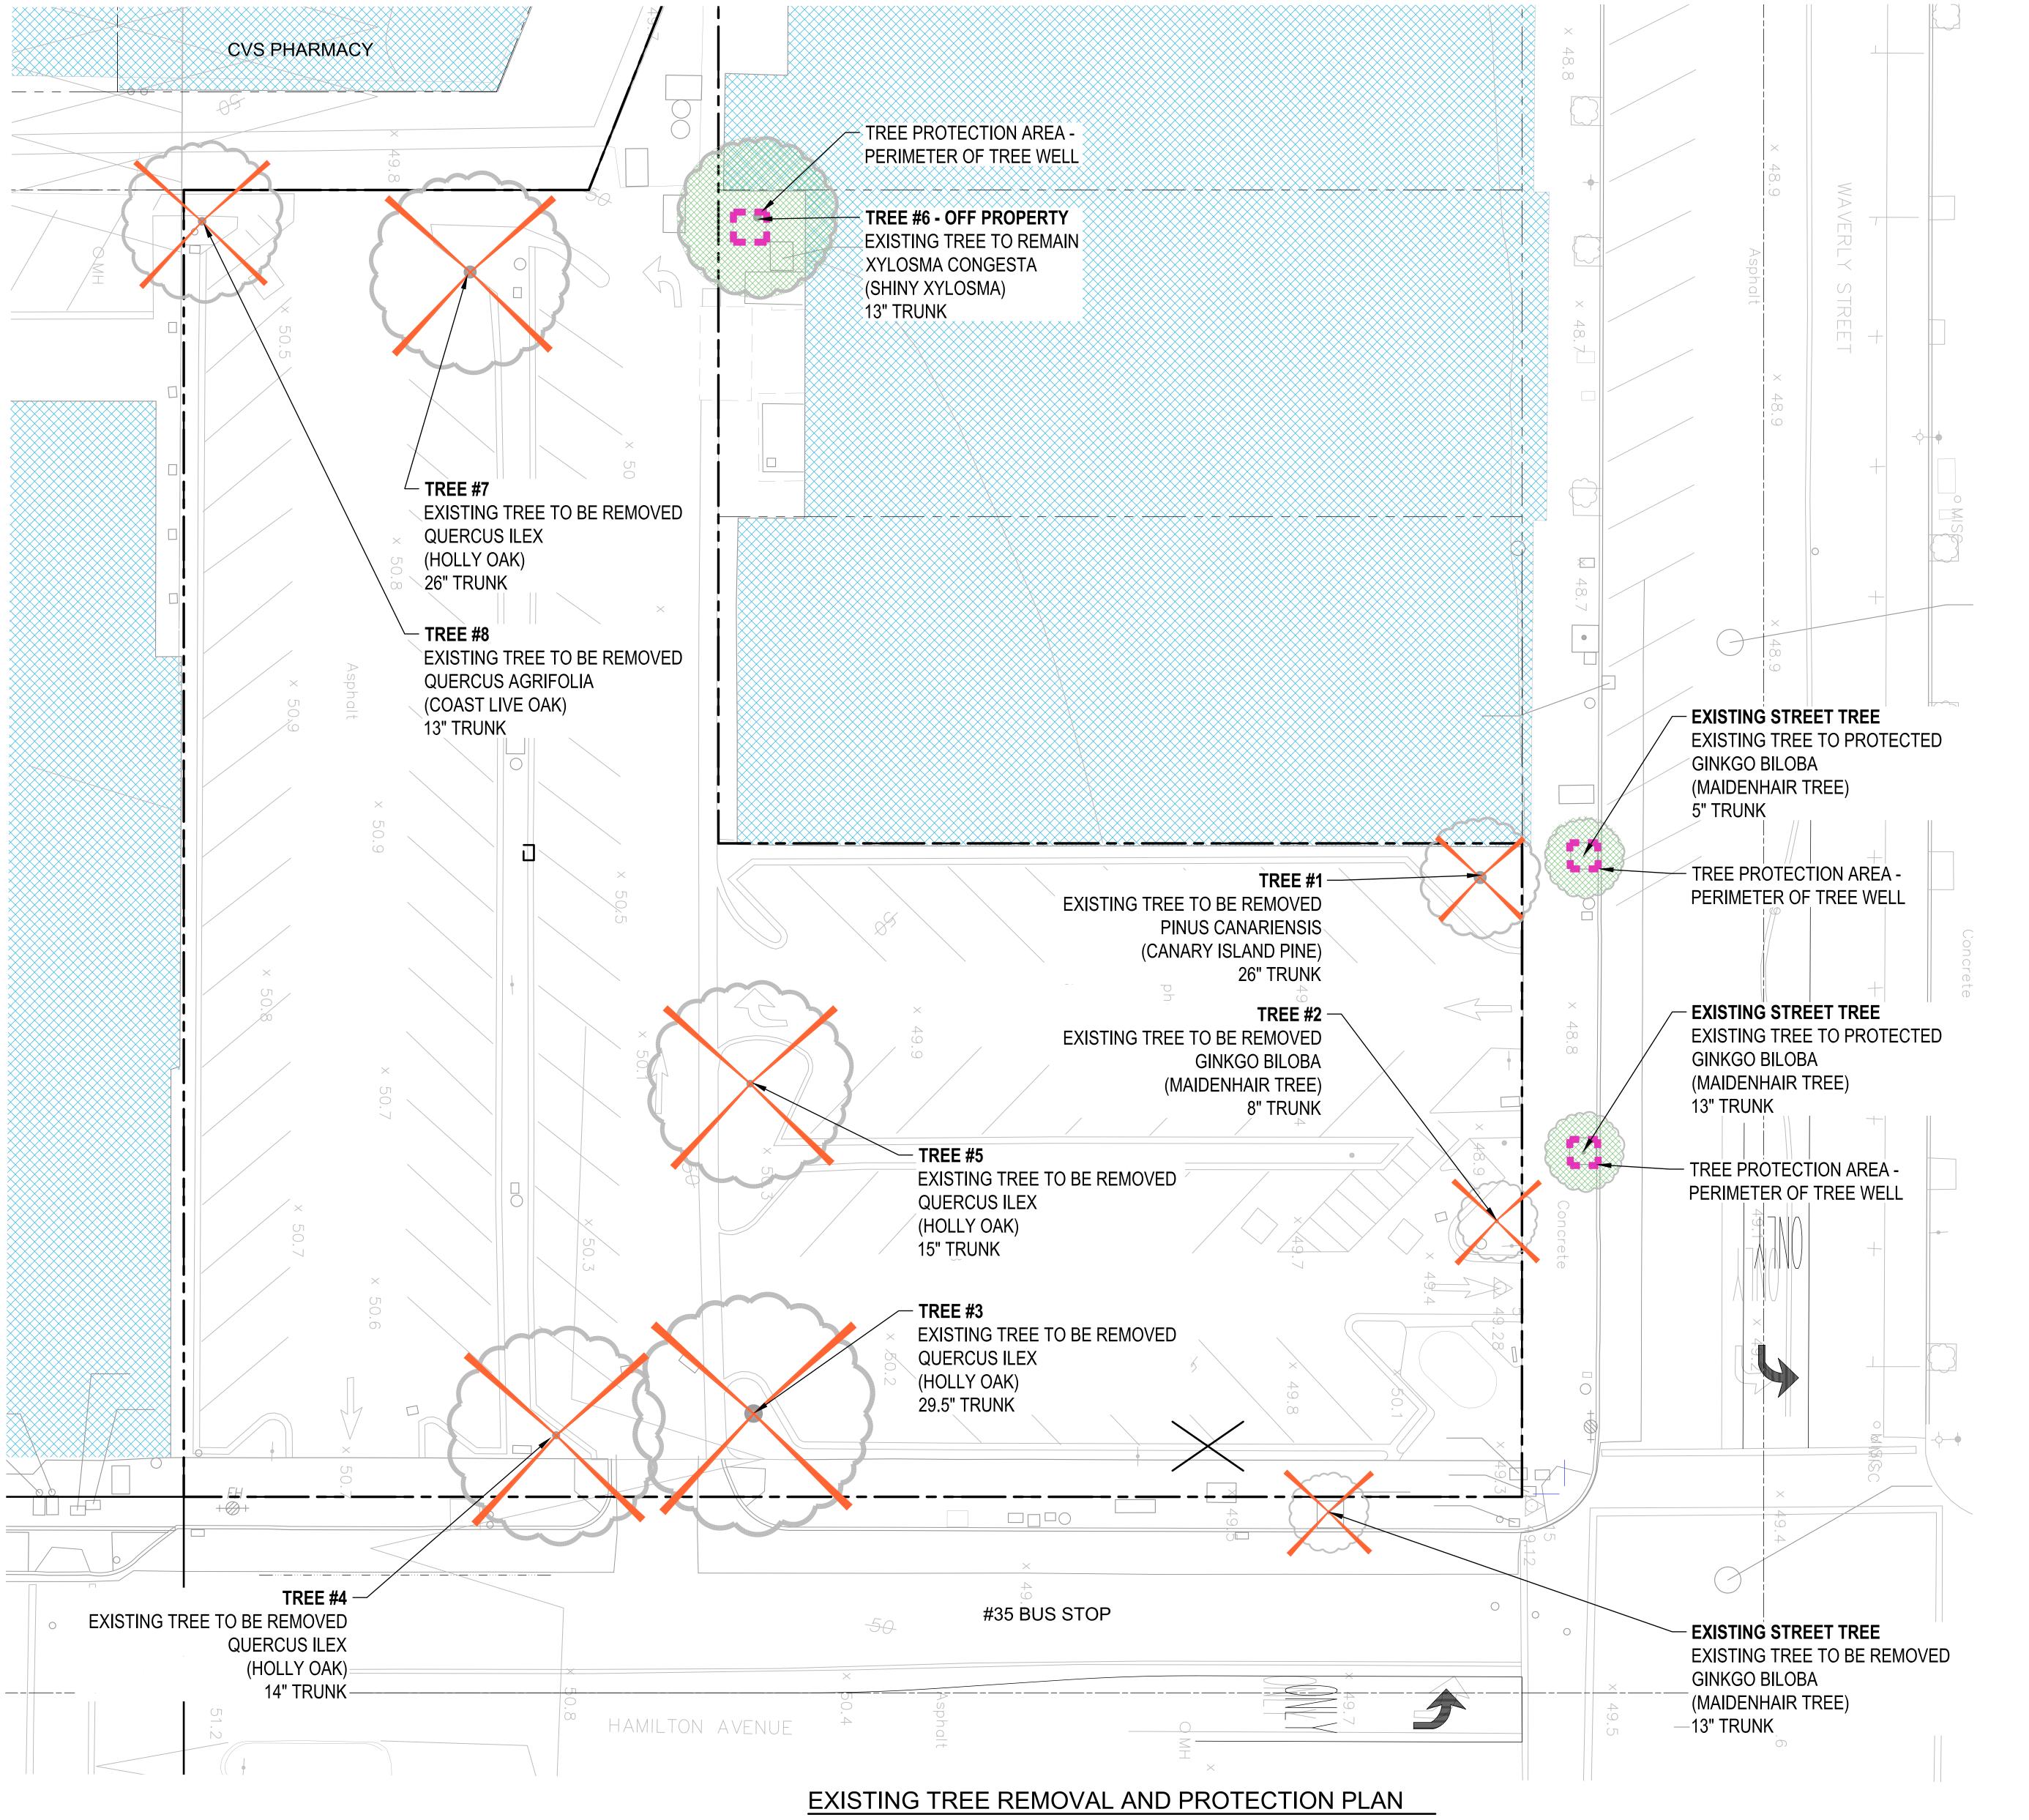

COLUMN HEADING DESCRIPTIONS

Tree# - Indicates tree number corresponding to Tree Location Map Species - Scientific name

Common Name – Vernacular name

DBH - Diameter measured in inches at 4.5 feet above soil grade, unless otherwise indicated

Height - In feet Spread - In feet

Health -Tree Health: E is Excellent, G is Good, F is Fair, P is Poor, D is Dead or Dying
Structure- Tree Structural Safety: E is Excellent, G is Good, F is Fair, P is Poor, H is Hazardous
Protected? - Attaining City of Palo Alto Protected Tree Status: Y is Yes, N is No

Notes - See below
DEFINITIONS

Included Bark - This is a structural defect where bark is included between the branch attachment.

Notes

Codominant — A tree with two or more stems which are of equal diameter and relative amounts of leaf area.

Codominant w/ Embedded Bark - When bark is embedded between codominant stems, failure potential is very high and pruning to mitigate the defect is recommended.

Lion Tailing- The improper practice of removing all or most secondary and tertiary branches from the interior portion of the

<u>Lion Tailing</u>- The improper practice of removing all or most secondary and crown, leaving most live foliage at the edge of the canopy.

Tree #	Species	Common Name	DBH	Height	Health	Structure	Protected ?	Notes
1	Pinus canariensis	Canary Island Pine	26	85	G	Р	N	Codominant w included bark with likely internal crack, curb displacement
2	Ginkgo biloba	Maidenhair	8	30	G	G	N	Large trunk wound
з	Quercus ilex	Holly Oak	29.5	55	G	F-G	N dead b truck d Heavy	Lions-tailed, heavy end weight, dead branches over parking lot, truck damage to upper scaffold
4	Quercus ilex	Holly Oak	14	30	G	F		Heavy end weight over parking lot and sidewalk, under canopy of #4
5	Quercus ilex	Holly Oak	15	30	F	F	N	Dieback on one side, curb displacement
6	Xylosma congestum	Shiny Xylosma	13	25	G	F	N	Raised planter
7	Quercus ilex	Holly Oak	26	55	G	F-G	N	Codominant, heavy end weight
8	Quercus agrifolia	Coast Live Oak	13	30	F	Р	Υ	Recent lions-tailing, included bark in canopy, old large trunk wound closed over

Report Submitted By:

AMI

Molly Batchelder, Consulting Arborist WC ISA Certified Arborist #9613A Tree Risk Assessment Qualified (TRAQ)


SBCA Tree Consulting 1534 Rose St. Crockett, CA 94525 steve@sbcatree.com



NOTES ON TREE PROTECTION:

ALL TREES SHOWN TO BE PROTECTED ARE OFF SITE, EITHER AS STREET TREES OR ON AN ADJACENT PROPERTY. ALL TREES TO BE PROTECTED ARE IN EXISTING TREE WELLS AND THE TREE PROTECTION FENCE WILL FOLLOW THE PERIMETER OF THE TREE WELL, WHICH IS GENERALLY 4X4 FEET.

ALL TREES TO BE PRESERVED SHALL BE PROTECTED WITH FIVE OR SIX (5' - 6') FOOT HIGH CHAIN LINK FENCES. FENCES ARE TO BE MOUNTED ON TWO INCH DIAMETER GALVANIZED IRON POSTS, DRIVEN INTO THE GROUND TO A DEPTH OF AT LEAST 2-FEET AT NO MORE THAN 10-FOOT SPACING (SEE PUBLIC WORKS DEPARTMENT DETAIL #505, APPENDIX K). THIS DETAIL SHALL APPEAR ON GRADING, DEMOLITION AND IMPROVEMENT PLANS.

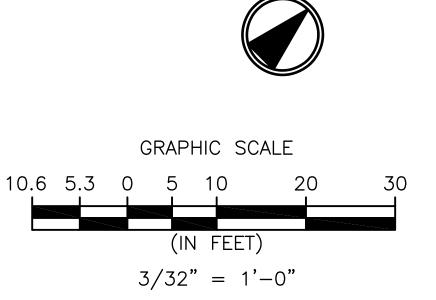

Merris

249 Front Street San Francisco, CA 94111 P. 415.291.8960 F.415.291.9463 cal. lic. #2690 www.merrill-morris.com

PROJECT NAME:

CLIENT NAME:

TREE DISCLOSURE STATEMENT

CITY OF PALO ALTO Planning Division, 250 Hamilton Avenue Palo Alto, CA 94301 (650) 329-2441

http://www.cityofpaloalto.org

Palo Alto Municipal Code, Chapter 8.10.040, requires disclosure and protection of certain trees located on private and public property, and that they be shown on approved site plans. A completed disclosure statement must accompany all building permit applications that include exterior work, all demolition or grading permit applications, or other development activity.

PROPERTY ADDRESS: 375 Hamilton Ave.

Are there Regulated trees on or adjacent to the property?

(YES) NO (If no, proceed to Section 4)

1. Where are the trees? Check those that apply. (Plans must be submitted showing over 4" diameter trees)

[Sections 1-4 MUST be completed by the applicant. Please circle and/or check where applicable.]

On adjacent property overhanging the project site

☐ In the City planter strip or right-of-way easement within 30' of property line (Street Trees)*

*Street trees require special protection by a fenced enclosure, per the attached instructions. Prior to receiving any permit, you must provide an authorized Street Tree Protection Verification form by calling Public Works Operations at 493-5953 for inspection of required type I, II or III

2. Are there any Protected or Designated Trees? (YES Check where applicable) NO

☐ Designated Tree (s)

☐ On or overhanging the property

3. Is there activity or grading within the dripline? (radius 10 times the trunk diameter) of these trees? If Yes, a Tree Preservation Report must be prepared by an ISA certified arborist and submitted for staff review (see TTM, Section 6.25). Attach this report to Sheet T-1,:Tree Protection, its Part of the Plan!", per Site Plan Requirements.

4. Are the Site Plan Requirements** completed?

**Protection of Regulated trees during development require the following: (1) Plans must show the measured trunk diameter and canopy dripline; (2) Plans must denote, as a bold dashed line, a fenced enclosure area out to the dripline, per Sheet T-1 and Detail #605 http://www.cityofpaloalto.org/trees/forms.htm (See also TTM, Section 2.15 for area to be fenced)

I, the undersigned, agree to the conditions of this disclosure. I understand that knowingly or negligently providing false or misleading information in response to this disclosure requirement constitutes a violation of the Palo Alto Municipal Code Section 8.10.040, which can lead to criminal and/or civil legal action.

(Prop. Owner or Agent)

FOR STAFF USE:

Protective Fencing

Sections 5-6 must be completed by staff for the issuance of any development permit (demolition, grading or building permit).

5. Protected Trees. The specified tree fencing is in place. A written statement is attached verifying that protective fencing is correctly in place around protected and/or designated trees. (N/A if there are no protected trees, check here \square)

6. Street Trees. A signed Public Works Street Tree Protection Verification form is attached. (N/A if there are no street trees, check here \square).


Regulated Trees - a) Street trees - trees on public property; b) Protected trees - Coast Live Oaks or Valley Oaks which are 11.5" in diameter or larger, Coast Redwoods which are 18" in diameter or larger, when measured 54" above natural grade; and Heritage trees are trees designated by City Council; and c) Designated Trees - commercial or non-residential property trees, which are part of an approved landscape plan.


Palo Alto Tree Technical Manual (TTM) contains instructions for all requirements on this form, available at http://www.cityofpaloalto.org/planning-community/tree_technical-manual.html

S:Plan/Pladiv/Arborist/Tree Protection Info/Tree Disclosure Statement

Revised 08/06


YES NO

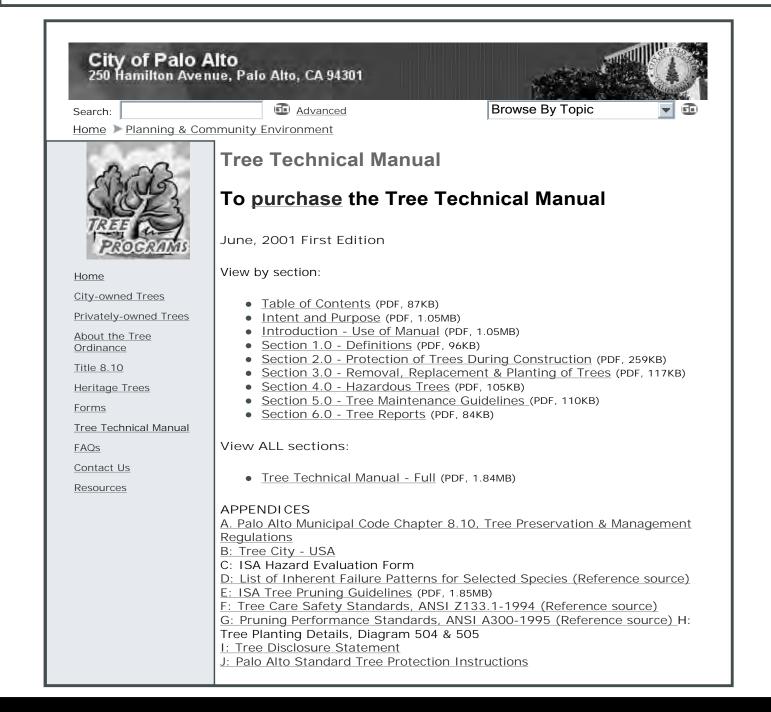

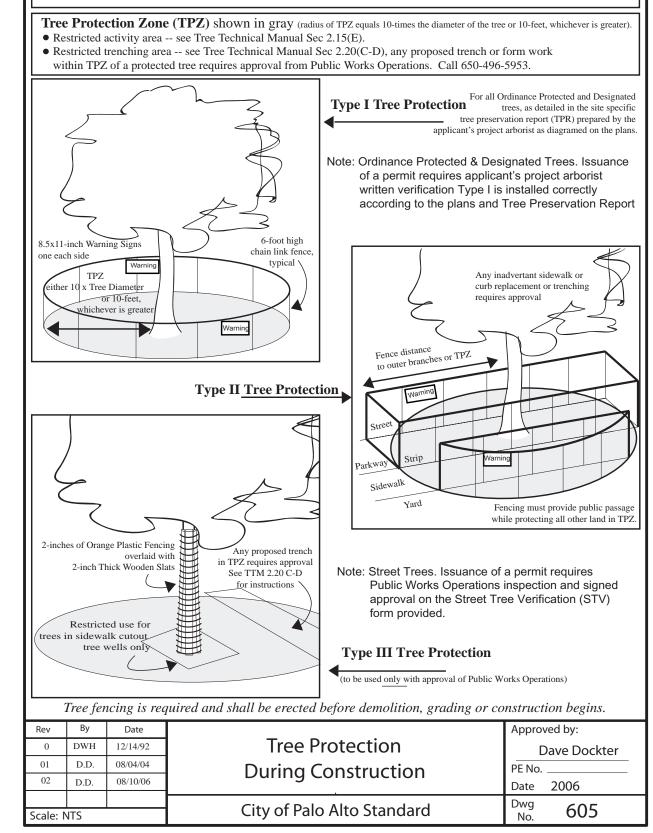

For written specifications associated with illustrations below, see Public Works Specifications Section 31

Detailed specifications are found in the Palo Alto Tree Technical Manual (TTM) (www.cityofpaloalto.org/trees/)

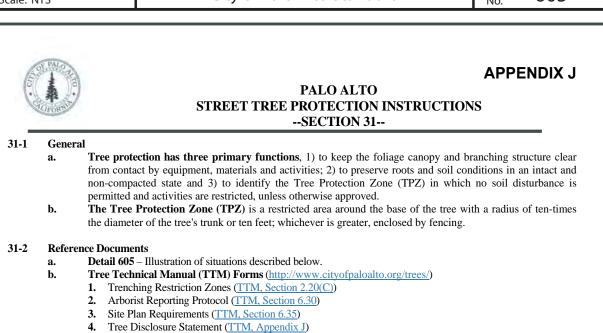

31-3 Execution Type I Tree Protection: The fence shall enclose the entire TPZ of the tree(s) to be protected throughout the life of the construction project. In some parking areas, if fencing is located on paving or concrete that will not be demolished, then the posts may be supported by an appropriate grade level concrete base, if approved by

Street Tree Verification (STV) Form (http://www.cityofpaloalto.org/trees/forms)

Type II Tree Protection: For trees situated within a planting strip, only the planting strip and yard side of the TPZ shall be enclosed with the required chain link protective fencing in order to keep the sidewalk and street open for public use

Type III Tree Protection: To be used only with approval of Public Works Operations. Trees situated in a tree well or sidewalk planter pit, shall be wrapped with 2-inches of orange plastic fencing from the ground to the first branch and overlaid with 2-inch thick wooden slats bound securely (slats shall not be allowed to dig into the bark). During installation of the plastic fencing, caution shall be used to avoid damaging any branches. Major limbs may also require plastic fencing as directed by the City Arborist. Size, type and area to be fenced. All trees to be preserved shall be protected with six (6') foot high chain

link fences. Fences are to be mounted on two-inch diameter galvanized iron posts, driven into the ground to a depth of at least 2-feet at no more than 10-foot spacing. Fencing shall extend to the outer branching, unless specifically approved on the STV Form. 'Warning' signs. A warning sign shall be weather proof and prominently displayed on each fence at 20-foot

intervals. The sign shall be minimum 8.5-inches x 11-inches and clearly state in half inch tall letters: "WARNING - Tree Protection Zone - This fence shall not be removed and is subject to a fine according to

Duration. Tree fencing shall be erected before demolition; grading or construction begins and remain in place until final inspection of the project, except for work specifically allowed in the TPZ. Work or soil disturbance in the TPZ requires approval by the project arborist or City Arborist (in the case of work around Street Trees). Excavations within the public right of way require a Street Work Permit from Public Works.

All neighbors' trees that overhang the project site shall be protected from impact of any kind. 2. The applicant shall be responsible for the repair or replacement plus penalty of any publicly owned trees that are damaged during the course of construction, pursuant to Section 8.04.070 of the Palo Alto

3. The following tree preservation measures apply to all trees to be retained: **a.** No storage of material, topsoil, vehicles or equipment shall be permitted within the TPZ. **b.** The ground under and around the tree canopy area shall not be altered.

c. Trees to be retained shall be irrigated, aerated and maintained as necessary to ensure survival.

Revised 08/06

END OF SECTION

City of Palo Alto 2004 Standard Drawings and Specifications Street Tree Verification of Protection, PWE, Section 31

SHEET NAME:

DOWNTOWN PARKING GARAGE | ARB 4.4 T1 SPECIAL TREE PROTECTION INSTRUCTION SHEET

Arborist F	-	of Palo Alto Tree Tech	mical Manual	ADDENDUM 1
.110011311	irm Data Here		RCA	em VISA Certified Arborist #WE-0 Contact Cel
	Monthly Tree A	activity Repo	rt- Constructi	ion Site
Inspection Date:	Site address:	Contractor- Main Site Contact Information	#1: Job site superir Company: Email: Job site	
#	Palo Alto, CA		Office: Cell: Mail:	
		Also present:	:	
Distribution		Attn: Dave Dockter	Dave.dockter@cityo 650-329-2440	fpaloalto.org
	2. Others equested minimum informat			
c. Dete 2. Field Obs a. Tree b. Tree 3. Action Ite a. Tree b. Roo	ect to verify that tree pro- ermine if field adjustment ervations (general site-we Protection Fences (TPF) aching has/will occur ems (list site-wide, by tree Protection Fence (TPF) t zone buffer material (we edule sewer trench, found	is, watering or plan re ide and list by individ) are e number and date to b needs adjusting (tree ood chips) can be inst	visions may be needed ual tree number) be satisfied) and Date I # x, x, x)	
	ohs (use often)			
5. Tree Loca	ation Map (mandatory 8.5	x 11 sheet)		
б. Recomme	endations, notes or monito	or items for project/sta	aff/schedule	
•				
7. Past visits	s (list carry-over items sat	tisfied/still outstandin	g)	
•				
	submitted,			
Respectfully	-			
Project site a		ide email, cell#, and n	nailing)	

---WARNING---**Tree Protection Zone**

This fencing shall not be removed without City Arborist approval (650-496-5953)

Removal without permission is subject to a \$500 fine per day*

*Palo Alto Municipal Code Section 8.10.110

City of Palo Alto Tree Protection Instructions are located at http://www.city.palo-alto.ca.us/trees/technical-manual.html

SPECIAL INSPECTIONS	PLANNING DEPARTMENT
TREE PROTECTION INSPEC	CTIONS MANDATORY
PAMC 8.10 PROTECTED TREES. CONTRACTOR SHALL ENS REQUIRED TREE INSPECTION AND SITE MONITORING. PROPERTY TO THE PLANNING DEPARTMENT LANDSCAPE F BUILDING PERMIT ISSUANCE.	OVIDE WRITTEN MONTHLY TREE ACTIVITY
BUILDING PERMIT DATE:	
DATE OF 1 ST TREE ACTIVITY REPORT:	
CITY STAFF:	
REPORTING DETAILS OF THE MONTHLY TREE ACTIVITY R VERIFY THAT ALL TREE PROTECTION MEASURES ARE IMP ACTIVITY, SCHEDULED OR UNSCHEDULED, WITHIN A TRI IS SUBJECT TO VIOLATION OF PAMC 8.10.080. REFER SECTION 2.00 AND ADDENDUM 11.	PLIMENTED AND WILL INCLUDE ALL CONTRACTOR EE PROTECTION ROOT ZONE. NON-COMPLIANCE

Apply Tree Protection Report on sheet(s) T-2

Use additional "T" sheets as needed

CLIENT NAME:

Palo Alto Tree Technical Manual

(See TTM, Verification of Tree Protection, Section 1.39).

involved, the Parks Manager (Contact 650-496-6962).

the project arborist at least 24 hours advance notice of such activity.

ALL CHECKED ITEMS APPLY TO THIS PROJECT:

Equipment, Section 2.20 C).

otherwise approved.

APPLICATION DATE:

APPLICANT'S NAME:

& FAX NUMBERS:

used is:

Inspected by:

Date of Inspection:

APPLICANT'S ADDRESS:

APPLICANT'S TELEPHONE

1. The Street Trees at the above

address(es) are adequately

2. The Street Trees at the above

modifications are required:

Indicate how the required

to the applicant.

Subsequent Inspection

to be adequately protected

S:PWD/OPS/Tree/DS/St.TreeProtect

Inpsected by:

Date of Inspection:

modifications were communicated

Street trees at above address were found

Notes: List City street trees by species,

site, condition and type of tree protection

Return approved sheet to Applicant for demolition or building permit issuance.

installed. Also note if pictures were

taken. Use back of sheet if necessary

protected. The following

address are **NOT** adequately

protected. The type of protection

ADDRESS/LOCATION OF STREET

This section to be filled out by City Tree Staff

TREES TO BE PROTECTED:

City of Palo Alto

PO Box 10250 Palo Alto, CA 94303

650/496-5953 FAX: 650/852-9289

treeprotection@CityofPaloAlto.org

Tree Department

Public Works Operations

CONTRACTOR & ARBORIST INSPECTION SCHEDULE

Reference: the Palo Alto Tree Technical Manual is available at www.cityofpaloalto.org/environment/

Inspection of Protective Tree Fencing. For Public Trees, the Street Tree Verification Form shall be

inspection of the trees and that the correct type of protective fencing is in place around the

Inspection of Rough Grading or Trenching. Contractor shall ensure the project site arborist performs an inspection during the course of rough grading or trenching adjacent to or within the

Monthly Tree Activity Report Inspections. The project site arborist shall perform a minimum monthly activity inspection to monitor and advise on conditions, tree health and retention or,

2154. (See TTM, Monthly Tree Activity Inspection Report, Addendum 11 & section 1.17).

Special activity within the Tree Protection Zone. Work in the TPZ area (see also #7 below) requires the direct onsite supervision of the project arborist (see TTM, Trenching, Excavation &

Landscape Architect Inspection. For discretionary development projects, prior to temporary or

on site inspection of all plant stock, quality of the materials and planting (see TTM, Planting

Quality, Section 5.20.1 A) and that the irrigation is functioning consistent with the approved

construction plans. The Planning Dept, landscape review staff shall be in receipt of written

verification of Landscape Architect approval prior to scheduling the final inspection, unless

List Other (please describe as called out in the site Tree Preservation Report, Sheet T-1, T-2, etc.)

Applicant Instructions: Complete upper portion of this form. Mail or FAX this form along with signed Tree

Disclosure Statement to Public Works Dept. Public Works Tree Staff will inspect and notify applicant.

Verification of

Street Tree Protection

NO* □

NO* □

* If NO, indicate in "Notes" below the disposition of case.

* If NO, go to #2 below

YES 🗌

final occupancy the applicant or contractor shall arrange for the Landscape Architect to perform an

immediately if there are any revisions to the approved plans or protection measures. The Tree

Technical Manual Monthly Tree Activity Report format shall be used and sent to the Planning Dept. landscape review staff no later than 14 days after issuance of building permit date. Fax to (650) 329-

signed by the City Arborist. For Protected Trees, the project site arborist shall provide an initial Monthly Tree Activity Report form with a photograph verifying that he has conducted a field


designated tree protection zone (TPZ) prior to issuance of a demolition, grading, or building permit.

Pre-Construction Meeting. Prior to commencement of construction, the applicant or contractor shall conduct a pre-construction meeting to discuss tree protection with the job site superintendent,

grading operators, project site arborist, City Arborist, and, if a city maintained irrigation system is

TPZ to ensure trees will not be injured by compaction, cut or fill, drainage and trenching, and if


required, inspect aeration systems, tree wells, drains and special paving. The contractor shall provide

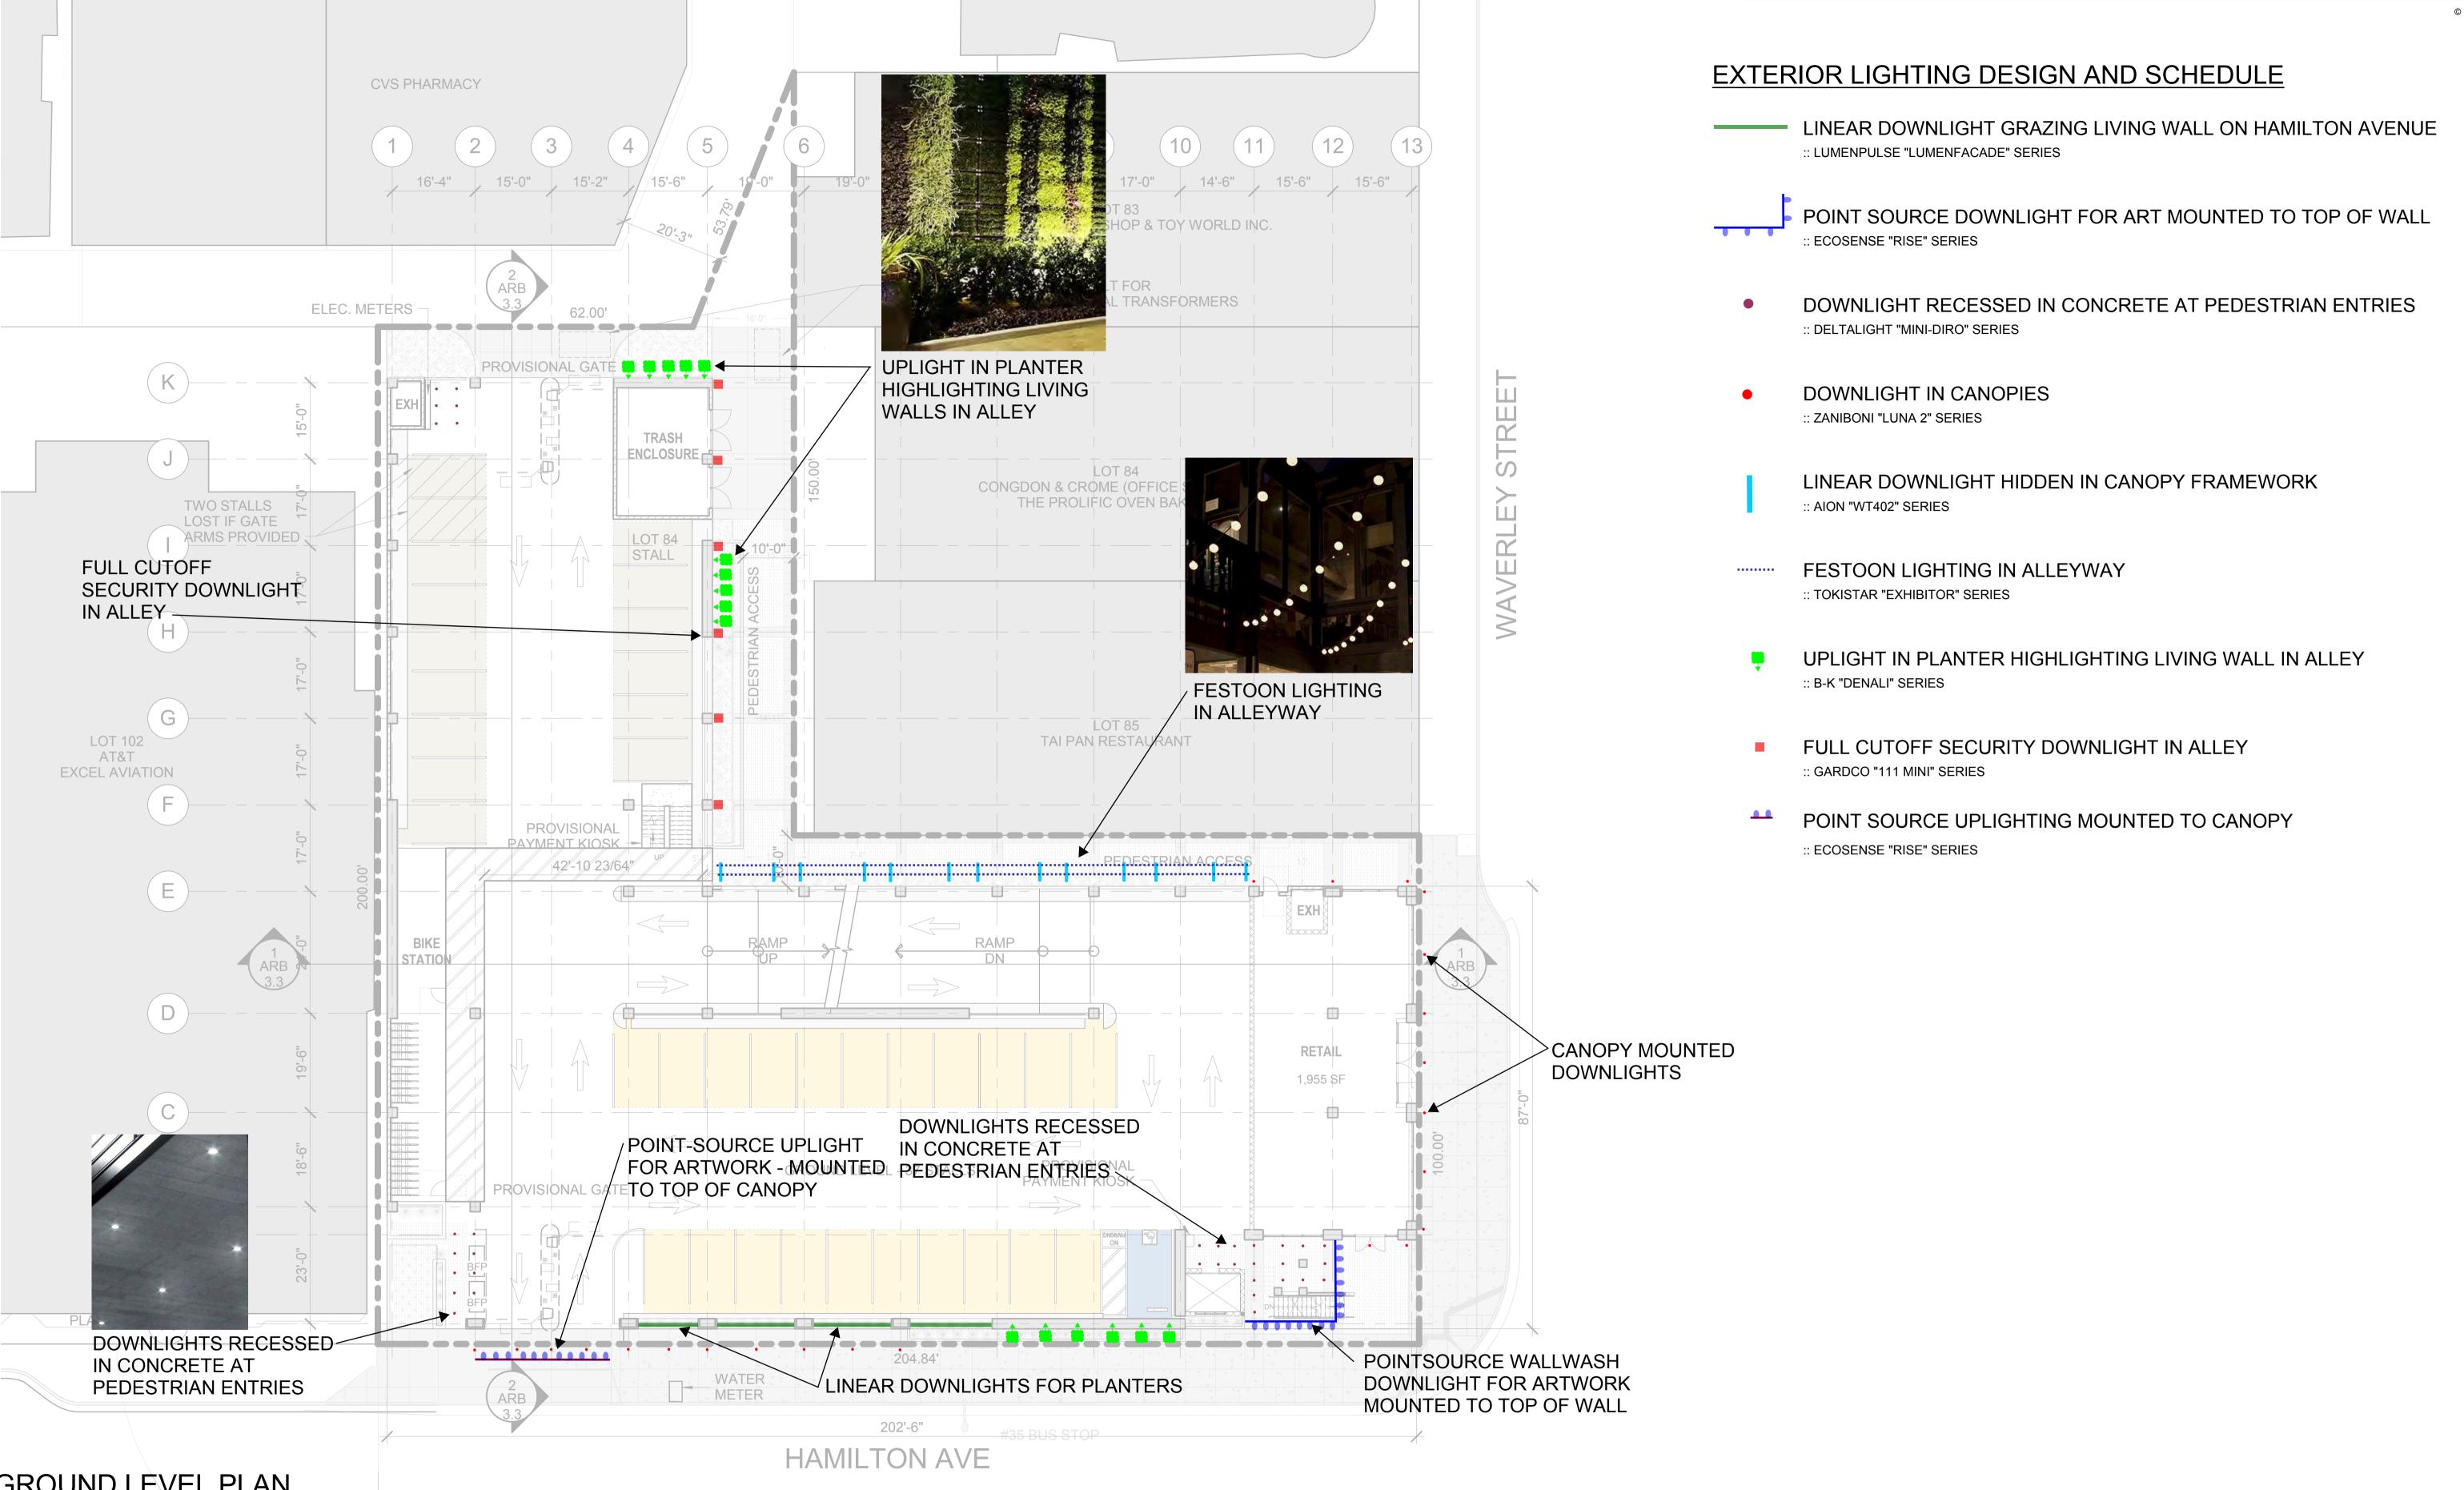


GROUND LEVEL PLAN





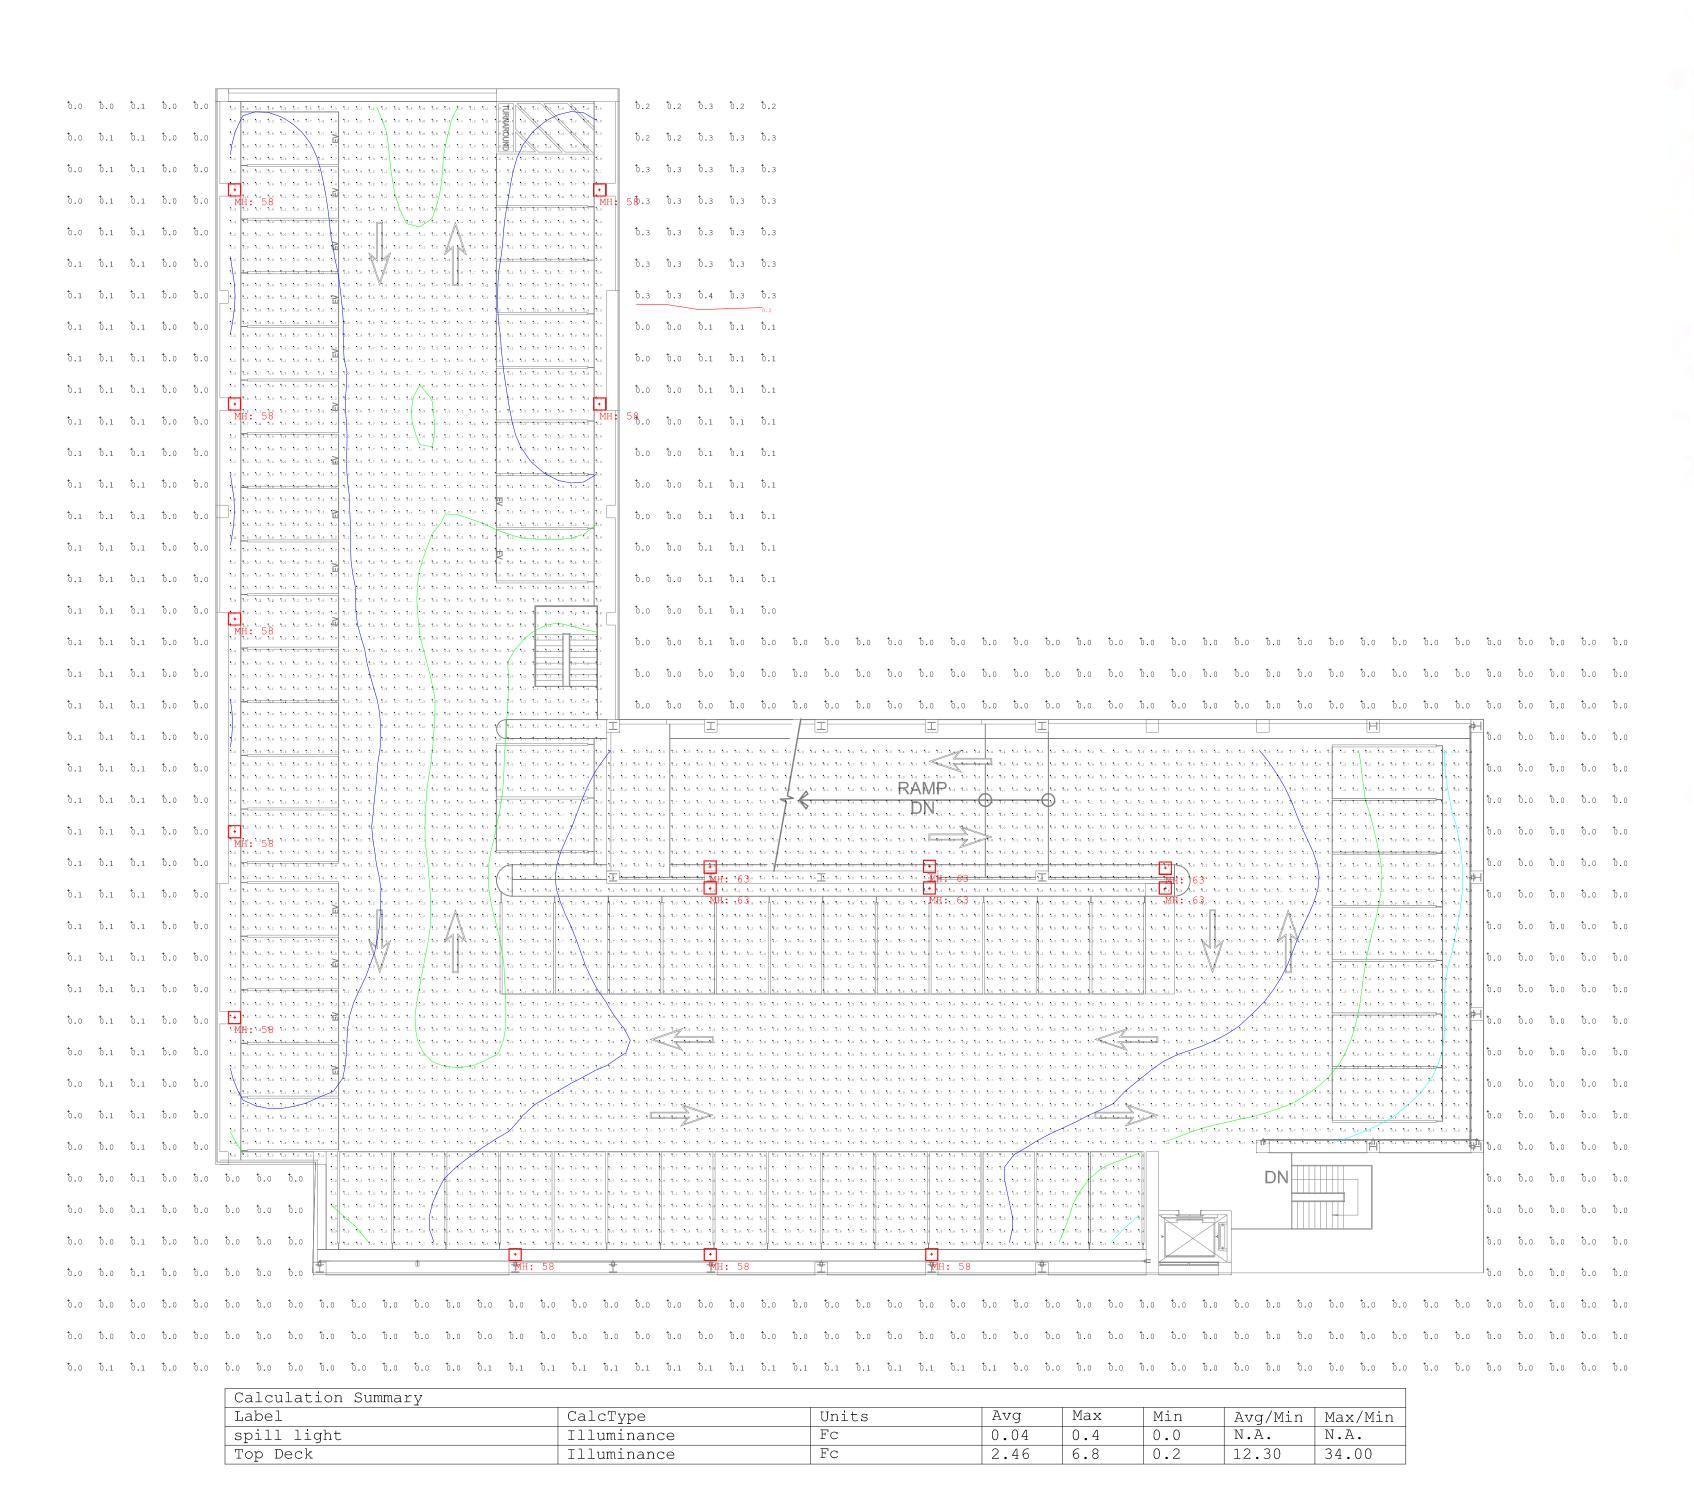

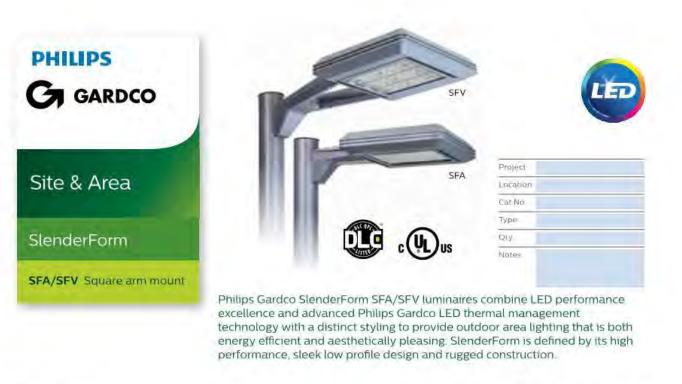

Prefix	Number of LEDs	Drive Current	LED Color - Generation	Mounting	Distribution	Voltage	Controls	Electrical	Luminaire	Finish
	-		-	AR -	-	-	-		-	
SFA SlenderForm Square Standard Arm Mount luminaire SFV SlenderForm	32L 32 LEDs	250 250mA 500 500mA	NW-G2 Neutral White 4000K, 70CRI Gen 2	AR Arm mount	Z Type 2 2-90 Type 2 Rotated left 90	120 120V 208 208V 240	O-IOV Dimming Driver ^a Infrared Motion Response Systems IMRI3	Fusing F1 Single (120, 277, 347VAC) ² F2	SPA1 Square Pole Adapter (for use with SFA only)	Textured BK Black WH
	48L 48 LEDs	700mA 850	WW-G2 Warm White		2-270 Type 2 Rotated	240V 277	Integral with #3 lens DynaDimmer	Double (208, 240, 480VAC)	SPA2 Square Pole Adapter	White BZ Bronze
Square "V" Arm Mount luminairè	64 LEDs.	850mA	3000K 70CRI Gen 2 CW-G2 Cool White 5700K 70CRI Gen 2		right 270° 3 Type 3 3-90 Type 3 Rotated left 90° 3-270 Type 3 Rotated right 270° 4 Type 4 4-90 Type 4 Rotated left 90° 4-270 Type 4 Rotated right 270° 5 Type 5	277V 347 347V 480 480V UNV 120-277V (50/60Hz) HVU 347-480V (50/60Hz)	Automatic Profile Dimming CS50 Safety 50% Dimming, 7 hours¹ CM50 Median 50% Dimming, 8 hours¹ CE50 Economy 50% Dimming, 9 hours¹ DA50 All Night 50% Dimming¹ Photoelectric/Receptacle Systems PCB Photocontrol Button²¹ TLRD5 Turist Lock Receptacle 5-Pin TLRD7 Twist Lock Receptacle 7-Pin TLRD7 Twist Lock Receptacle with Photoc Pole Mounted Infrared Motic Response Systems with Dynic CS50-IMRO with Safety 50% CM50-IMRO with Median 50% CE50-IMRO with All Night 50 DA50-IMRO with All Night 50%	on aDimmer Dimming ¹⁷ & Dimming ¹⁷ D% Dimming ¹⁷	(for use with SFV only) HIS Internal House Side Shield ¹ DL Diffuse lens ³	DGY Dark Gray MGY Medium Gray Customer specified RAL Specify option: color or RAL (ex OC-RAL70; CC Custom color (Must supply color chip for required factor quote)

PROPOSED LUMINAIRE FOR TOP DECK LIGHTING INTEGRAL MOTION DETECTOR TO REDUCE LIGHTING TO 20% WHEN VACANT


(See accessories page) 8. Not available with 64L

SlenderForm_SFA_SFV_LED_04/17_page 1 of 5




DATE ISSUED:




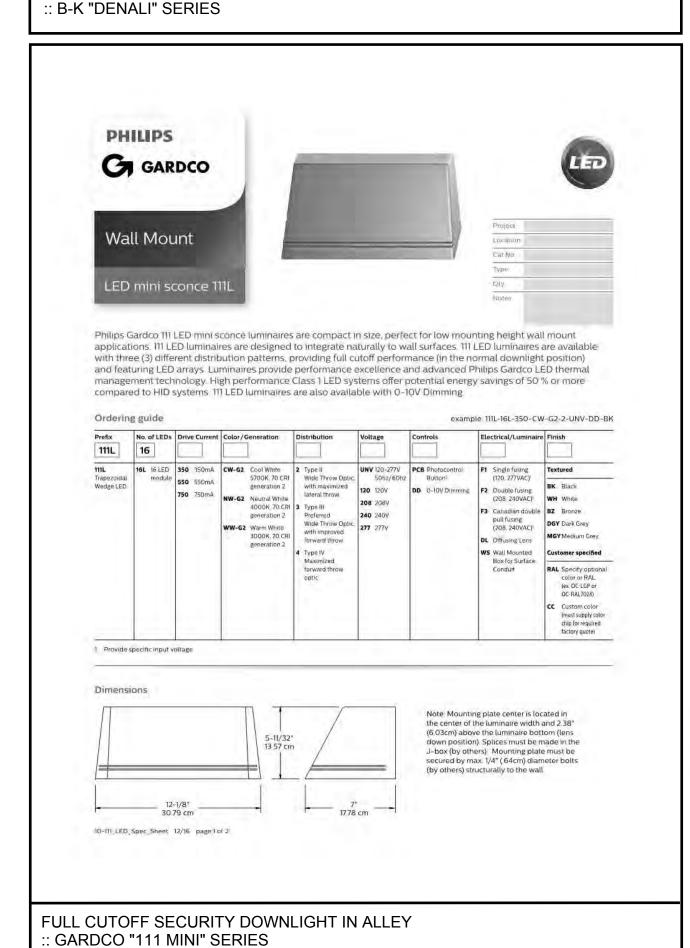




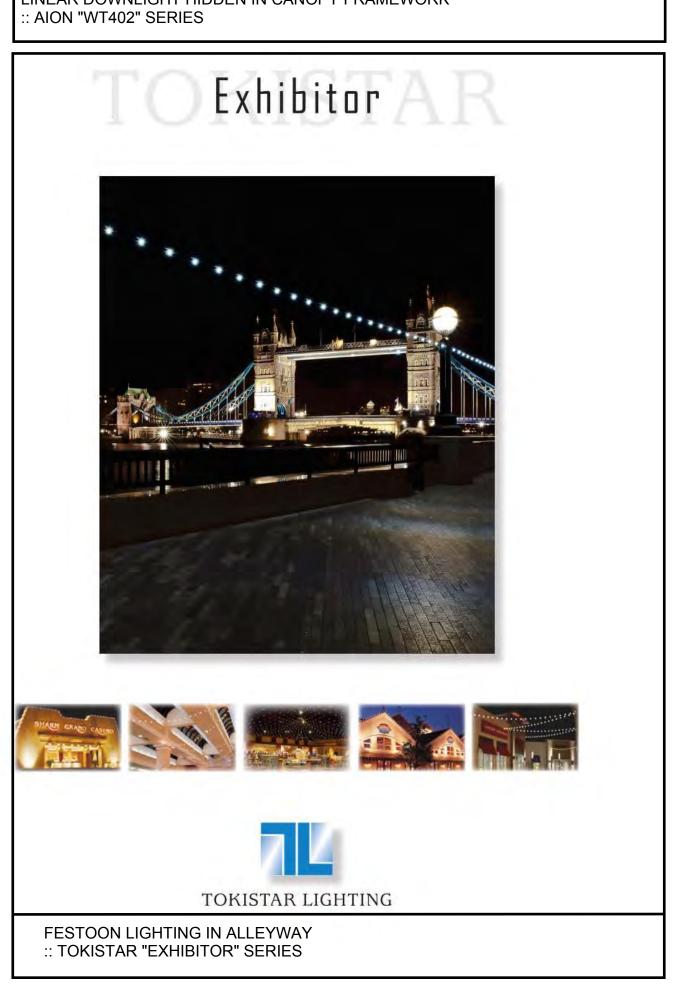




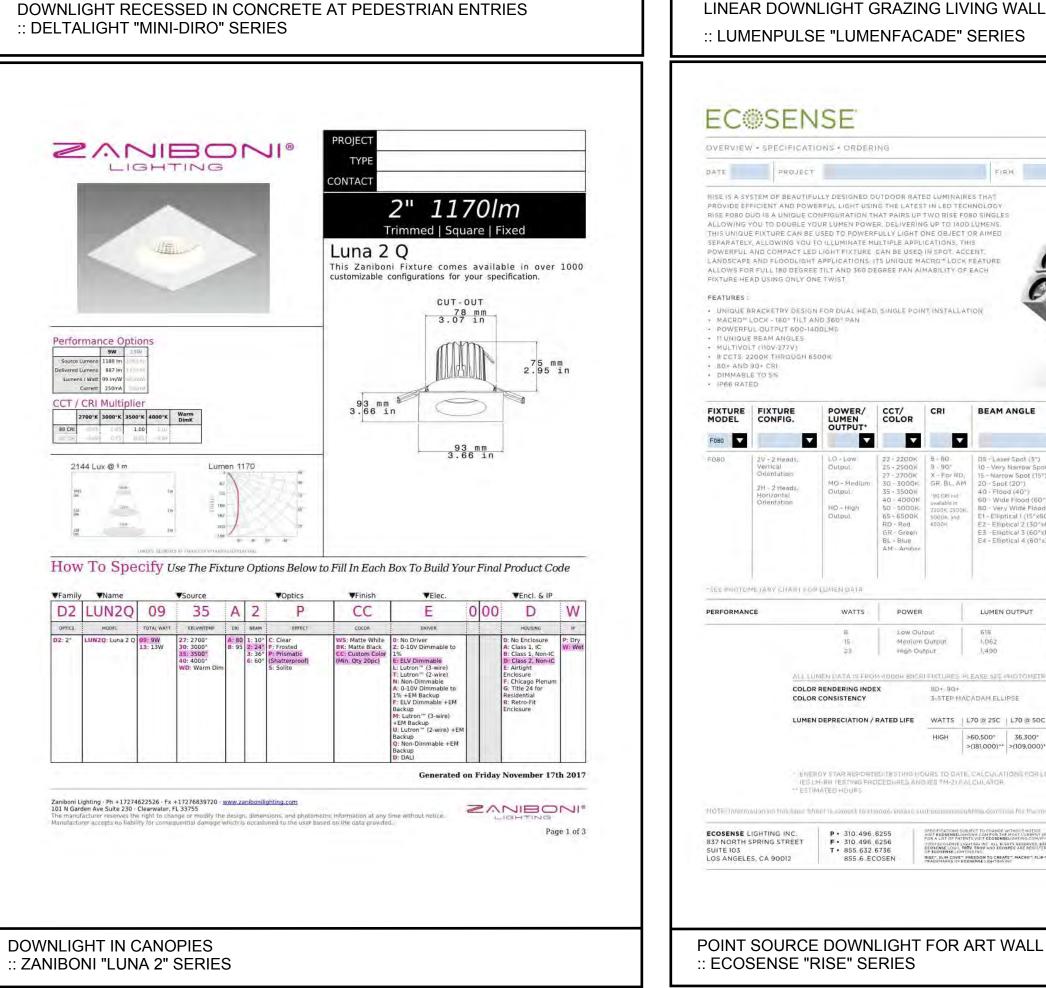

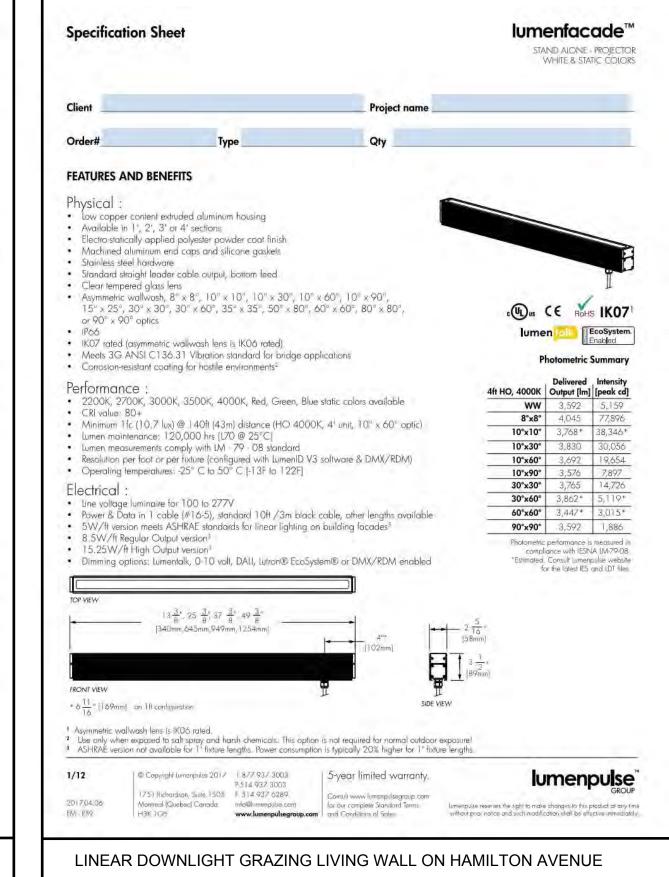

© WATRY DESIGN, INC. 2017


RISE

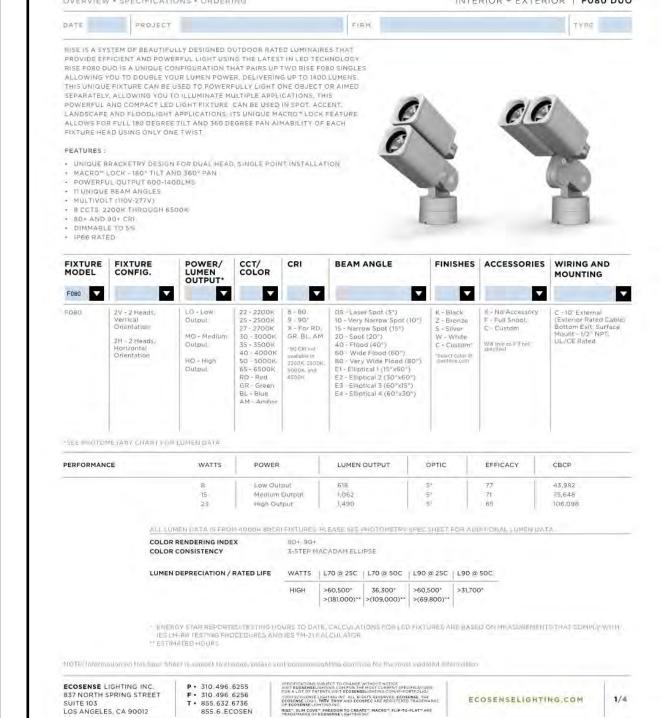




CLIENT NAME:


DOWNTOWN PARKING GARAGE

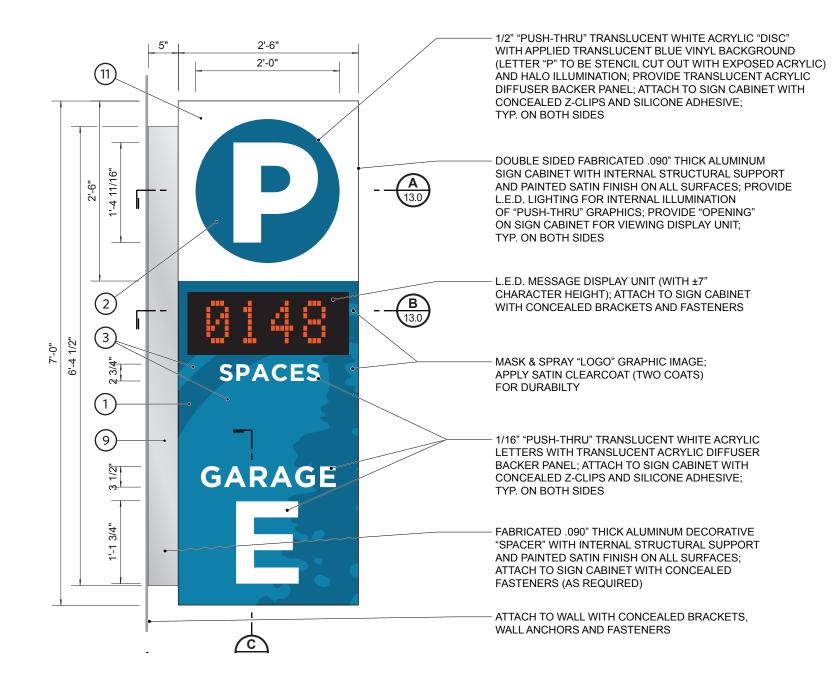



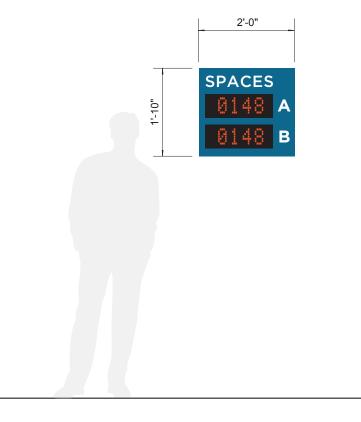



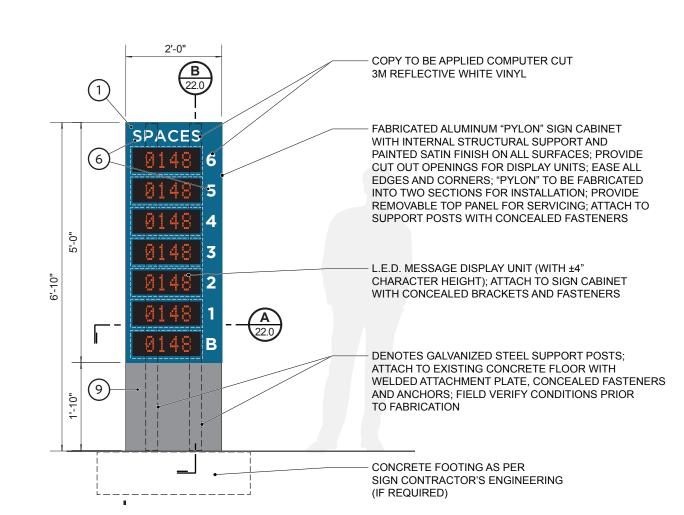





PARKING GUIDANCE SYSTEMS

Stall indicators and parking guidance signs will be used throughout the structure as part of the City's parking infrastructure development.

Dynamic signage will mitigate any impact of dead end parking area.

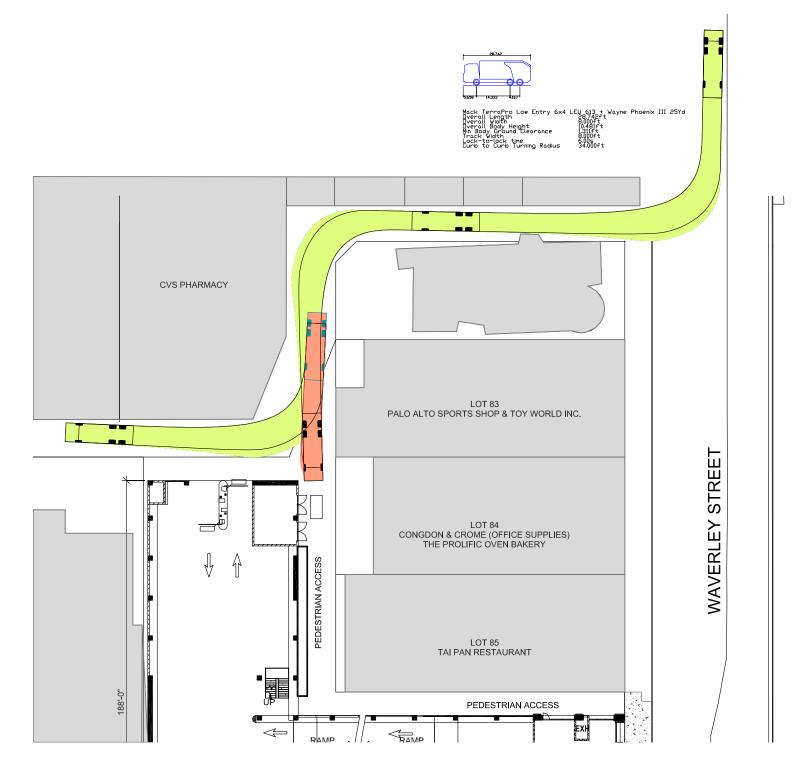

Refuse Truck Turning Arc

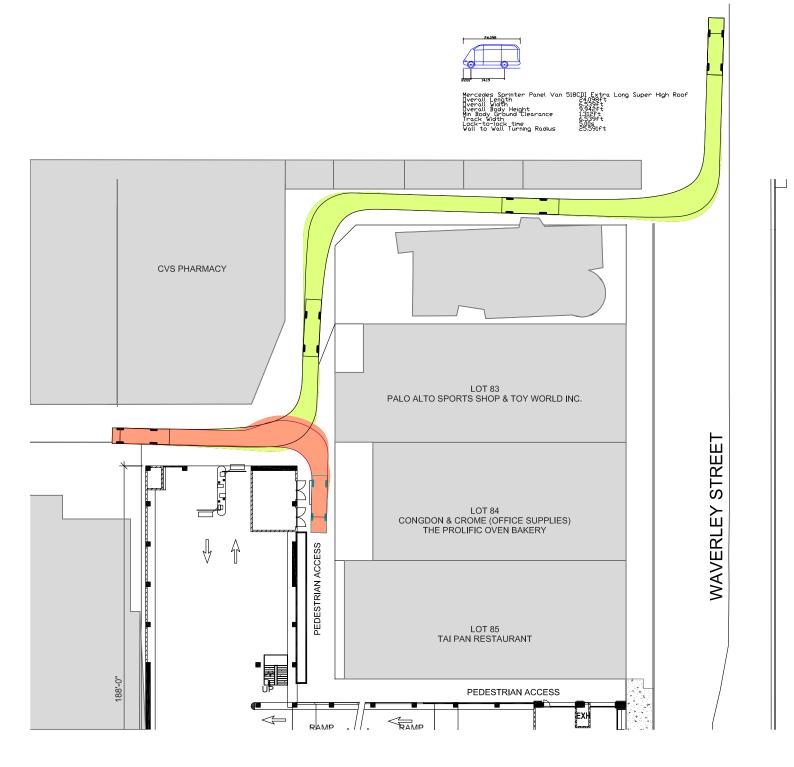

Delivery Vehicle Turn Arc



