



STANFORD SHOPPING CENTER
180 EL CAMINO REAL, # 705 A, BLDG. E, PALO ALTO, CA 94304



ARB PERMIT SET
JULY 05, 2022 I GA21-MLT004

PROJECT TEAM

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180 EL CAMINO REAL, SUITE 705A, BLDG. E,
PALO ALTO, CALIFORNIA 94304

Stanford Shopping Center Parking and Loading Tabulation

7/5/2022 The MELT

Gross Floor Area For Parking							
Building #	Basement	Ground Floor	Mezzanine	2nd Floor	3rd Floor	Outdoor Area	Total
Bloomingdale's A (Phase II)*		123,678					123,678
WB (approved/future)		28,741	0				
EE (approved/future)		6,749					
RH (approved)		17,731		15,524	8,613		41,868
C-South		30,738		6,979			37,717
C-North		24,844		11,680			36,524
D		62,859		13,025		222	76,106
E		27,451		12,512		2,318	42,281
F	15,458	43,410		5,127			63,995
New Flemings (Phase I)		7,220				1,291	8,511
H		21,584		475			22,059
J		8,075		1,418			9,493
Macy's K*		225,830					225,830
L		23,610		2,446		589	26,645
M		55,048		13,492			68,540
N		20,402		325			20,727
P		9,955					9,955
Neiman Marcus*		120,000					120,000
V		31,567		32,573			64,140
W		10,608				1,385	11,993
Phase III							
AA		29,305					29,305
BB		25,978		25,915		174	52,067
CC		16,402					16,402
DD		16,823		16,824			33,647
Subtotal by Level	15,458	988,608	0	158,315	8,613	5,979	1,141,483.0
Nordstrom*		180,000					180,000
Container Store	5,534	24,116		8,651			38,301
Crate&Barrel		39,173					39,173
Subtotal by Level	5,534	243,289	0	8,651	0	0	257,474
TOTAL	20,992	1,231,897	0	166,966	8,613	5,979	1,398,957

Bicycle Parking:	Short Term (Racks)	Long Term (Lockers)	TOTAL
Required bicycle spaces 1/2,750 sf (40% long term and 60% short term)	305	203	509
Existing bicycle spaces (per macys mens redevelopment)	254	97	351
Cargo Bike	4		
Deficient Bike Parking	47	106	182

Loading Space	Req 3/120k	Req 1/50k sf of	Required	Existing	Proposed	Deficient
3/70,000 -120,000 sf with 1 additional space per 50,000 sf over 120,000 sf	3 spaces (3 per 1st 120,000 sf)	26 spaces (based on 1,311,357	29 spaces	24 spaces	25 spaces	4 spaces

Parking Provided by Space Type	Notes	Regular	ADA	EVSE	EV (Ready)	ADA EVSE/Ready***	x2 PK EVSE	Dedicated Parking	TOTAL
Required Parking Spaces 1/275 GFA	5087	5,087							
Existing Parking Spaces	As of 3/27/2019	5,218	101	29	96			-96	
Proposed Parking Spaces					37			-37	
Dedicated Parking - Tesla	16PLN-00040							-6	
Loss of Physical Parking Spaces		-54							
Total Parking Spaces		5,167	101	29	133			-139	5,291
Excess number of spaces (Proposed - Required and Dedicated Spaces)									204

Per AB1100: EVSE & EV Ready Van accessible & accessible spaces adjacent to an accessible path of travel are counted x2 towards the parking total

Net Floor Area For Entitlements*							
Building #	Basement	Ground Floor	Mezzanine	2nd Floor	3rd Floor	Outdoor Area	Total
Bloomingdale's A (Phase II)*		117,494					117,494
WB (approved/future)		28,741	0				
EE (approved/future)		6,749					
RH (approved)		17,731		15,524	8,613		41,868
C-South		30,738		6,979			37,717
C-North		24,844		11,680			36,524
D		62,859		13,025			75,884
E		27,451		12,512			39,963
F	15,458	43,410		5,127			63,995
New Flemings (Phase I)		7,220					7,220
H		21,584		475			22,059
J		8,075		1,418			9,493
Macy's K*		225,830					225,830
L		23,610		2,446			26,056
M		55,048		13,492			68,540
N		20,402		325			20,727
P		9,955					9,955
Neiman Marcus*		120,000					120,000
V		31,567		32,573			64,140
W		10,608					10,608
Phase III							
AA		29,305					29,305
BB		25,978		25,915			51,893
CC		16,402					16,402
DD		16,823		16,824			33,647
Subtotal by Level	15,458	982,424	0	158,315	8,613	0	1,112,029
Nordstrom*		180,000					171,000
Container Store		24,116					24,116
Crate&Barrel		39,173					39,173
Subtotal by Level	0	243,289	0	0	0	0	234,289
TOTAL	15,458	1,225,713	0	158,315	8,613	0	1,346,318
Allowable NFA**							1,412,362
Available NFA							66,044


NOTES:

* Includes 5% reduction in Anchor Store GFA for space classified as 'non-occupied' to calculate NFA per COPA Planning Dept. letter dated Apr. 23, 2014. Note that the Redevelopment Phase I table (Existing as of 5/23/12) pre-dated this agreement, thus did not take into account the 5% reduction for NFA, therefore some figures will differ.

** per PAMC Ch. 18.16.060(e) and COPA Planning Dept. letter dated Feb. 27, 2014.

395 Quarry Road (Bank of America) has been deleted from this table. The site has an existing 4,185 sf building, 21 parking spaces and is zoned CN. The property is managed by Simon, but is not counted towards Stanford Shopping Center FAR (Gross & Net) as it is not within the PAMC 18.16.030(d) definition of "Stanford Shopping Center" properties which are defined as all properties zoned CC and bounded by El Camino Real, Sand Hill Road, and Vineyard Lane.

Per AB1100: EVSE & EV Ready Van accessible & accessible spaces adjacent to an accessible path of travel are counted x2 towards the parking total

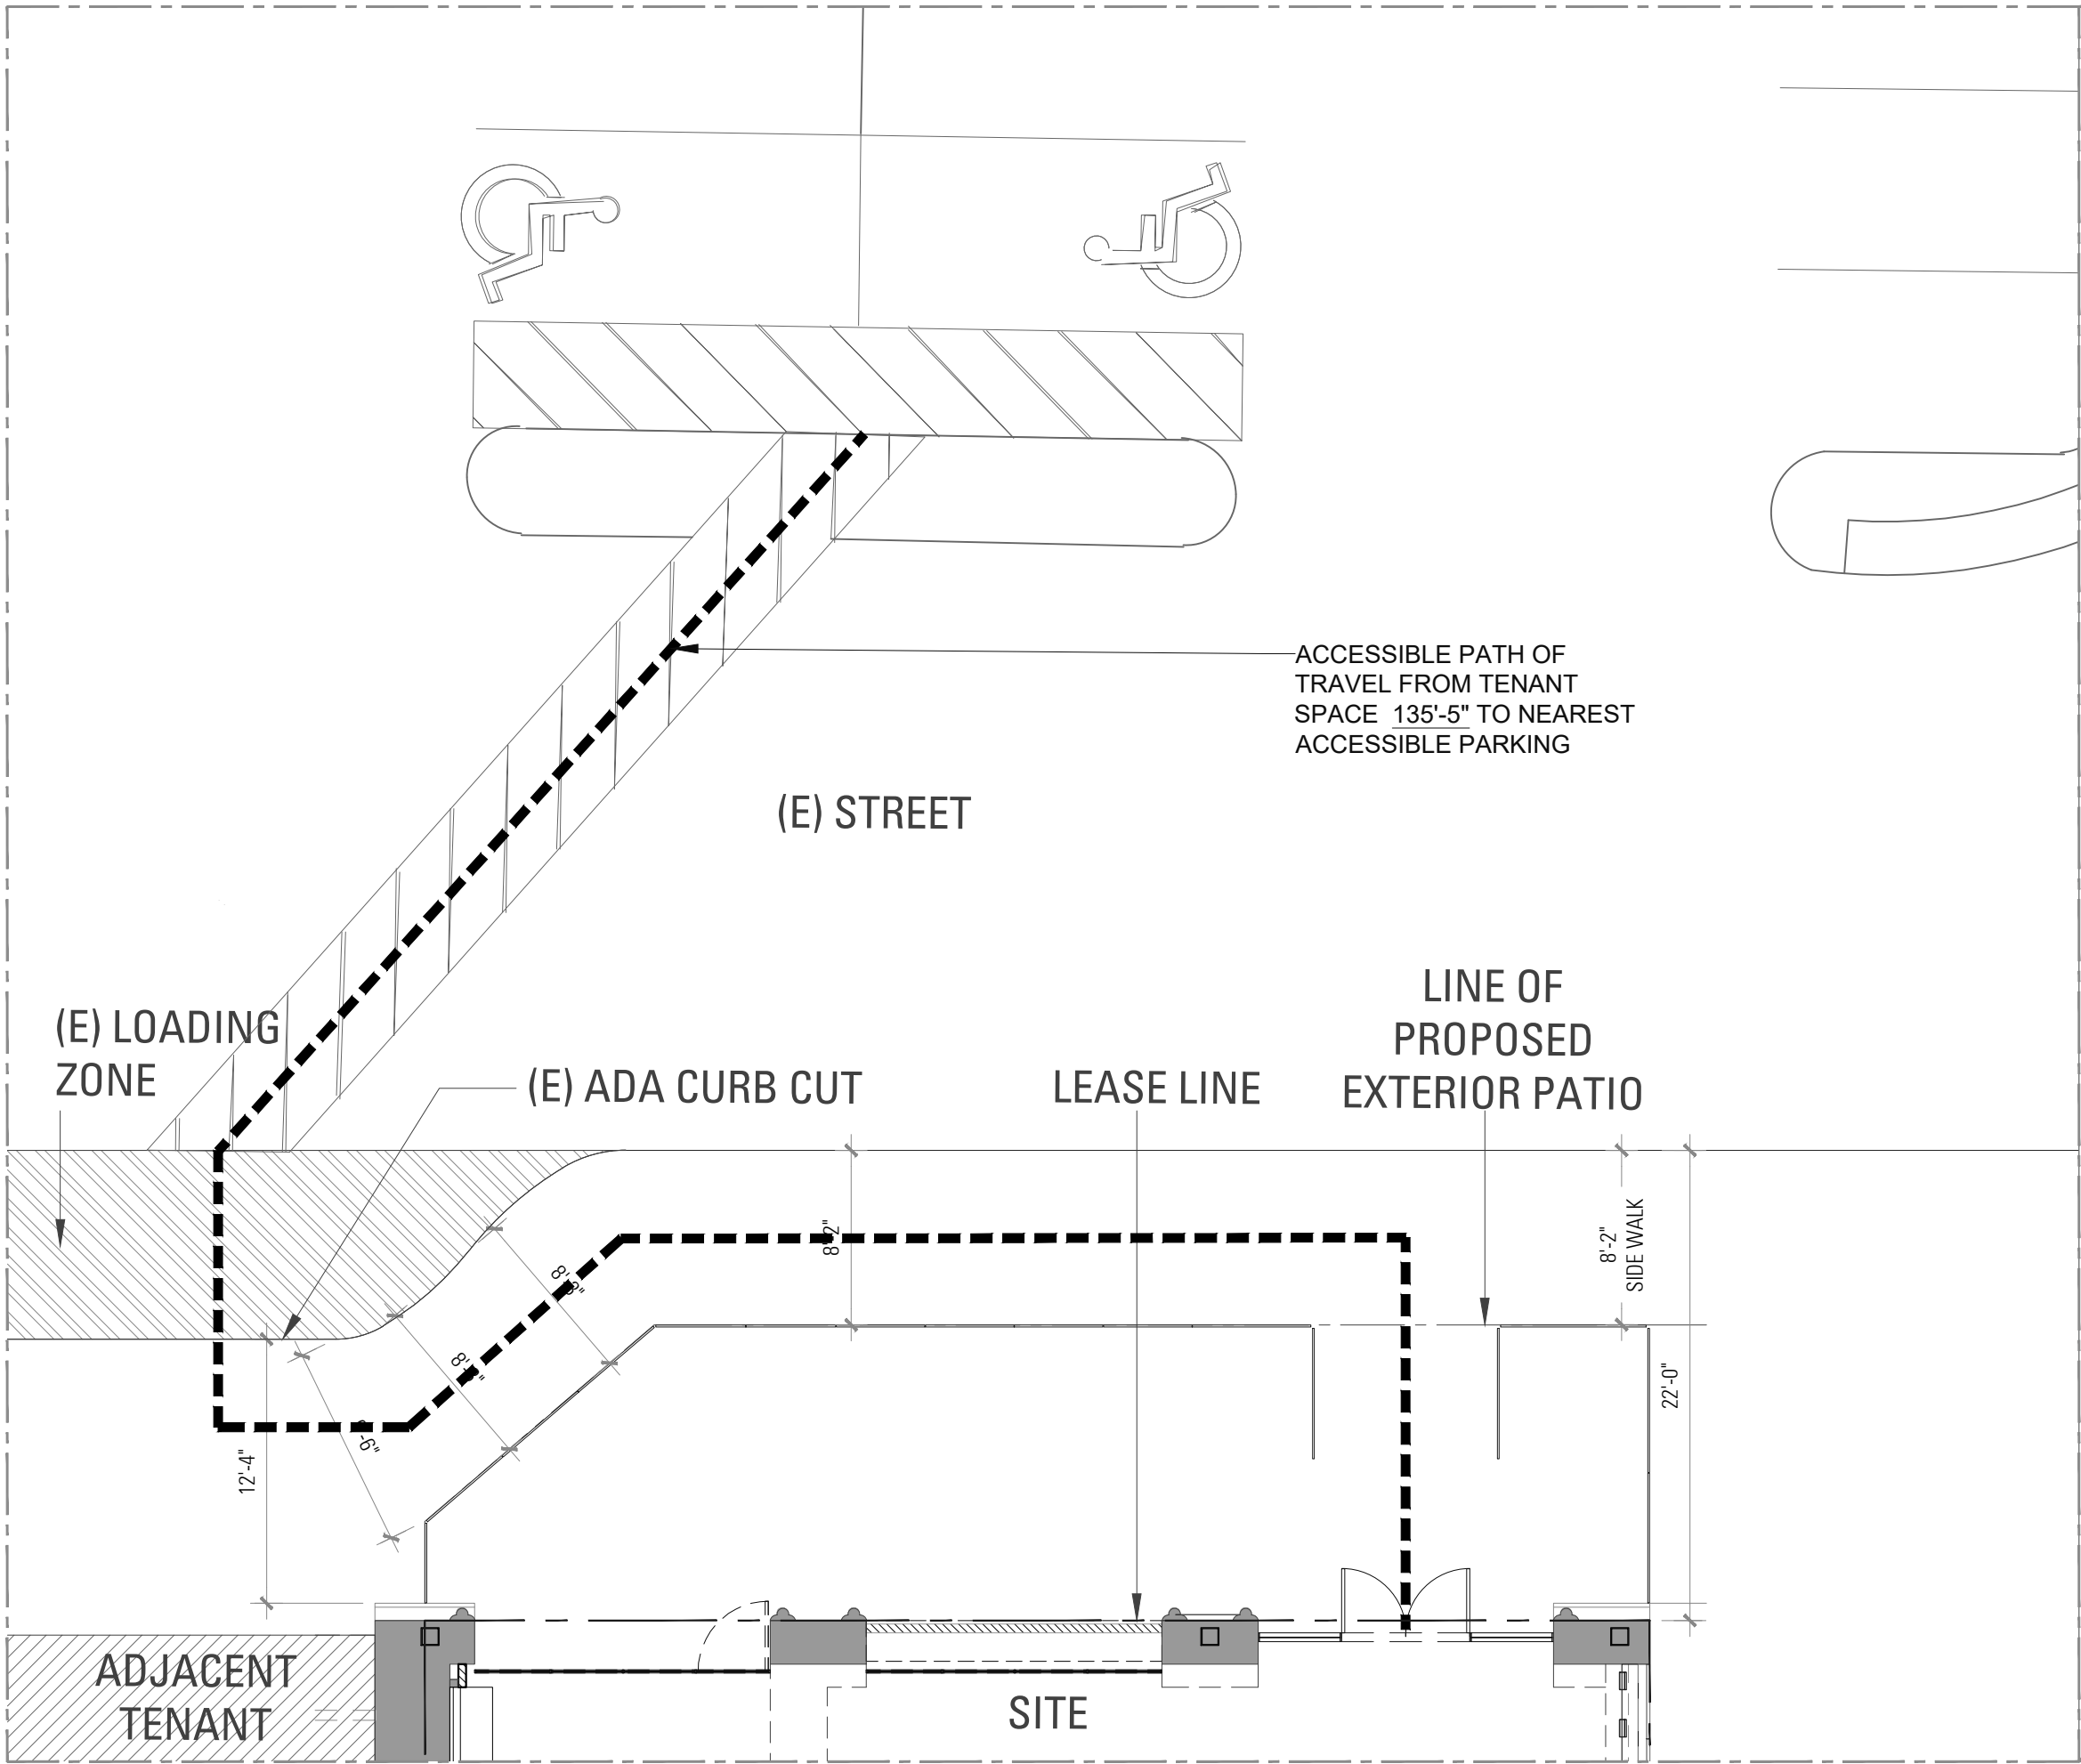

2 ENLARGED PLAN
1/8" = 1'-0"



1 STANFORD SHOPPING CENTRE PLAN
1/128" = 1'-0"

- HAZARD & EGRESS NOTES:
1. PROVIDE 80° HEADROOM FROM THE WALKWAY SURFACE TO ANY OVERHANGING OBSTRUCTION
 2. HEADROOM OF 80° MINIMUM SHALL BE MAINTAINED FOR WALKS, CORRIDORS, AISLES, ETC
 3. OBSTRUCTIONS WITHIN THE WALK PATHWAY (i.e. POLES OR FIRE HYDRANTS SHALL PROVIDE A 36° MIN. CLEAR WIDTH TO THE EDGE OF THE WALK.
 4. PROTRUDING OBJECTS WITH LEADING EDGES BETWEEN 27° AND 80° ABOVE THE FINISHED FLOOR ABOVE THE FINISHED FLOOR LEVEL SHALL NOT PROTRUDE MORE THEN 4" INTO WALKS, CORRIDORS, ETC.
 5. OBJECTS WITH PROTRUDING EDGES LESS THAN 27° ABOVE THE FINISHED FLOOR MAY PROTRUDE ANY AMOUNT.
 6. FREE-STANDING OBJECTS MOUNTED ON POSTS BETWEEN 27° AND 80° ABOVE THE FLOOR MAY PROJECT A MINIMUM OF 12".
 7. FREE-STANDING SIGNS WHERE THE BOTTOM IS EDGE IS AT OR LESS THAN 80° ABOVE THE FINISHED FLOOR SHALL HAVE THE EDGES ROUNDED OR EASED WITH A MIN. RADIUS OF 1/8".
 8. ABRUPT CHANGES IN LEVEL OF 4" OR MORE ADJACENT TO WALKS, EXCEPT BETWEEN WALKS AND ADJACENT STREETS OR DRIVES, SHALL BE IDENTIFIED BY 6" HIGH WARNING CURBS ABOVE THE WALK SURFACE.
- NOTE: PRIOR TO STOCKING THE STORE, THE FOLLOWING SHALL BE COMPLETED IN ORDER:
- A. A COMPLETED SAFE PATH OF TRAVEL IS PROVIDED INSIDE THE BUILDING.
 - B. THE INSIDE SHALL BE COMPLETED AND SIGNED OFF BY THE BUILDING INSPECTOR.
 - C. THE FIRE DEPARTMENT PROVIDED A RELEASE FOR STOCKING SHELVES
 - D. THE BUILDING INSPECTOR HAS THE FINAL WORD IF IT WILL BE SAFE FOR EMPLOYEES TO STOCK SHELVING IN A CONSTRUCTION SITE.

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STAMP & SEAL:

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CLIENT:

theMELT

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180 EL CAMINO REAL, SUITE 705A, BLDG. E,
PALO ALTO, CALIFORNIA 94304

PROJECT:

PROJECT#: GA21-MLT004
DOCUMENT DATE: 07-05-22
DOCUMENT PHASE:

ARB SET


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ISSUE: ARB SET

DRAWN BY: NR
CHECKED BY: KCR
SHEET TITLE:

SITE PLAN & PARKING INFO

SHEET NUMBER

G00.20

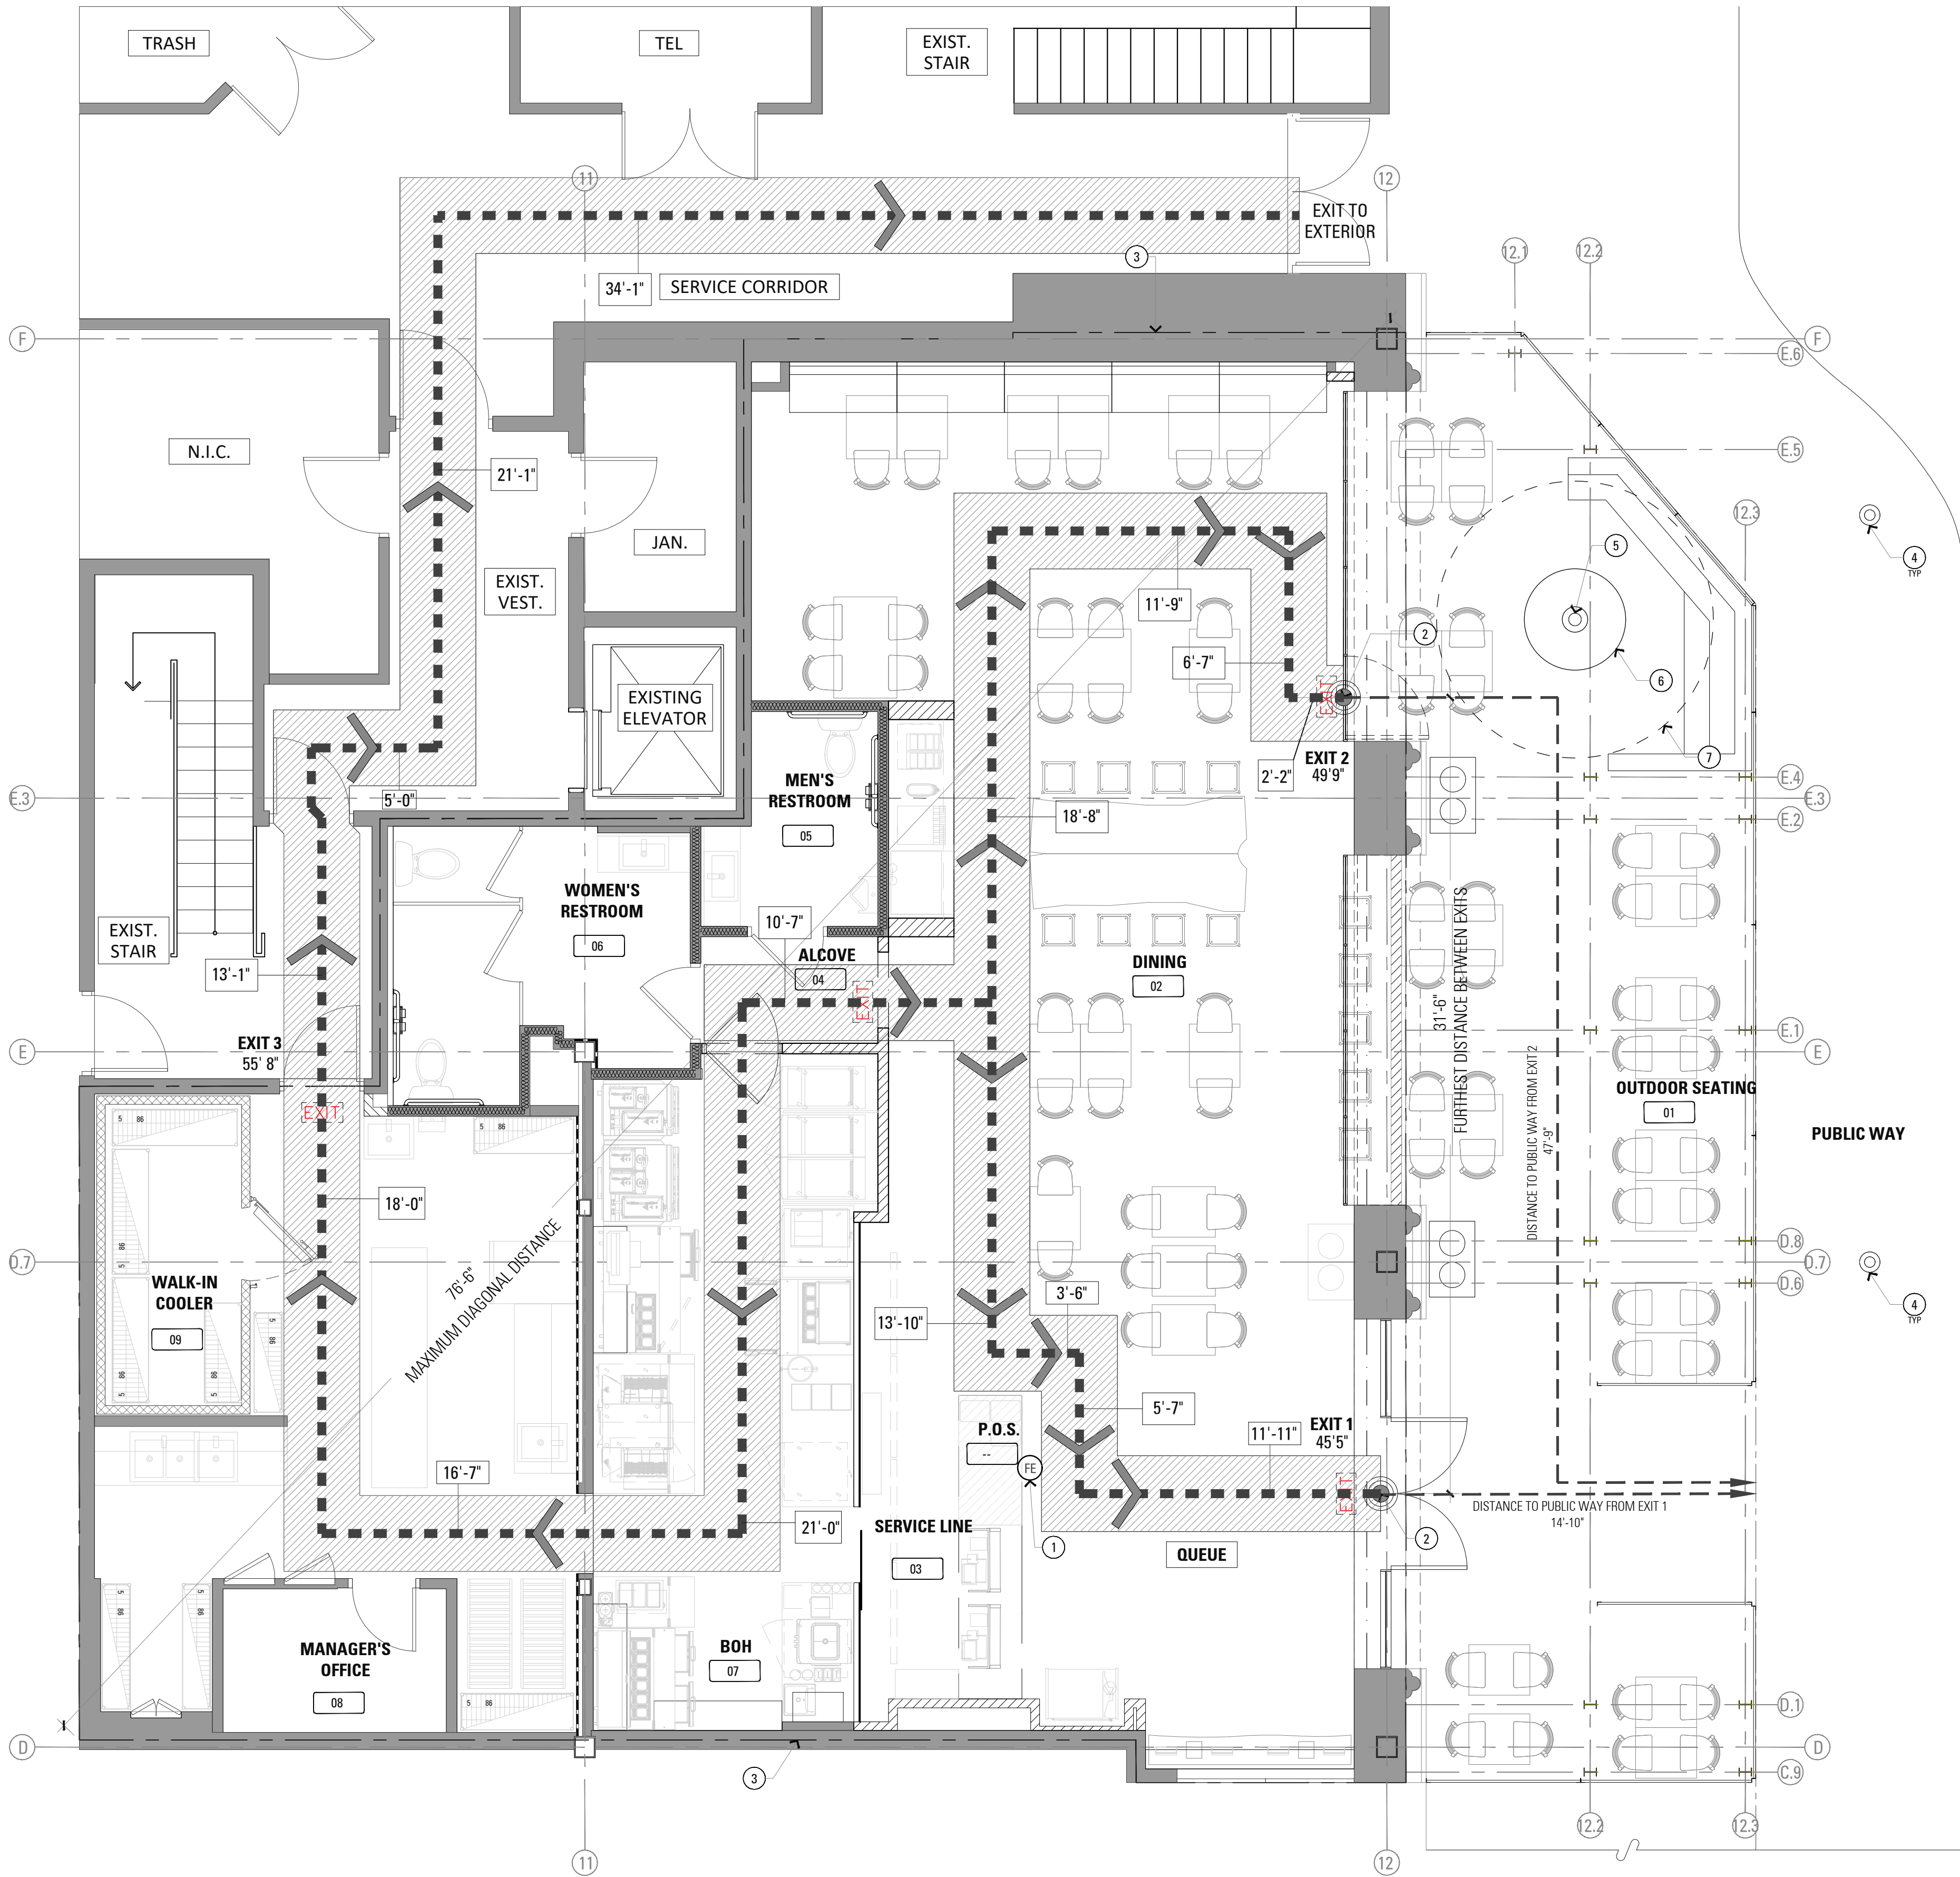

LIFE SAFETY KEYNOTES

- 1 FIRE EXTINGUISHER LOCATION
- 2 EXIT SIGN
- 3 1 HOUR SEPARATION
- 4 STREET LIGHTS (E)
- 5 TRUNK OF TREE (N)
- 6 4' DIA ADA COMPLIANT TREE GRATE (N)
- 7 CANOPY OF TREE (N)

COMPLIANCE NOTES

THIS PROJECT CONSISTS OF THE BUILD-OUT OF A RETAIL TENANT. DUE TO THE NATURE OF THE PROJECT, THE SCOPE OF CONSTRUCTION WITHIN THE DOCUMENTS CONSISTS ONLY OF AREA WITHIN THE LEASED PREMISES.

ALL ASPECTS OF THIS PROJECT REQUIRED TO CONFORM TO ACCESSIBILITY REQUIREMENTS FOR FEDERAL GUIDELINES SHALL ALSO DO.

EXTINGUISHERS:

- G.C. TO PROVIDE MIN. OF 1 FIRE EXTINGUISHERS. G.C. TO VERIFY AND COORDINATE LOCATIONS AND QUANTITIES WITH LOCAL FIRE MARSHAL.
- NFPA INSPECTION TAGS SHALL BE ATTACHED TO ALL FIRE EXTINGUISHERS.
- PORTABLE FIRE EXTINGUISHERS SHALL BE PROVIDED PER LOCAL FIRE CODE. TYPE AND LOCATIONS OF EXTINGUISHERS SHALL BE AS DIRECTED BY THE FIRE DEPARTMENT.

LIFE SAFTEY LEGEND

- DIRECTION OF TRAVEL
- EXIT
- 36" MIN. EGRESS EXIT PATH
- EXIT ACCESS TRAVEL DISTANCE
- EXIT SIGN
- FIRE EXTINGUISHER

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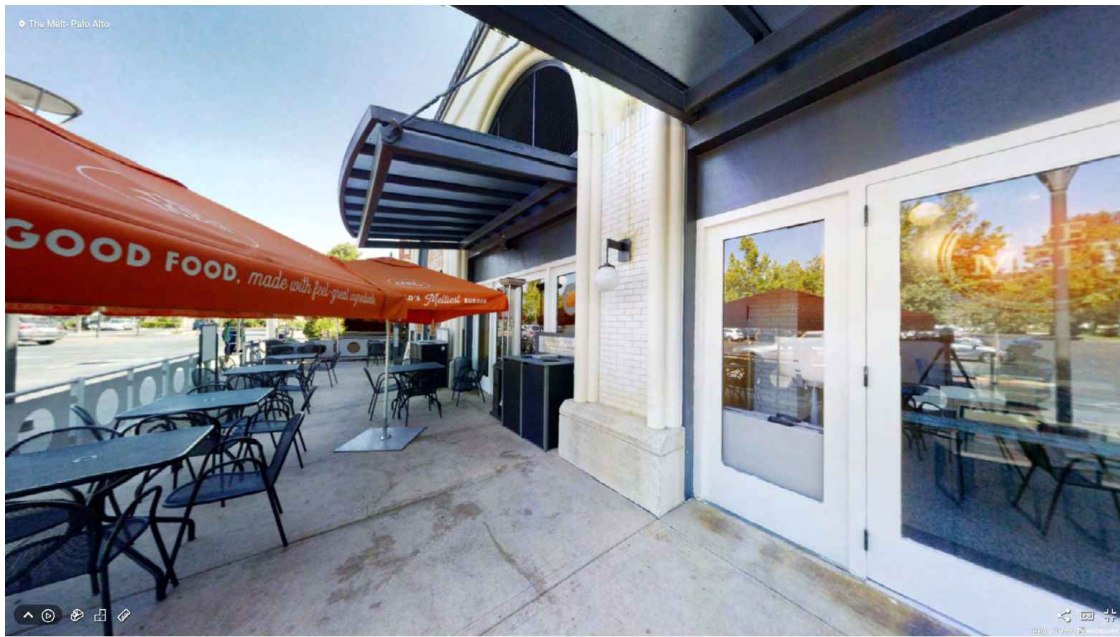
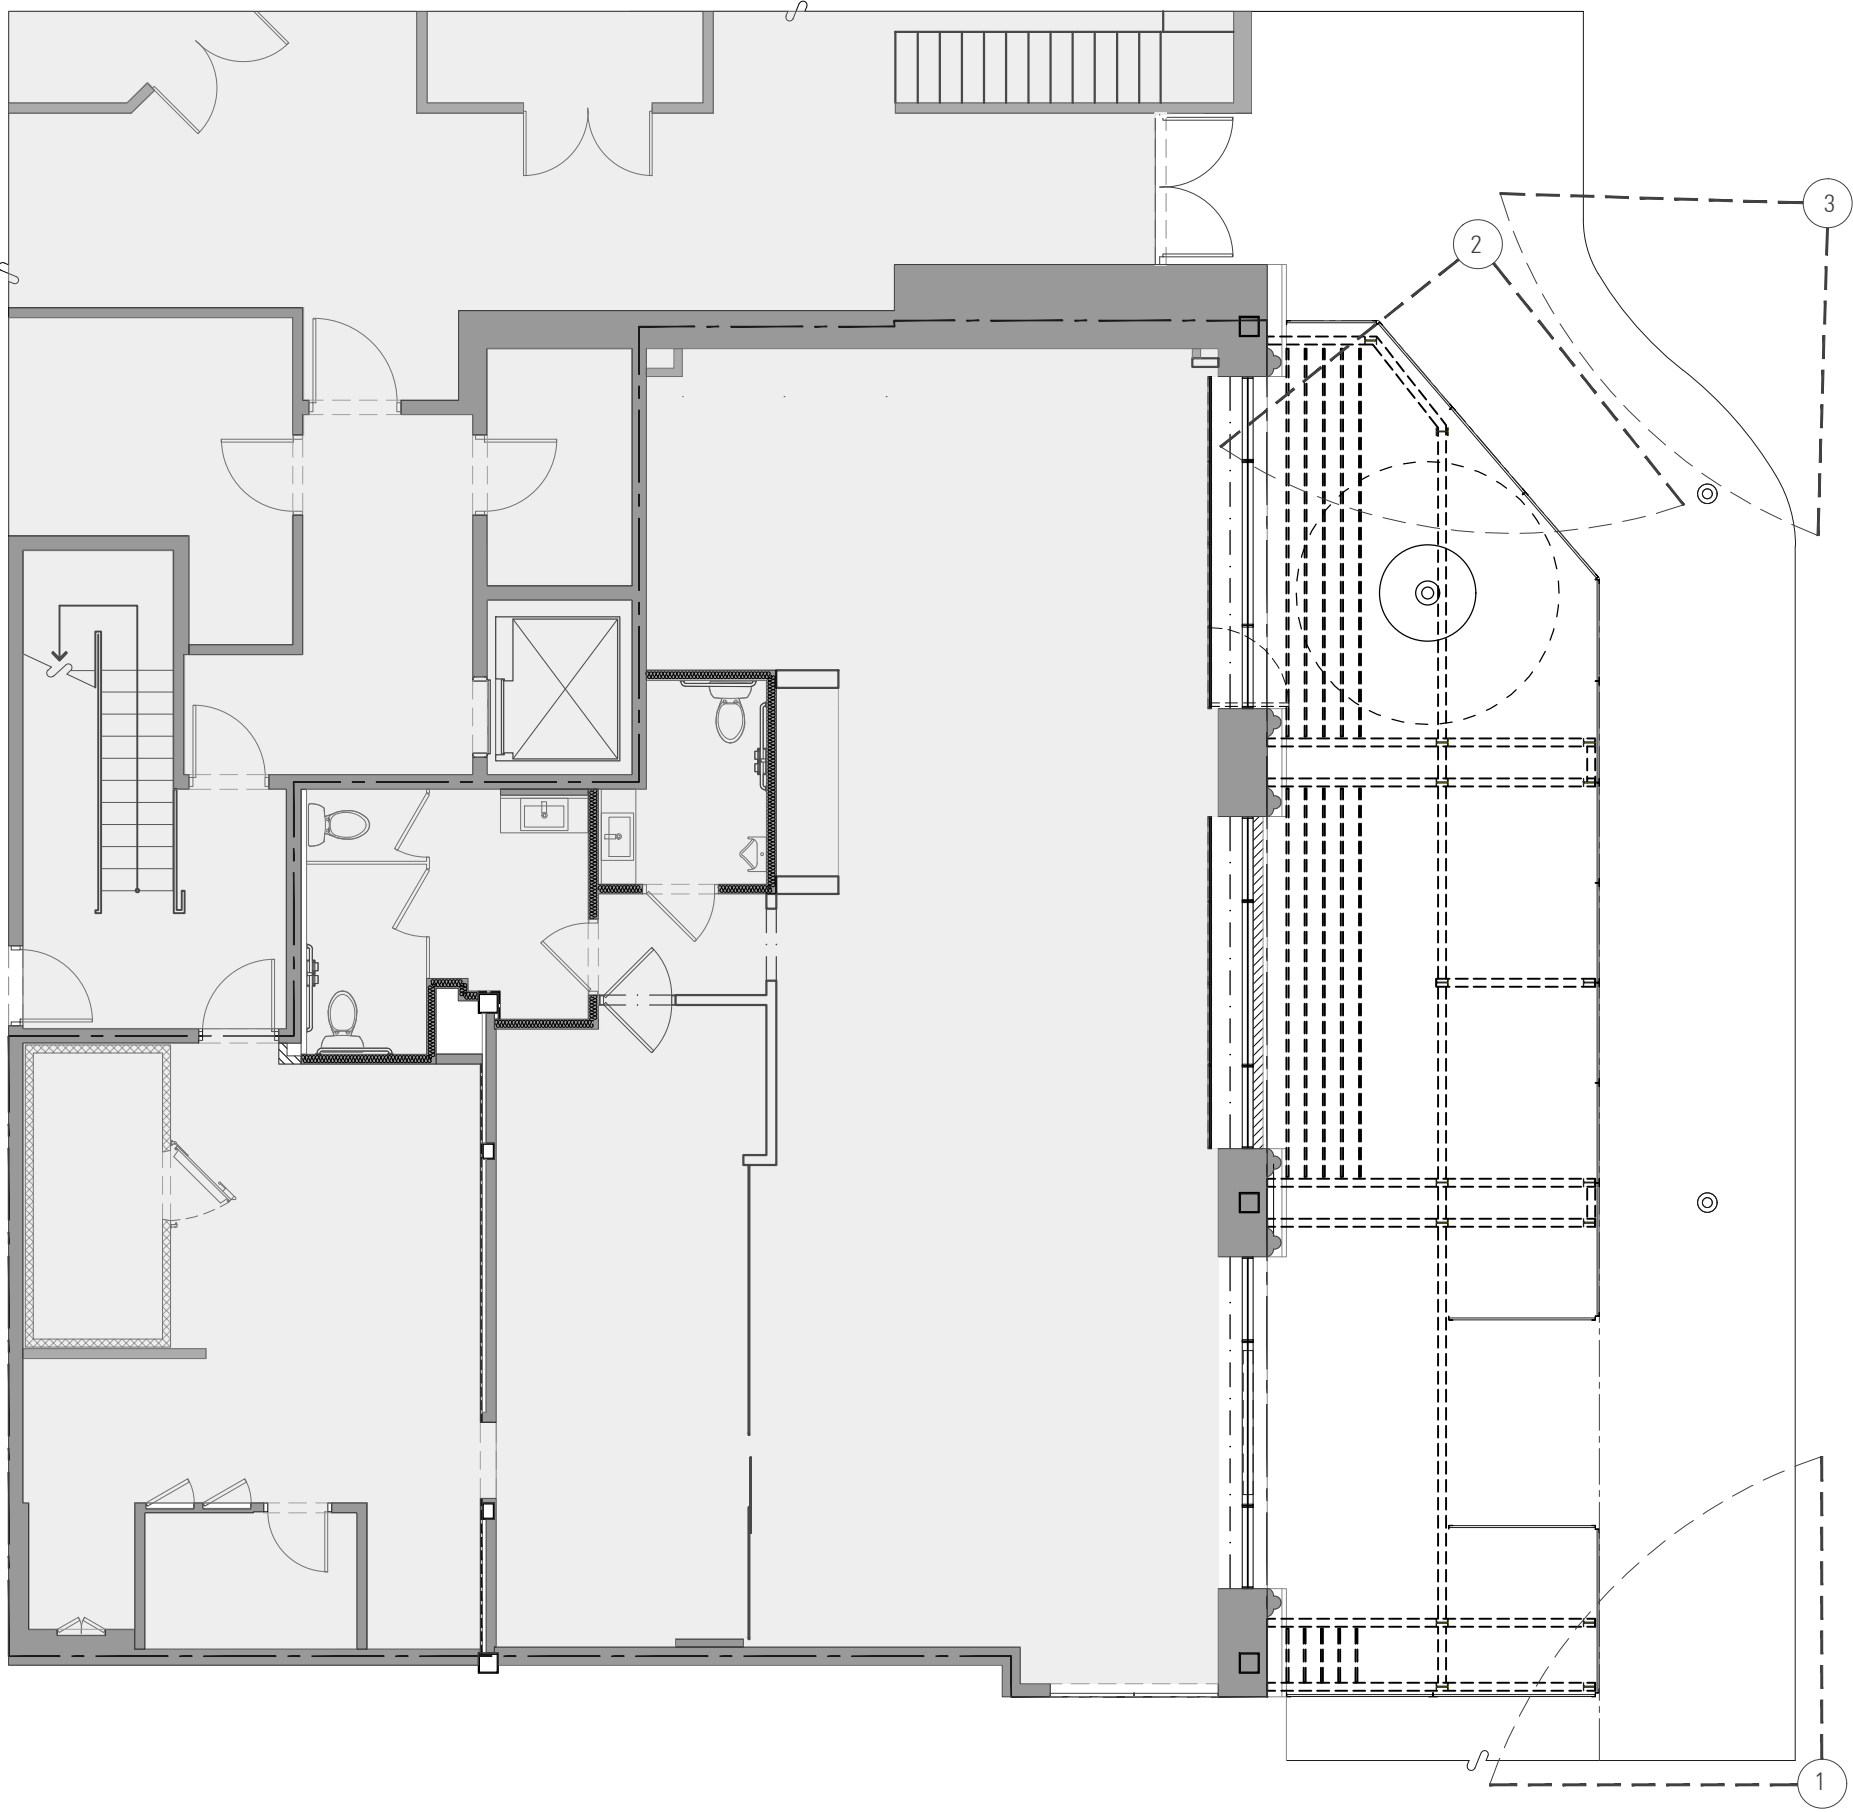
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CHECKED BY: KCR
SHEET TITLE:

LIFE SAFETY PLAN

SHEET NUMBER

G00.30

KEY PLAN



EXISTING



PROPOSED

2 VIEW
N.T.S.



EXISTING



PROPOSED

1 VIEW
N.T.S.



EXISTING



PROPOSED

3 VIEW
N.T.S.

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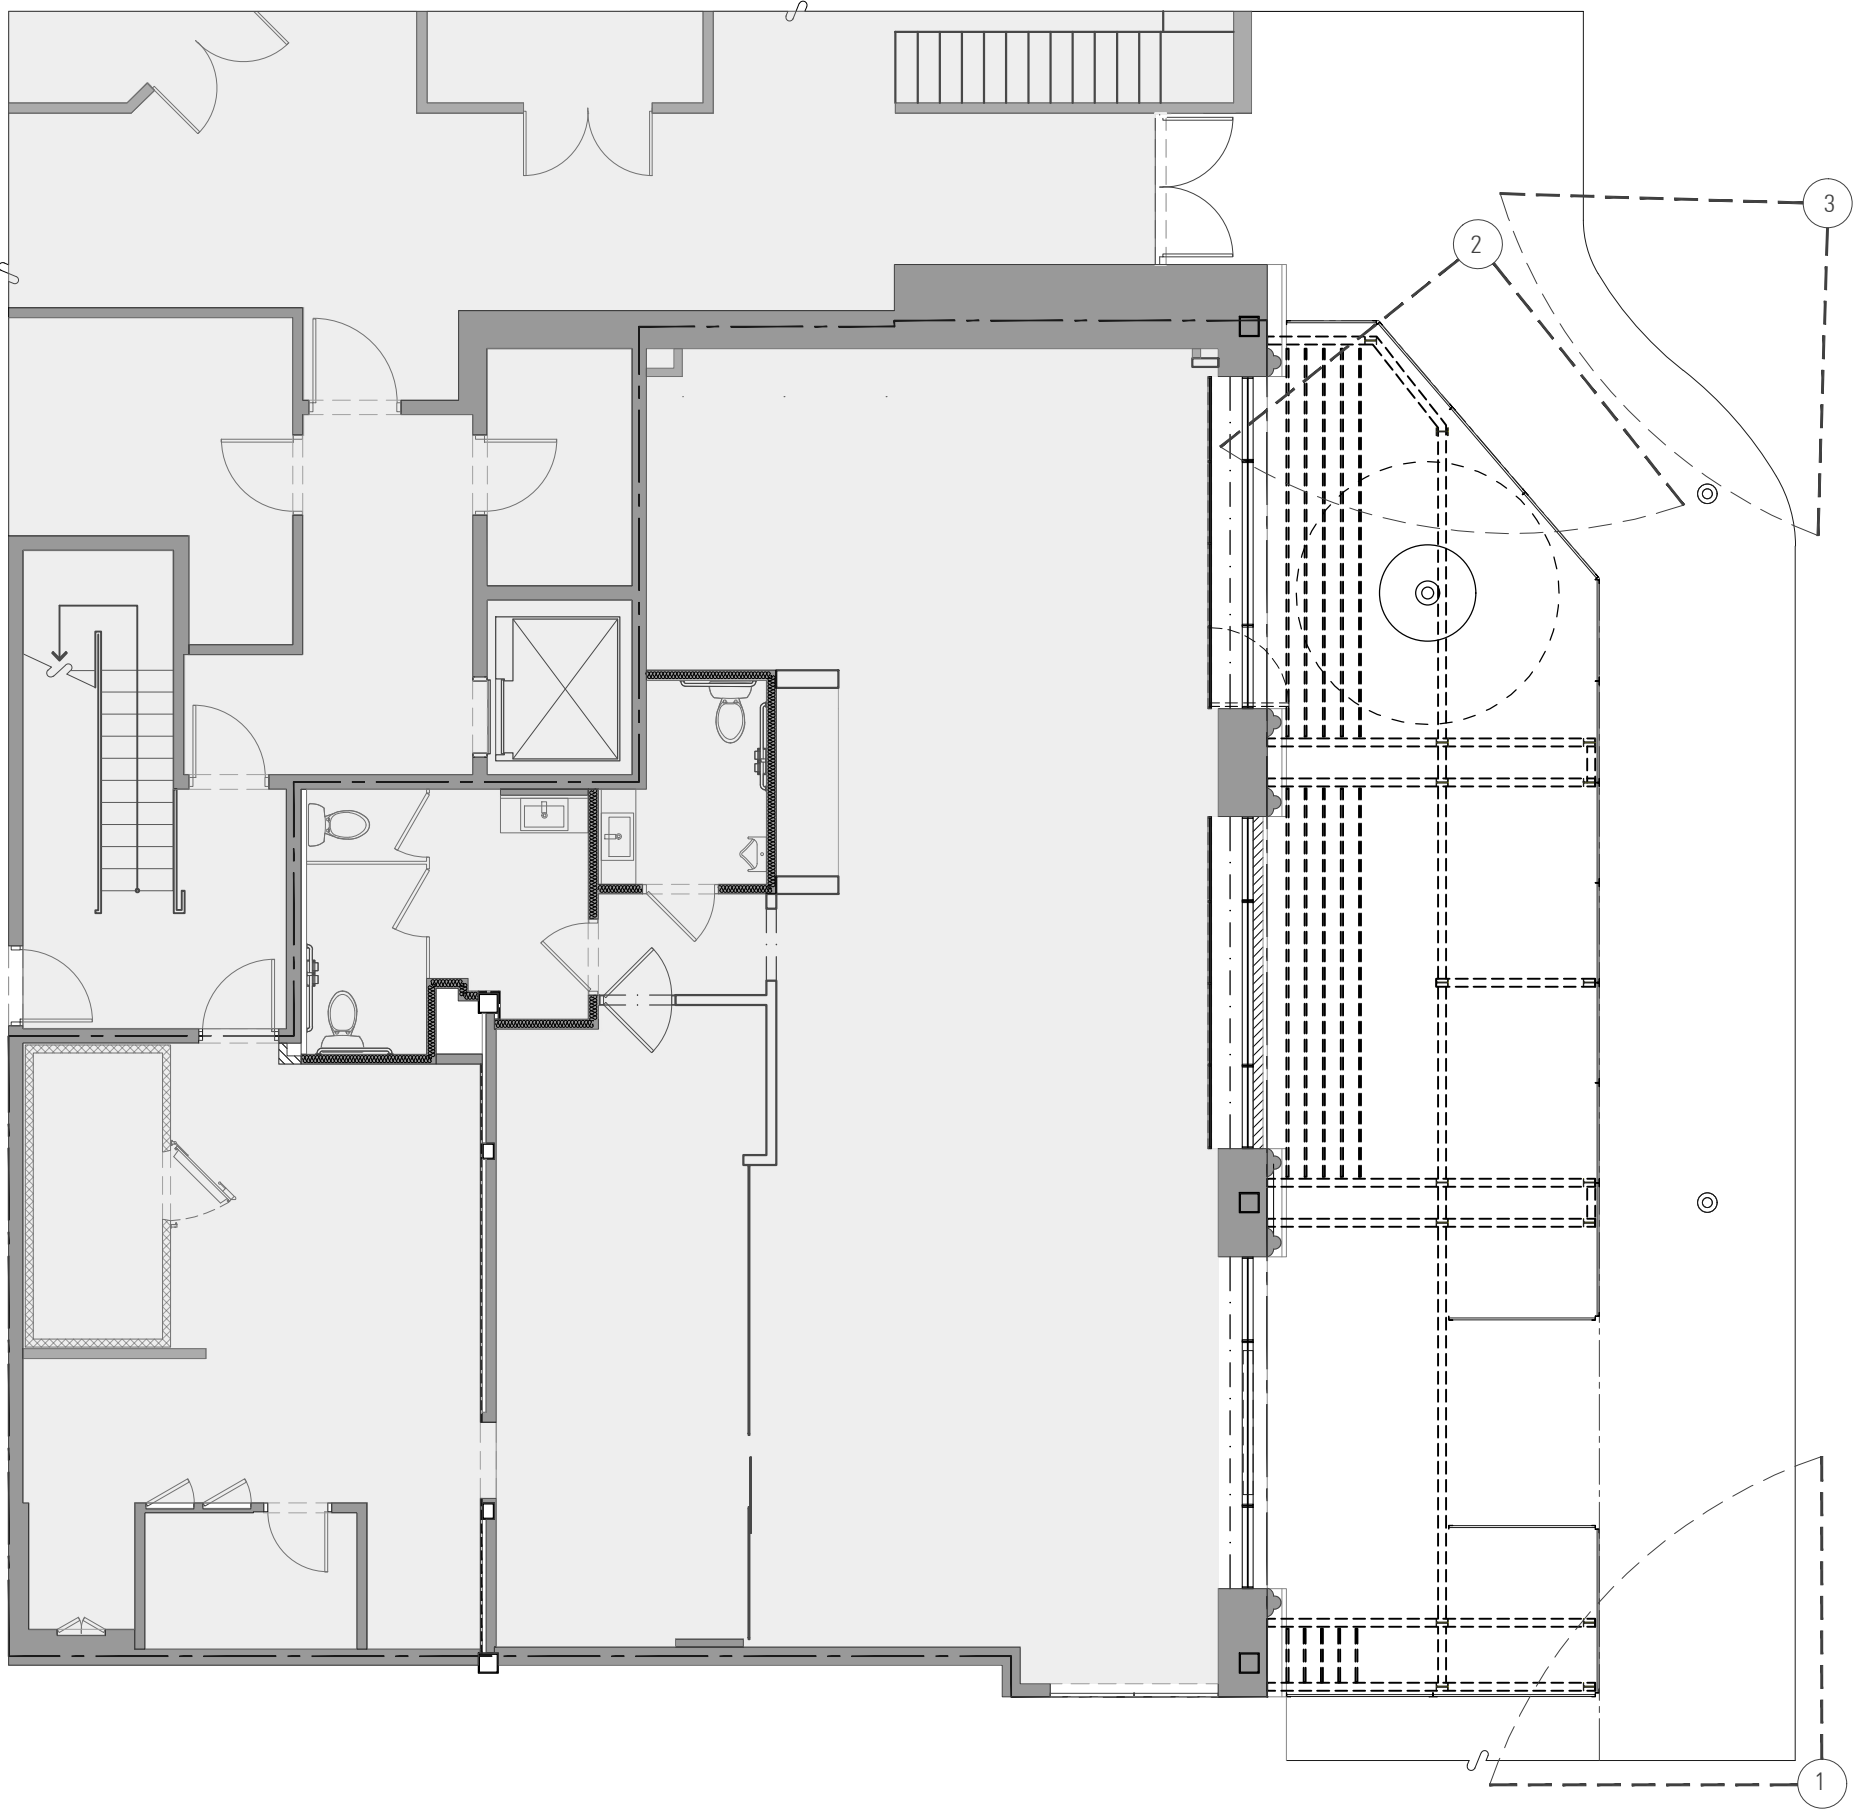
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SITE CONTEXT AND
RENDERINGS

SHEET NUMBER

G00.40A

KEY PLAN



EXISTING



PROPOSED

1 VIEW
N.T.S.



EXISTING



EXISTING



PROPOSED

2 VIEW
N.T.S.



PROPOSED

3 VIEW
N.T.S.

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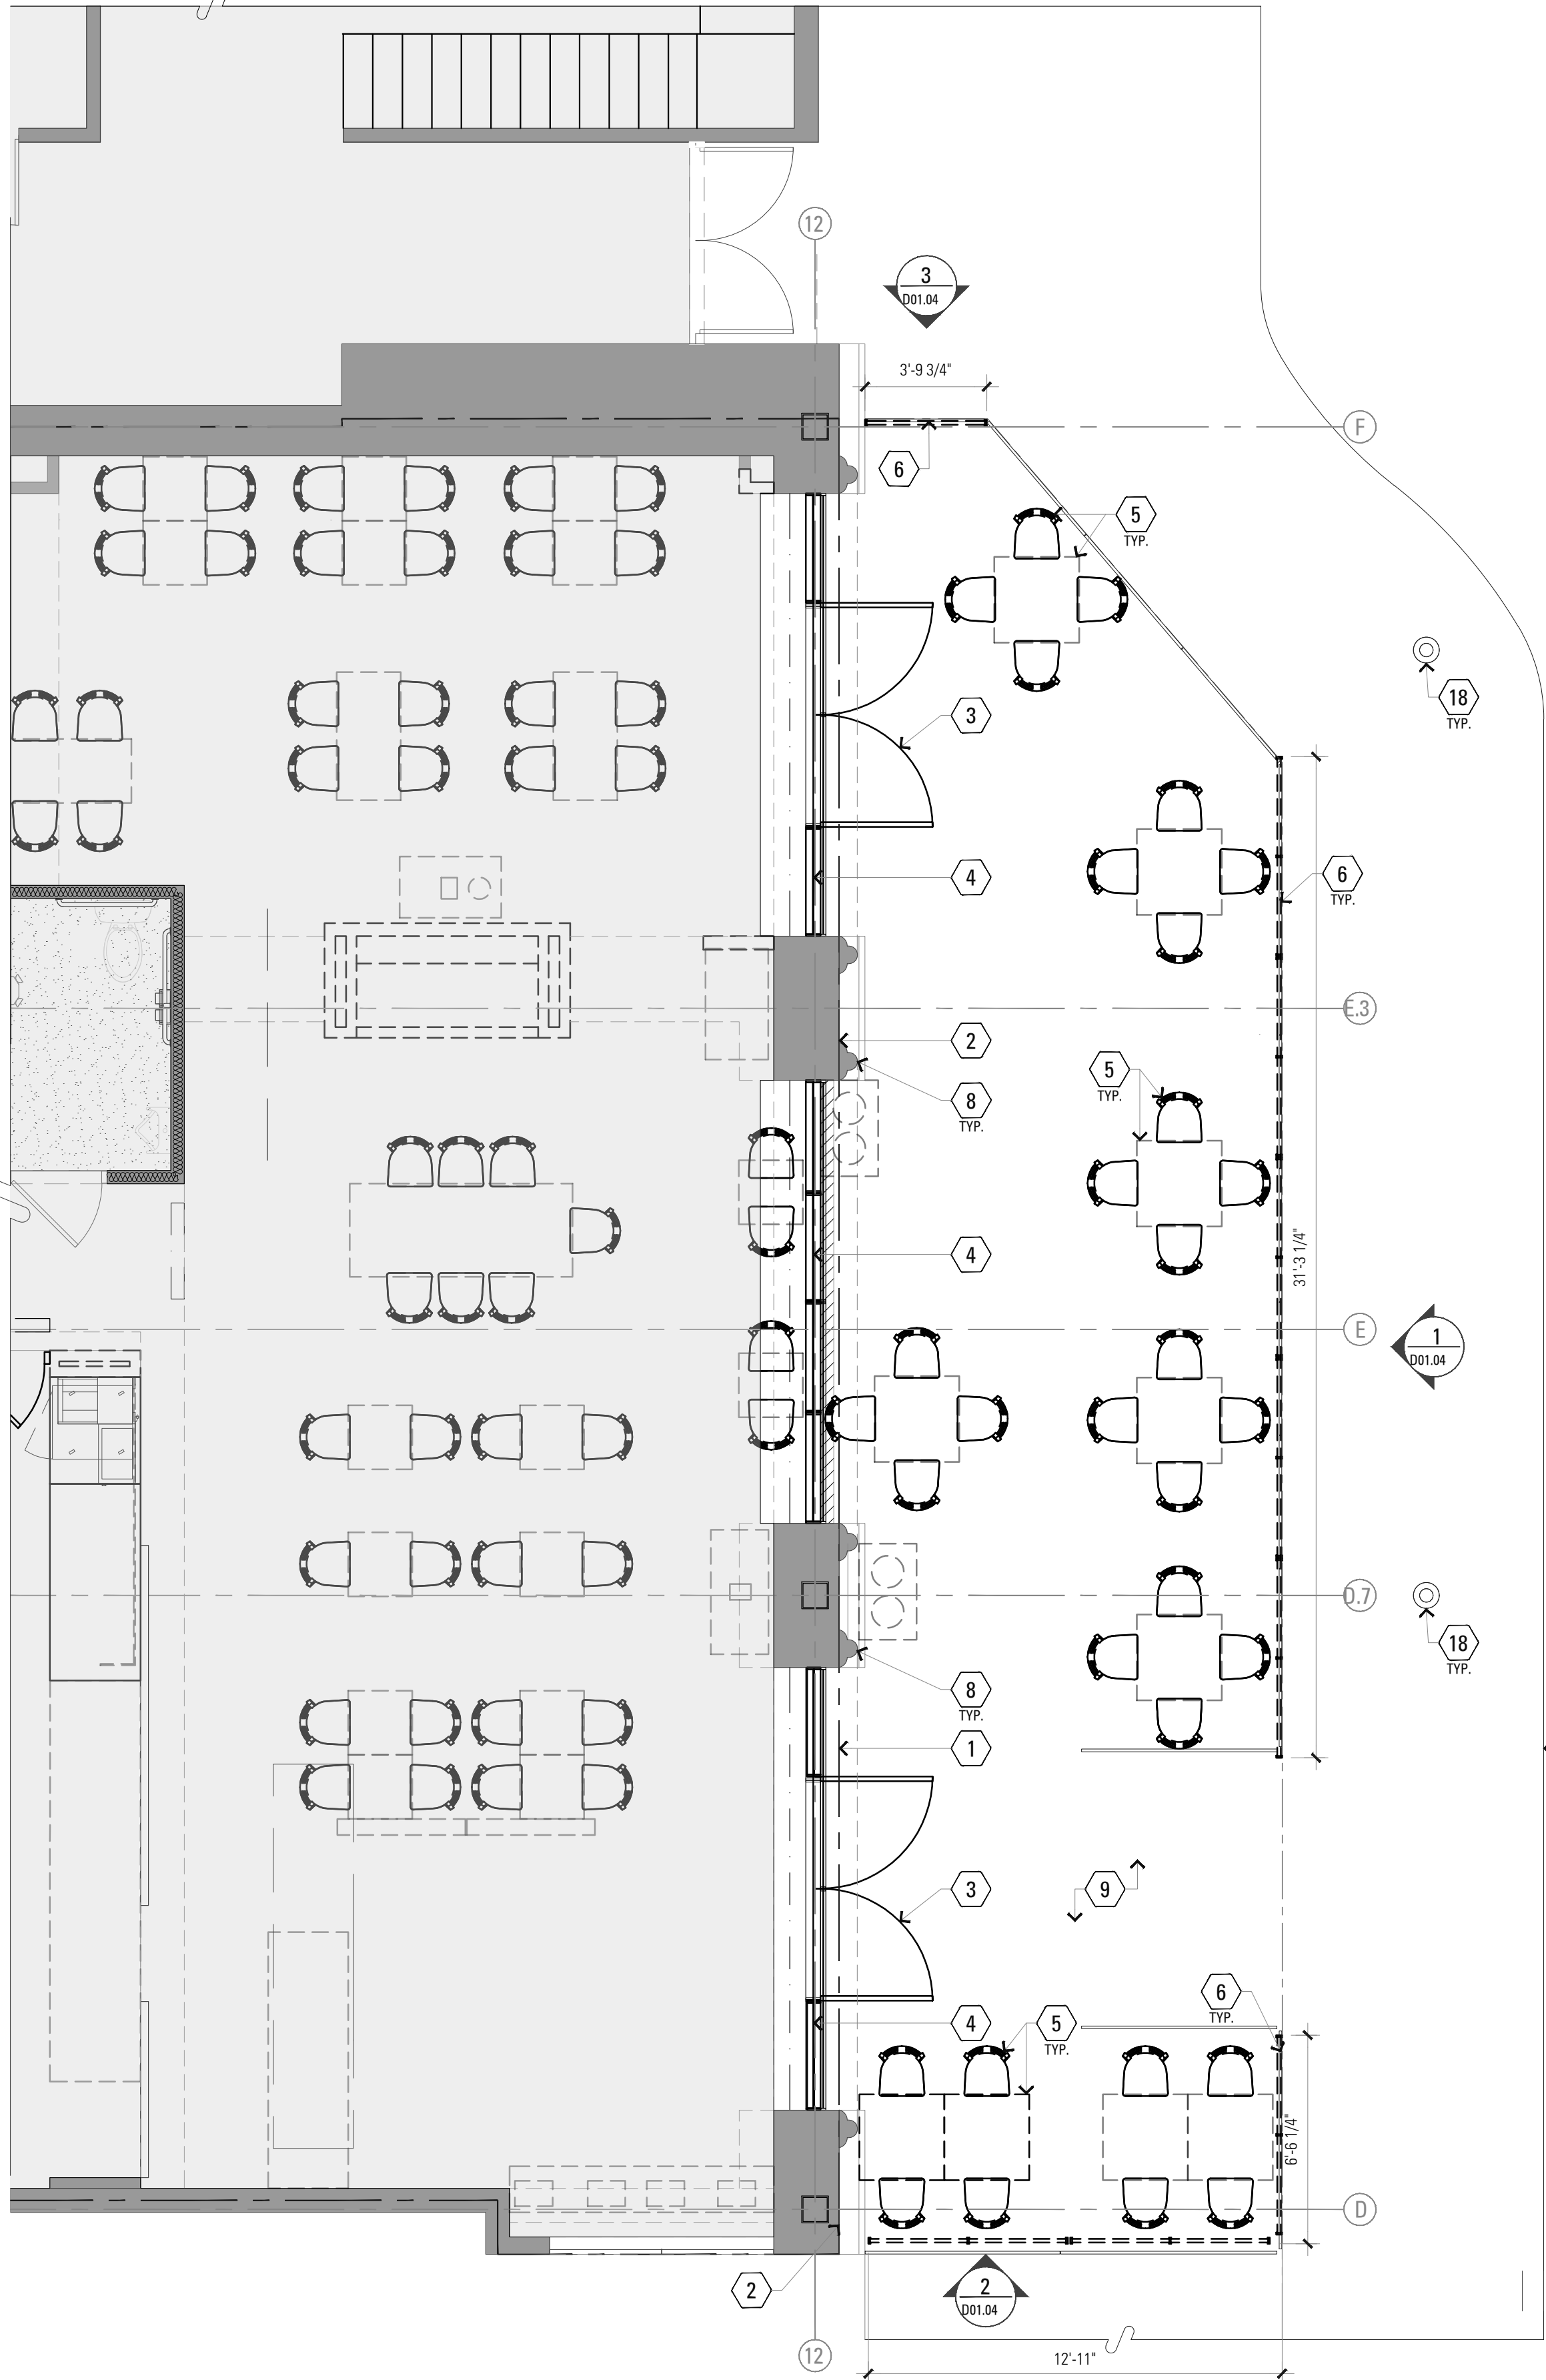
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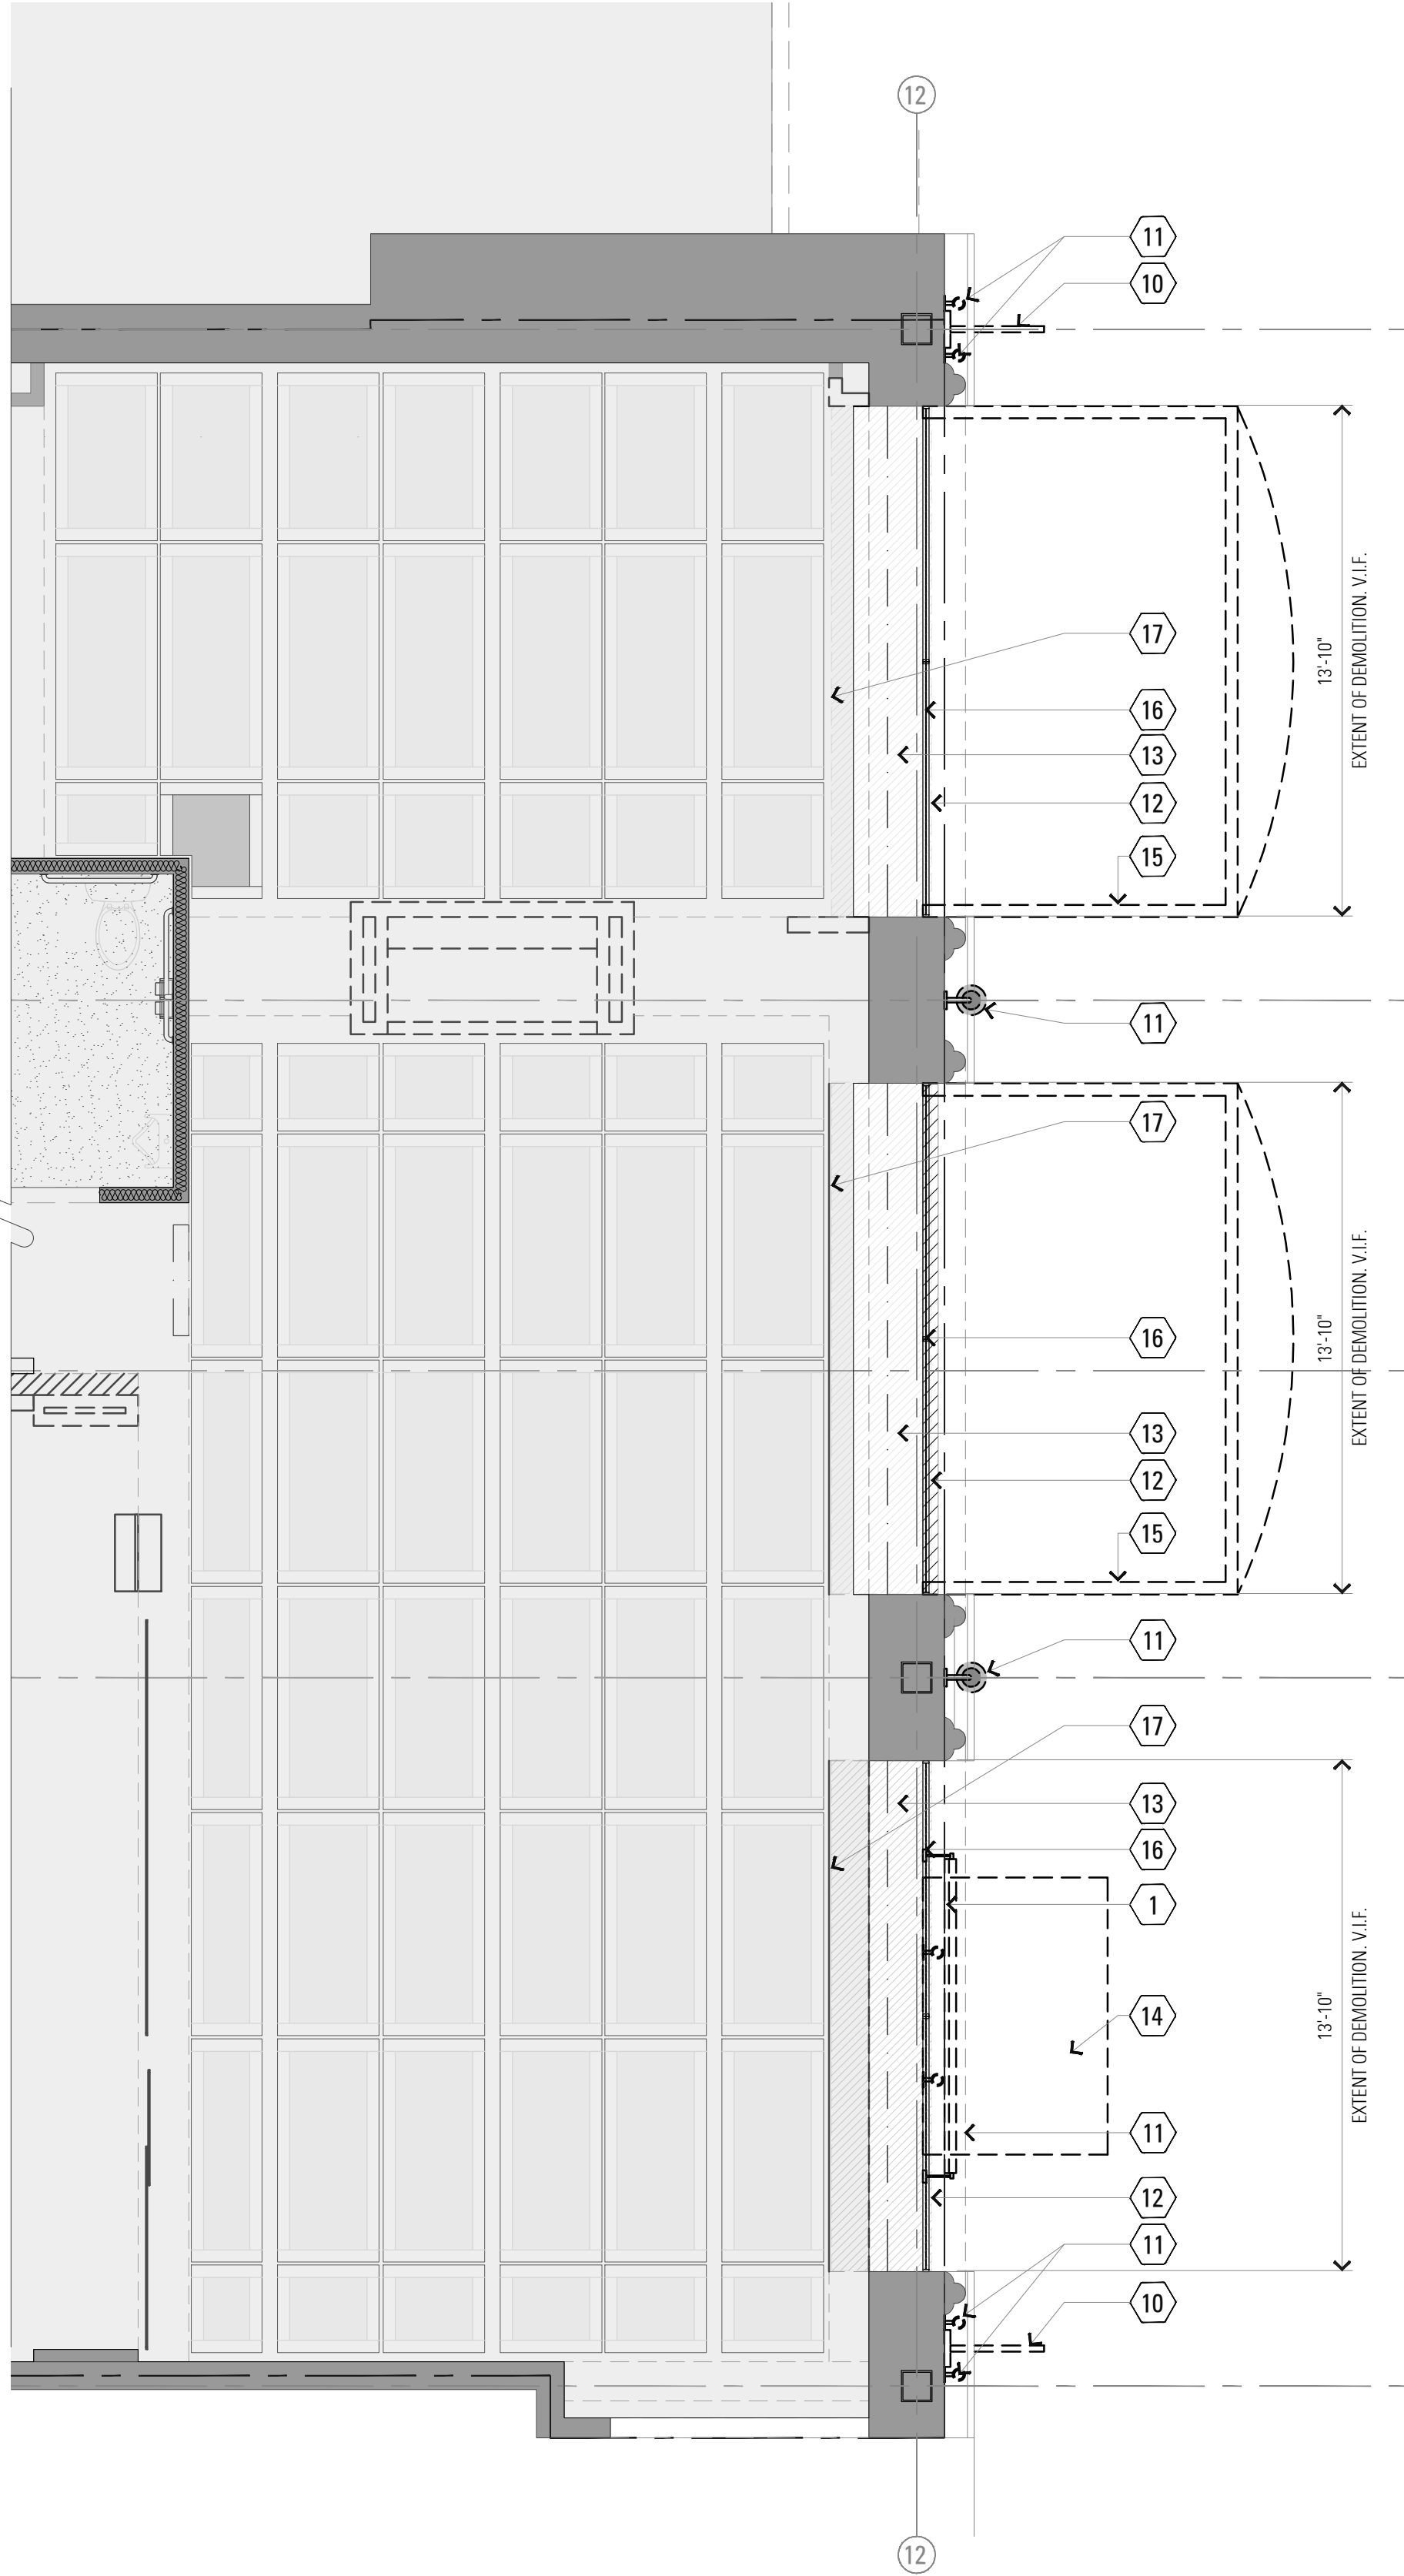
SITE CONTEXT AND
RENDERINGS

SHEET NUMBER

G00.40B



1 DEMOLITION PLAN
1/4" = 1'-0"



2 DEMOLITION REFLECTED CEILING PLAN
1/4" = 1'-0"

KEY NOTES

- 1 LEASE LINE.
- 2 EXTERIOR WALL TO REMAIN. SEE STOREFRONT DEMO ELEVATIONS FOR MORE INFO.
- 3 REMOVE EXISTING DOOR.
- 4 REMOVE EXISTING STOREFRONT.
- 5 REMOVE ALL EXISTING TABLES, CHAIRS, AND TRASH ENCLOSURES IN COMPLIANCE WITH NEW SEATING PLAN LAYOUT
- 6 REMOVE EXISTING FENCE. PATCH & REPAIR PAVING AS REQUIRED, COORDINATE WITH NEW FENCE DETAILS AND LOCATION.
- 7 EXISTING CURB TO REMAIN. PATCH & REPAIR IF DAMAGED DURING CONSTRUCTION.
- 8 EXISTING EXTERIOR ARCHITECTURAL FEATURES TO REMAIN. PATCH AND REPAIR AS NEEDED TO RECEIVE NEW FINISHES.
- 9 EXISTING EXTERIOR PAVING TO REMAIN. CLEAN, PATCH AND REPAIR AS NEEDED. COORDINATE WITH THE MELT AND WITH LANDLORD FOR SPECIFIC REQUIREMENTS.
- 10 REMOVE EXISTING FABRIC BANNER SIGNAGE AND MOUNTING BRACKETS ATTACHED TO STUCCO SURFACE. PATCH AND REPAIR SURFACE TO RECEIVE NEW FINISHES.
- 11 REMOVE EXISTING BANNER LIGHTING / EXTERIOR LIGHTS / SURFACE MOUNTED LIGHTING FOR SIGNAGE ILLUMINATION. KEEP EXISTING J-BOXES AND POWER FOR FUTURE LIGHTING; SEE EXTERIOR ELEVATIONS.
- 12 REMOVE EXISTING EXTERIOR GLAZING.
- 13 REMOVE ARCH INFILL. REFER TO DEMO ELEVATION SHEET D3.0 FOR EXTENTS. VERIFY STRUCTURE AND COORDINATE WITH ARCHITECT IF REQUIRED.
- 14 REMOVE EXISTING EXTERIOR CANOPY. PATCH & REPAIR SURFACE TO RECEIVE NEW FINISHES.
- 15 REMOVE EXISTING EXTERIOR AWNING. PATCH & REPAIR SURFACE TO RECEIVE NEW FINISHES.
- 16 EXISTING STOREFRONT BEAM TO REMAIN. CONFIRM LOCATION AND SIZE WITH ARCHITECT UPON EXPOSING.
- 17 DEMO PORTION OF SOFFIT TO ACHIEVE NEW ARCHED OPENING.
- 18 STREET LIGHTS (E)


DEMO PLAN NOTES

- GENERAL:
1. DIMENSIONS SHOWN ARE TO THE FACE OF FINISH.
 2. G.C. TO COORDINATE PERMIT, APPROVALS, AND LOCATION OF DUMPSTER AND STORAGE UNIT PRIOR TO REQUIRED STORE CLOSING
 3. U.O.N. ALL WALL ELECTRICAL RECEPTACLES ARE TO REMAIN.
 4. AUTOMATIC SPRINKLER SYSTEM TO REMAIN OPERATIONAL AT ALL TIMES EXCEPT AS COORDINATED WITH THE MELT PM.
 5. REVIEW ANY POTENTIAL DISRUPTION TO RESTAURANT OPERATIONS IN ADVANCE WITH THE MELT PM.

PLAN LEGEND

- AREA NOT IN SCOPE

KEY PLAN

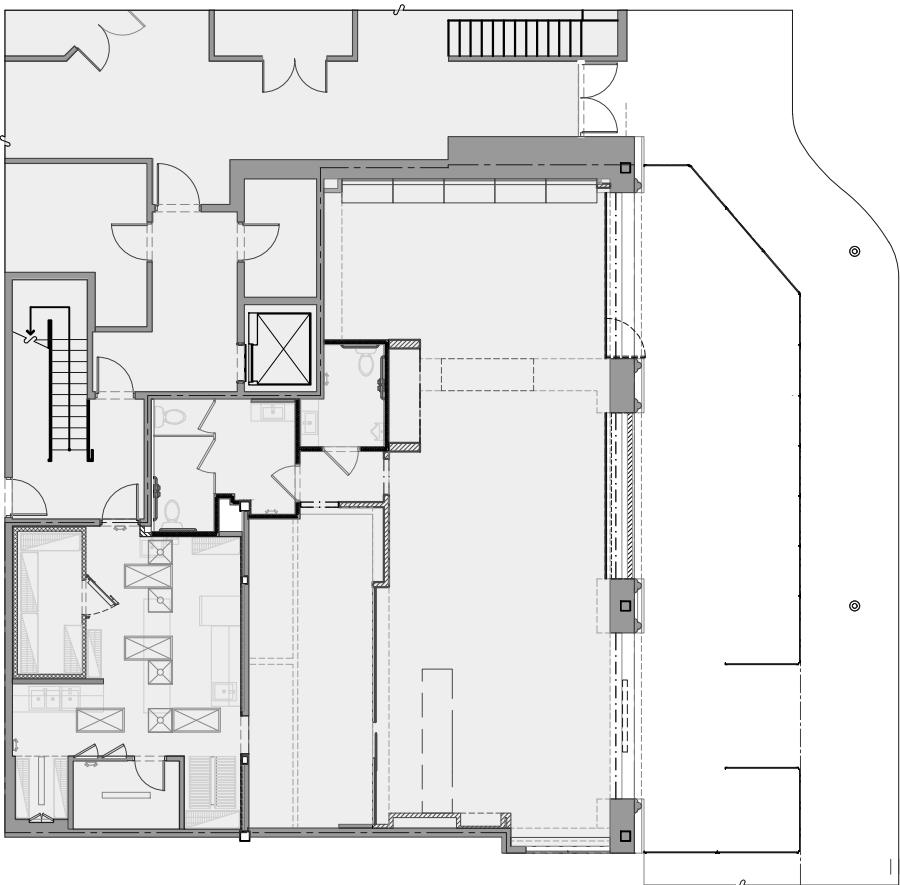

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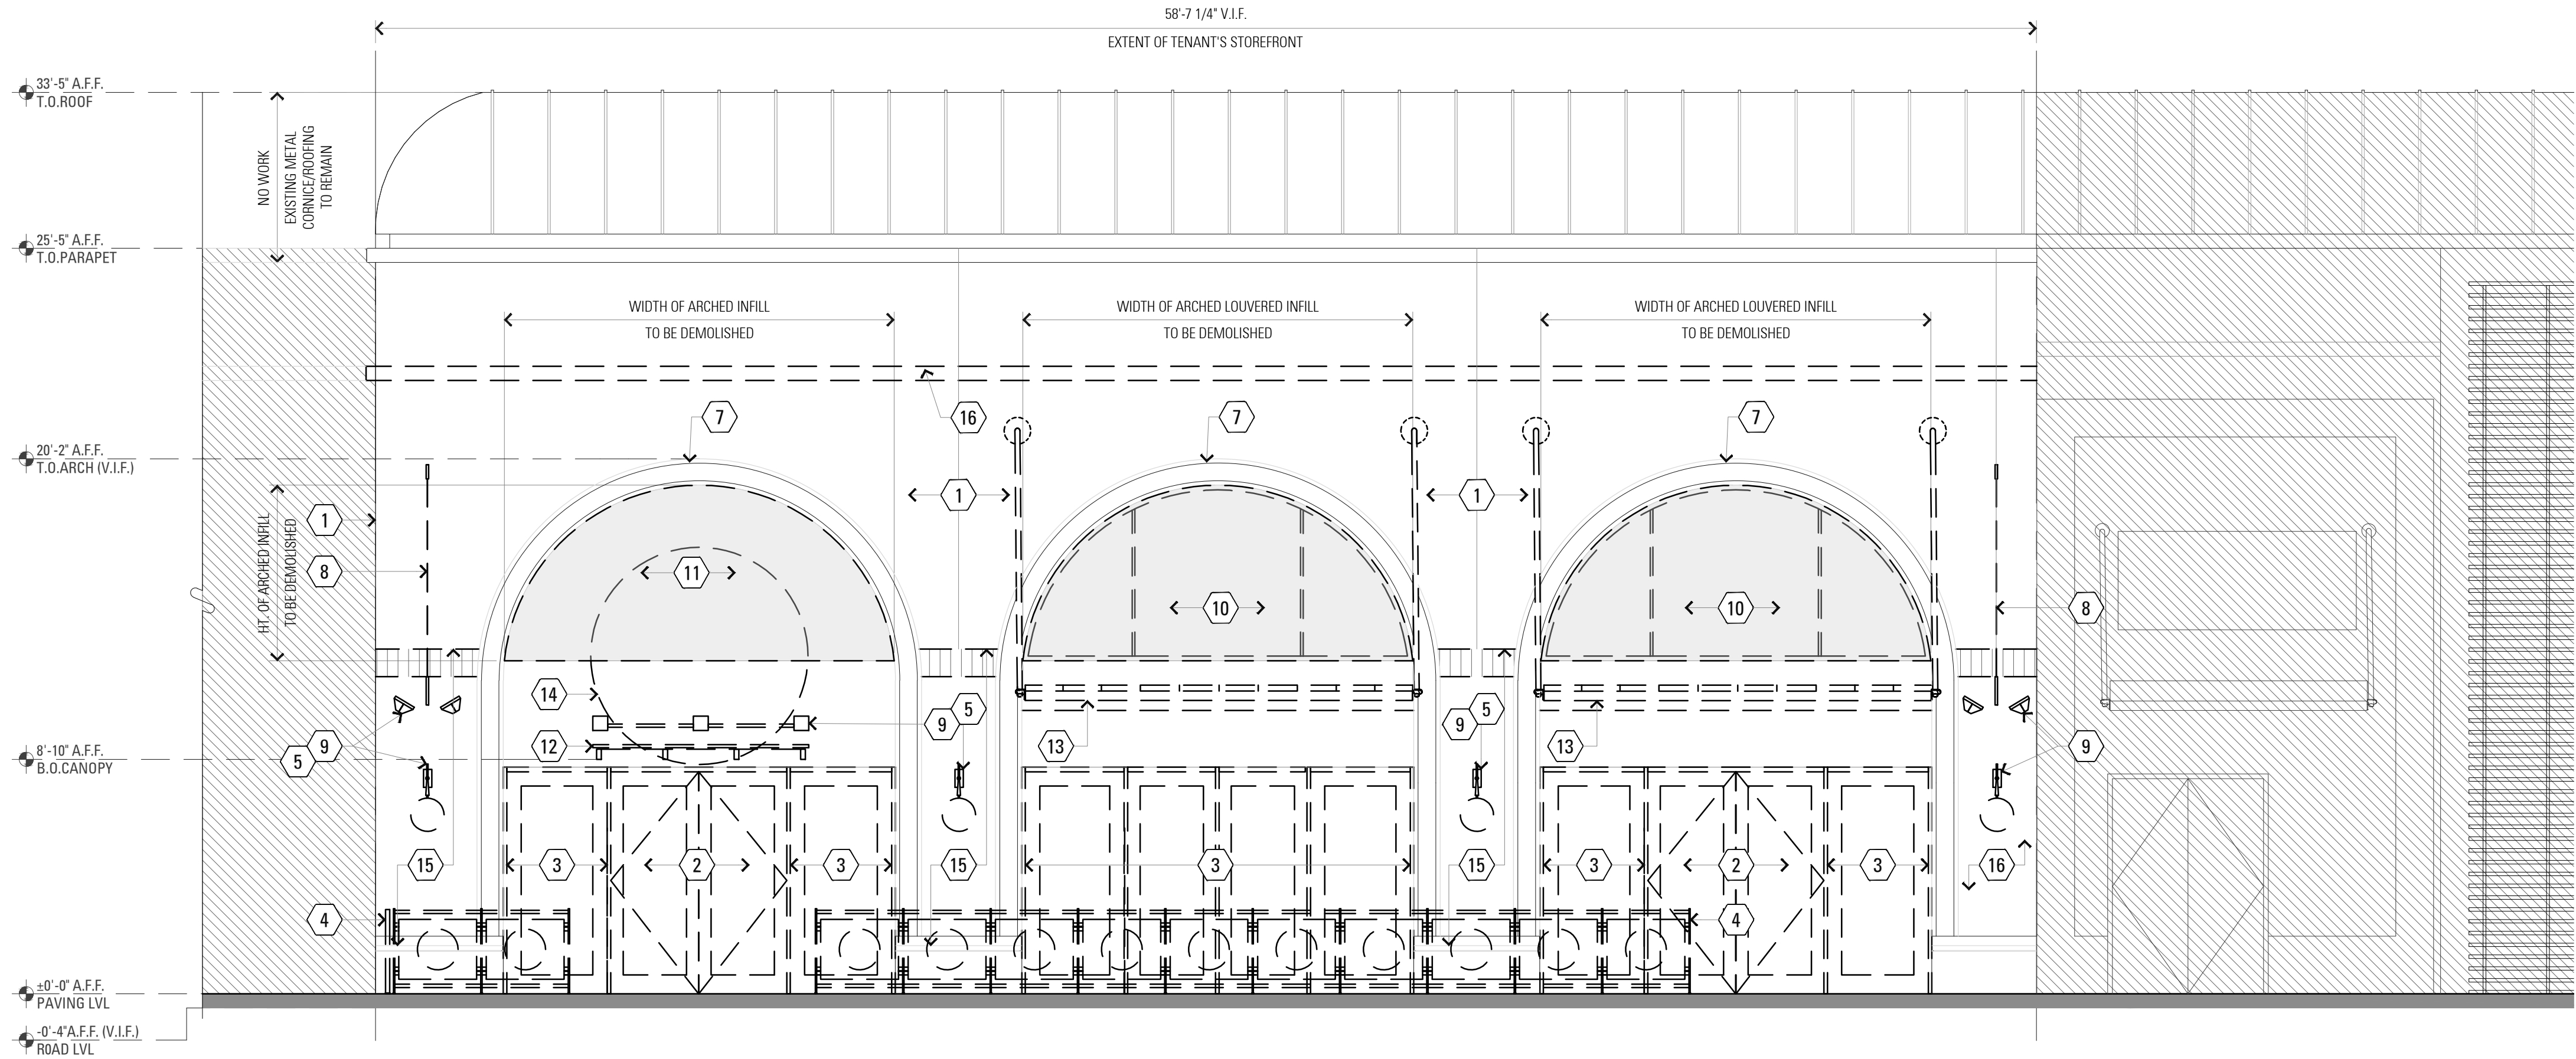
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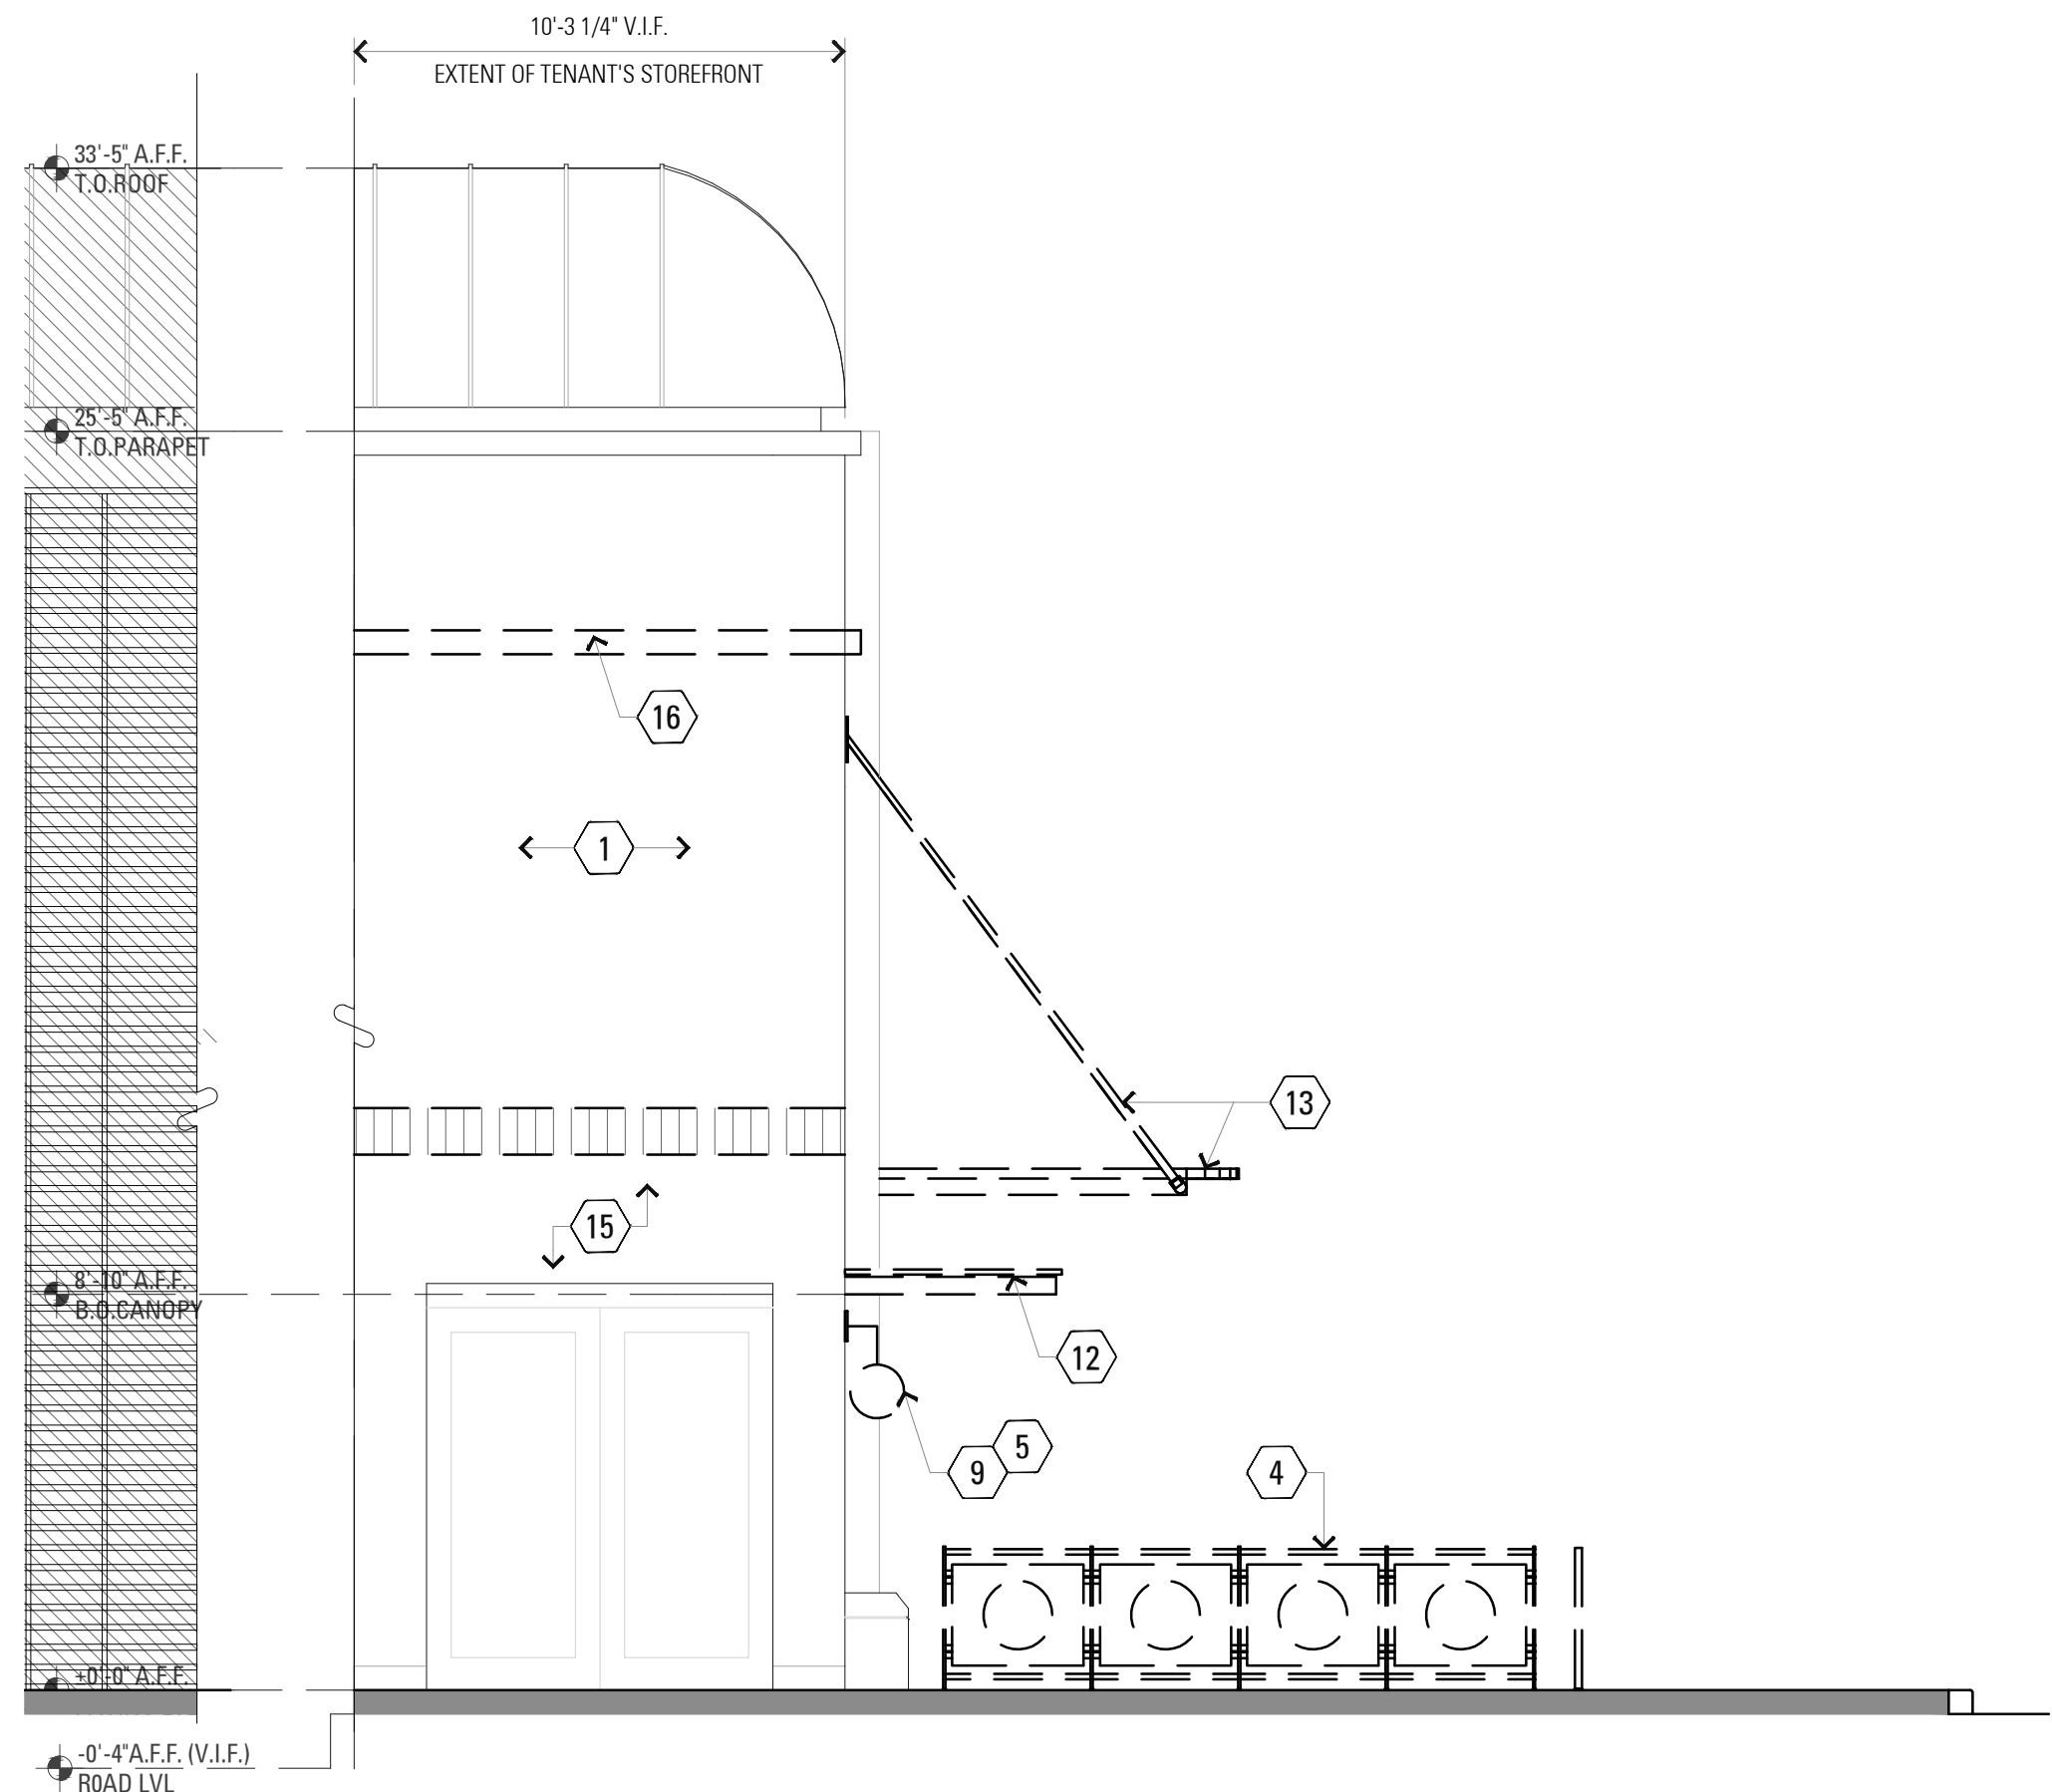
**DEMOLITION PLAN &
DEMOLITION
REFLECTED CEILING
PLAN**

SHEET NUMBER


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1 DEMOLITION NORTH ELEVATION
1/4" = 1'-0"



2 DEMOLITION EAST ELEVATION
1/4" = 1'-0"



3 DEMOLITION WEST ELEVATION
1/4" = 1'-0"

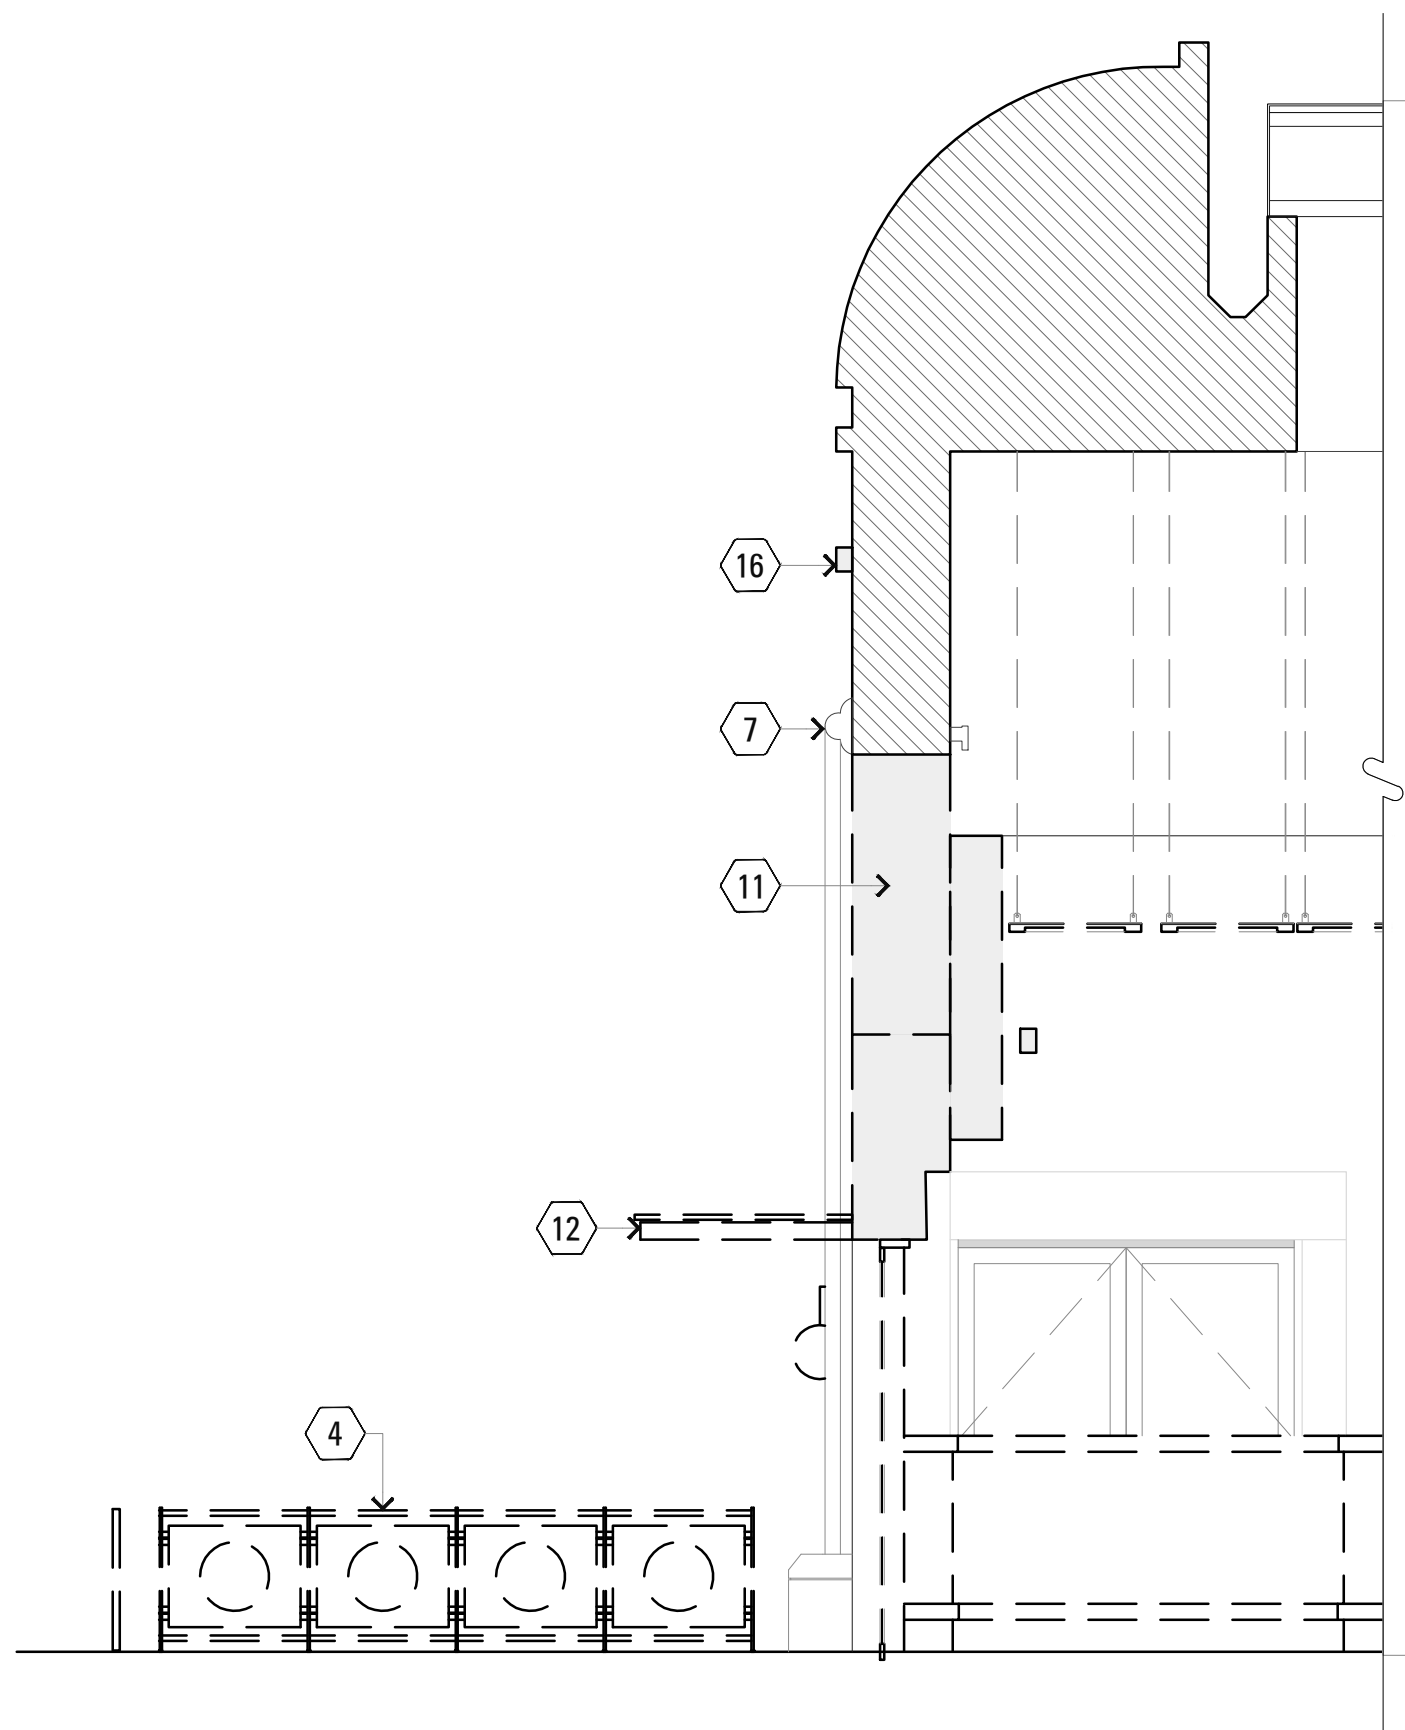KEY NOTES

- 1 EXTERIOR WALL TO REMAIN.
- 2 REMOVE EXISTING DOOR.
- 3 REMOVE EXISTING STOREFRONT- GLAZING AND FRAMES.
- 4 REMOVE EXISTING FENCE. PATCH & REPAIR PAVING AS REQUIRED, COORDINATE WITH NEW FENCE DETAILS AND LOCATION.
- 5 KEEP J-BOX AND POWER
- 6 EXISTING CURB TO REMAIN. PATH & REPAIR IF DAMAGED DURING CONSTRUCTION.
- 7 EXISTING PRECAST CONCRETE ARCH TO REMAIN. PATCH AND REPAIR AS NEEDED TO RECEIVE NEW FINISHES.
- 8 REMOVE EXISTING FABRIC BANNER SIGNAGE AND MOUNTING BRACKETS ATTACHED TOSTUCCO SURFACE. PATCH AND REPAIR SURFACE TO RECEIVE NEW FINISHES.
- 9 REMOVE EXISTING BANNER LIGHTING / EXTERIOR LIGHTS / SURFACE MOUNTED LIGHTING FOR SIGNAGE ILLUMINATION
- 10 REMOVE EXISTING NON-FUNCTIONAL METAL LOUVERS.
- 11 REMOVE EXTERIOR INFILL. VERIFY STRUCTURE AND COORDINATE WITH ARCHITECT IF REQUIRED.
- 12 REMOVE EXISTING EXTERIOR CANOPY. PATCH & REPAIR SURFACE TO RECEIVE NEW FINISHES.
- 13 REMOVE EXISTING EXTERIOR AWNING. PATCH & REPAIR SURFACE TO RECEIVE NEW FINISHES.
- 14 REMOVE EXISTING "THE MELT" SIGN
- 15 REMOVE EXISTING GLAZED BRICK VENEER TILE OVER EXISTING STUCCO EXTERIOR WALL. PATCH & REPAIR TO RECEIVE NEW FINISHES.
- 16 REMOVE EXISTING TRIM ON EXTERNAL STOREFRONT

ELEVATION DEMO NOTES


GENERAL:

1. DIMENSIONS SHOWN ARE TO THE FACE OF FINISH.
2. GENERAL CONTRACTOR TO DISCONNECT ALL EXISTING EQUIPMENT AS REQUIRED PER SCOPE OF OUTLINED WORK. SHUTDOWNS MAY BE STAGED, UNLESS MAJOR ELECTRICAL OR PLUMBING WORK IS REQUIRED THAT COULD CAUSE DAMAGE TO EQUIPMENT THAT IS CONNECTED. G.C. TO COORDINATE ANY DISRUPTION TO SERVICES WITH THE MELT PM IN ADVANCE.
3. G.C. TO COORDINATE PERMIT, APPROVALS, AND LOCATION OF DUMPSTER AND STORAGE UNIT PRIOR TO REQUIRED STORE CLOSING
4. GENERAL CONTRACTOR TO CHECK AND REPAIR ALL MECHANICAL, PLUMBING AND ELECTRICAL CONNECTIONS FOR ALL THE EQUIPMENT AS INDICATED ON EQUIPMENT PLAN WITH THE APPROVAL OF THE MELT PM..
5. U.O.N. ALL WALL ELECTRICAL RECEPTACLES ARE TO REMAIN.
6. COORDINATE REMOVAL / RELOCATION OF ANY IT-RELATED ITEMS INCLUDING P.O.S. STATIONS, SCREENS, & KIOSKS.
7. AUTOMATIC SPRINKLER SYSTEM TO REMAIN OPERATIONAL AT ALL TIMES EXCEPT AS COORDINATED WITH MELT PM.
8. REVIEW ANY POTENTIAL DISRUPTION TO RESTAURANT OPERATIONS IN ADVANCE WITH THE MELT PM.

ELEVATION LEGEND

- AREA NOT IN SCOPE
- TO BE DEMOLISHED

KEY ELEVATION

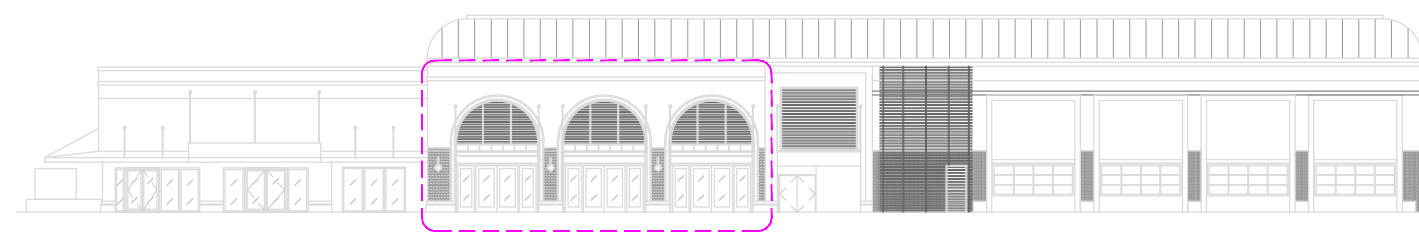

4 KEY ELEVATION
1/4" = 1'-0"

ARCHITECT:

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CLIENT:

theMELT

THE MELT, STANFORD

180 EL CAMINO REAL, SUITE 705A, BLDG. E,
PALO ALTO, CALIFORNIA 94304

PROJECT:

PROJECT#: GA21-MLT004
DOCUMENT DATE: 07-05-22
DOCUMENT PHASE:

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ISSUE: ARB SET

DRAWN BY: NR
CHECKED BY: KCR

SHEET TITLE


**DEMOLITION
STOREFRONT
ELEVATIONS**

SHEET NUMBER

D01.02

1 CONSTRUCTION FLOOR PLAN

1/4" = 1'-0"

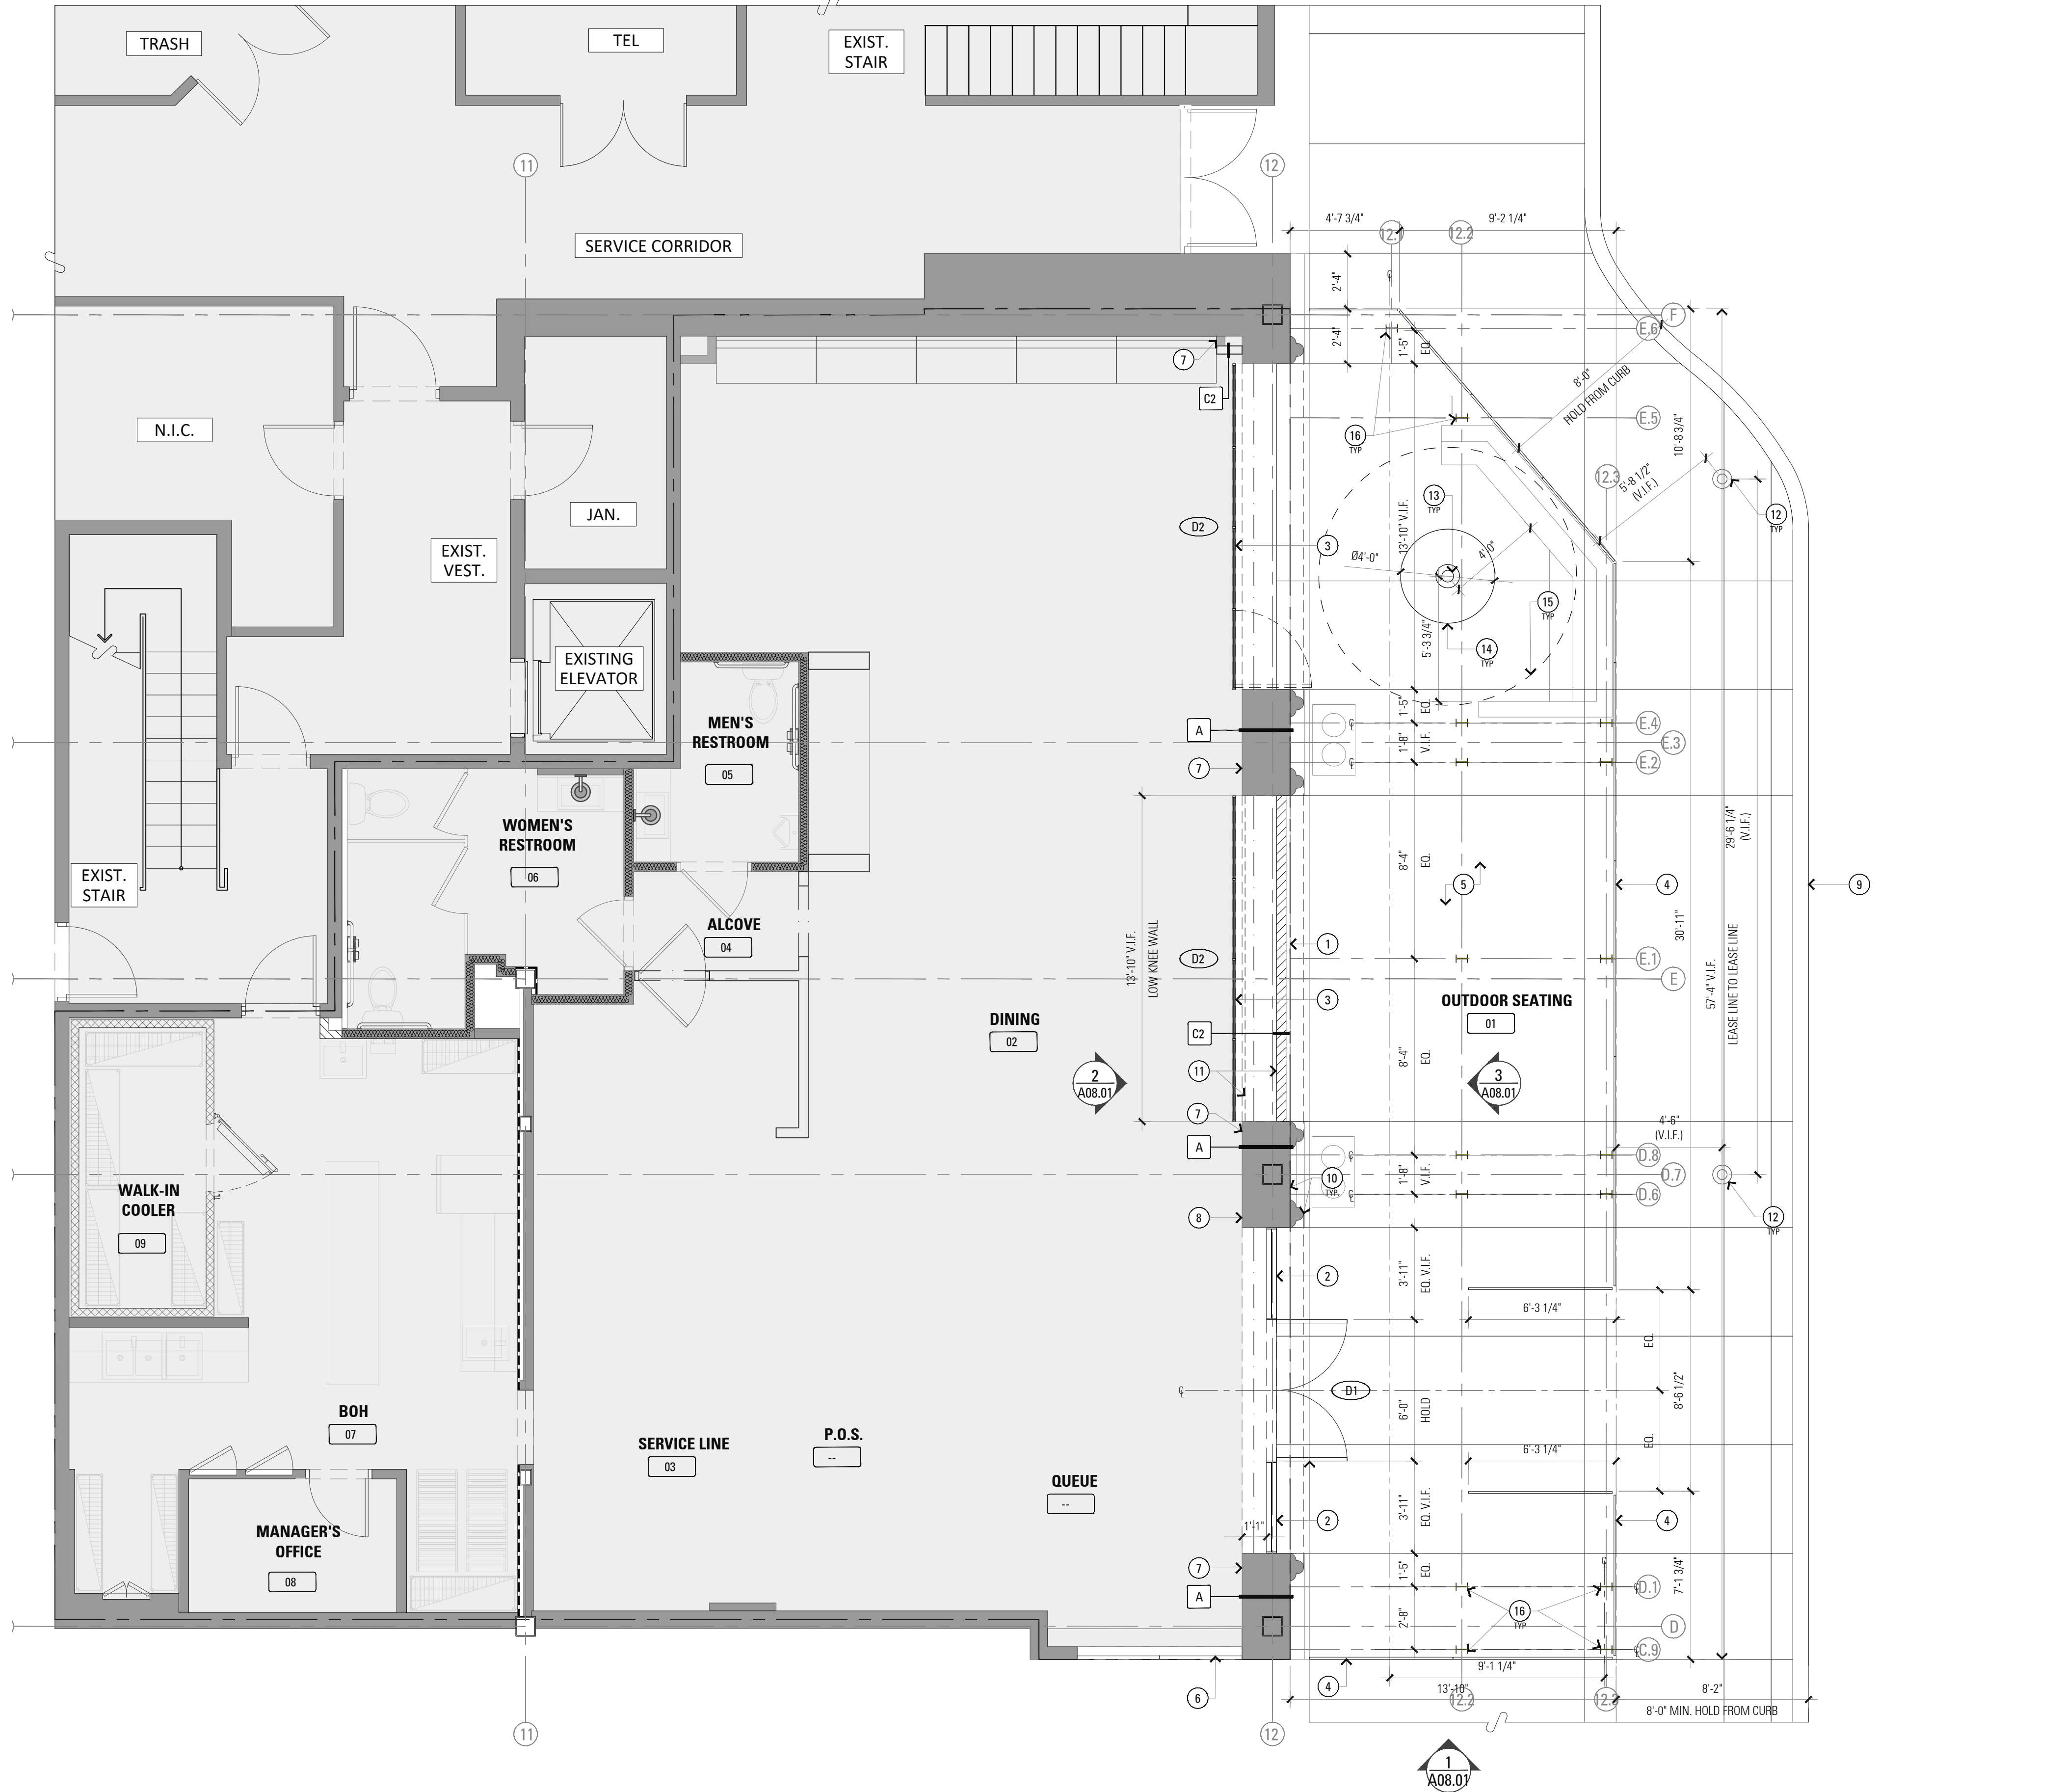

KEY NOTES

- LEASE LINE
- NEW STOREFRONT AND ENTRY DOORS
- NEW MOTORIZED GARAGE DOOR WITH BREAK AWAY SWING DOOR FOR EGRESS
- NEW EXTERIOR FENCE. SEE EXHIBIT SHEET X.03 FOR MORE INFORMATION
- EXTERIOR FLOORING TO REMAIN. PREPARE GROUND TO RECEIVE GRATING AND TREE.
- EXISTING SEALED EXTERIOR DOORS TO REMAIN
- EXISTING INTERIOR WALLS
- PROVIDE AND INSTALL A TACTILE SIGN STATING "EXIT" AND COMPLYING WITH ICC ANSI A17.1-2009 ADJACENT TO EACH EXTERIOR DOOR TO THE EXIT DISCHARGE (WHERE INDICATED).
- EXISTING CURB LINE
- EXTERIOR WALLS, ARCH. ELEMENTS TO REMAIN. PATCH & REPAIR WALL SURFACE TO RECEIVE NEW FINISHES
- BUILT-IN COUNTER ON LOW WALL
- EXISTING STREET LIGHT POLES
- TRUNK OF PROPOSED TREE
- 3' DIA PROPOSED TREE WELL
- CANOPY OF PROPOSED TREE ABOVE
- W6x12 ASTM A558 WEATHERING STEEL COLUMNS WITH A 18" DIA X 4' 0" L FOUNDATION

PLAN NOTES

- GENERAL:
- DIMENSIONS SHOWN ARE TO THE FACE OF FINISH ABOVE CHAIR RAIL.
 - DIMENSIONS NOTED AS "CLEAR" OR "HOLD" ARE MIN. REQ'D. ONLY DIMENSIONS FOLLOWED BY A (+/-) MAY VARY TO ACCOMMODATE (E) CONDITIONS.
 - WRITTEN DIMENSIONS TAKE PRECEDENCE OVER SCALE ON THE CONSTRUCTION DOCUMENTS. DO NOT SCALE DRAWINGS.
 - GENERAL CONTRACTOR SHALL BE RESPONSIBLE FOR BARRICADING OFF OF AREA NOT IN CONTRACT DURING CONSTRUCTION. COORDINATE BARRICADE CONSTRUCTION AND APPEARANCE WITH LANDLORD.
 - CUTTING AND PATCHING: WHERE EXISTING CONDITIONS ARE CUT OR DISTURBED TO PERMIT INSTALLATION OF NEW WORK, MATCH AND PATCH EXISTING DISTURBED CONSTRUCTION/FINISH.

- WINDOWS / DOORS:
- ALL DOOR AND WINDOW OPENING DIMENSIONS ARE TO ROUGH OPENING.

- LAYOUT NOTES:
- NOTIFY ARCHITECT IMMEDIATELY OF ANY INCONSISTENCIES OR DISCREPANCIES WITH PLANS IN RELATION TO EXISTING FIELD CONDITIONS.
 - CONSULTANT DRAWINGS ARE SUPPLEMENTAL TO THE ARCHITECTURAL DRAWINGS. IT IS THE RESPONSIBILITY OF THE GENERAL CONTRACTOR TO CROSS CHECK WITH ARCHITECTURAL DRAWINGS PRIOR TO THE ORDERING/ INSTALLATION OF ANY MECHANICAL, PLUMBING, AND ELECTRICAL WORK. ANY DISCREPANCIES BETWEEN THE ARCHITECTURAL AND THE CONSULTING ENGINEERS DRAWINGS SHALL BE BROUGHT TO THE ARCHITECTS ATTENTION FOR IMMEDIATE CLARIFICATION.

PLAN LEGEND

AREA NOT IN SCOPE

WALL TYPES

- A EXISTING WALL
- (1) LAYER 5/8" F.R.T.W. PLYWOOD OVER 6" MTL. STUDS @ 16" O.C. PLYWOOD FROM SLAB TO DECK ABOVE.
- C2 5/8" TYPE 'X' GYP. BD. OVER 3 5/8" MTL. STUDS @ 16" O.C.
- EXISTING INTERIOR WALL, PATCH, REPAIR AS REQD. REMOVE (E) FINISHES AND (E) BACKING ON RESTROOM SIDE. ADD (1) LAYER 5/8" W/P PLYWOOD TO RECEIVE
- C3 NEW WALL TILE FINISH

NOTE: ALL NEW WALLS SHOULD HAVE A SMOOTH FINISH

MAXIMUM ALLOWABLE CLEAR SPAN HEIGHT IN FEET (L/240)
NON-BEARING DRYWALL STEEL STUDS, TRACK AND ACCESSORIES BY CLARK DIETRICH BUILDING SYSTEMS
ICC REPORT NO. ESR-2457

STUD SIZE & GAUGE	12" O/C	16" O/C	24" O/C
1 5/8" x 3 5/8" x 25 GA	14'-8"	13'-4"	11'-8"
1 5/8" x 3 5/8" x 20 GA	18'-1"	16'-6"	14'-4"
1 5/8" x 6" x 20 GA	27'-1"	24'-7"	21'-6"
1 5/8" x 3 5/8" x 18 GA	21'-0"	19'-1"	16'-8"
1 5/8" x 6" x 18 GA	31'-2"	28'-4"	24'-9"

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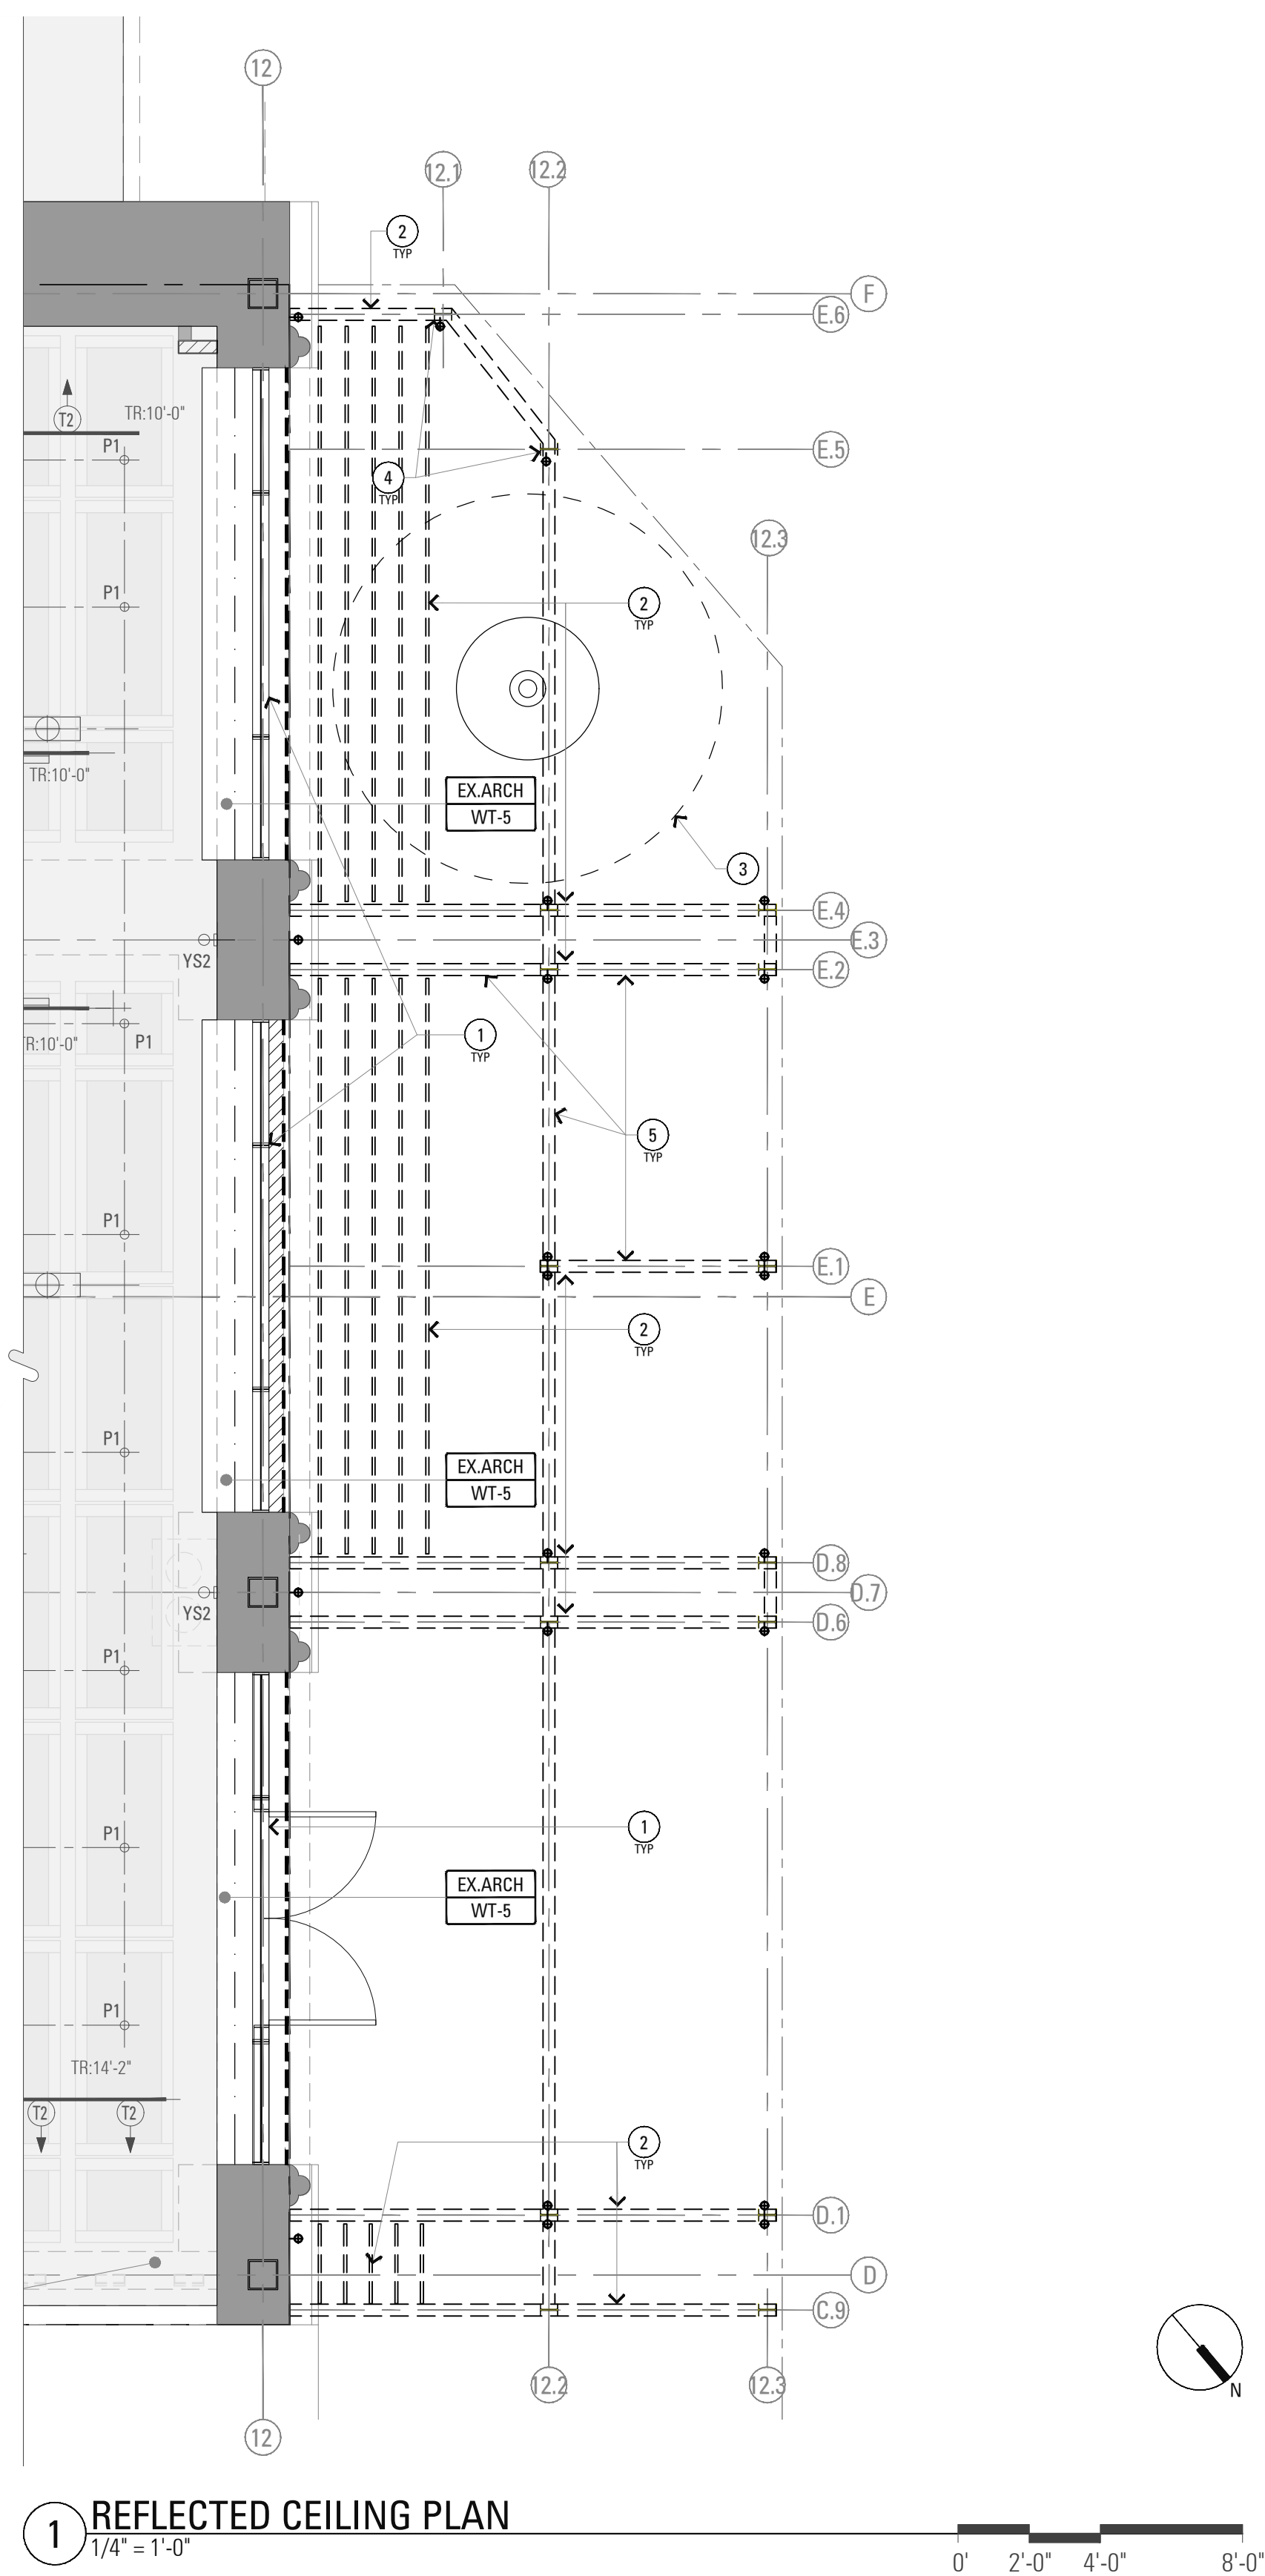
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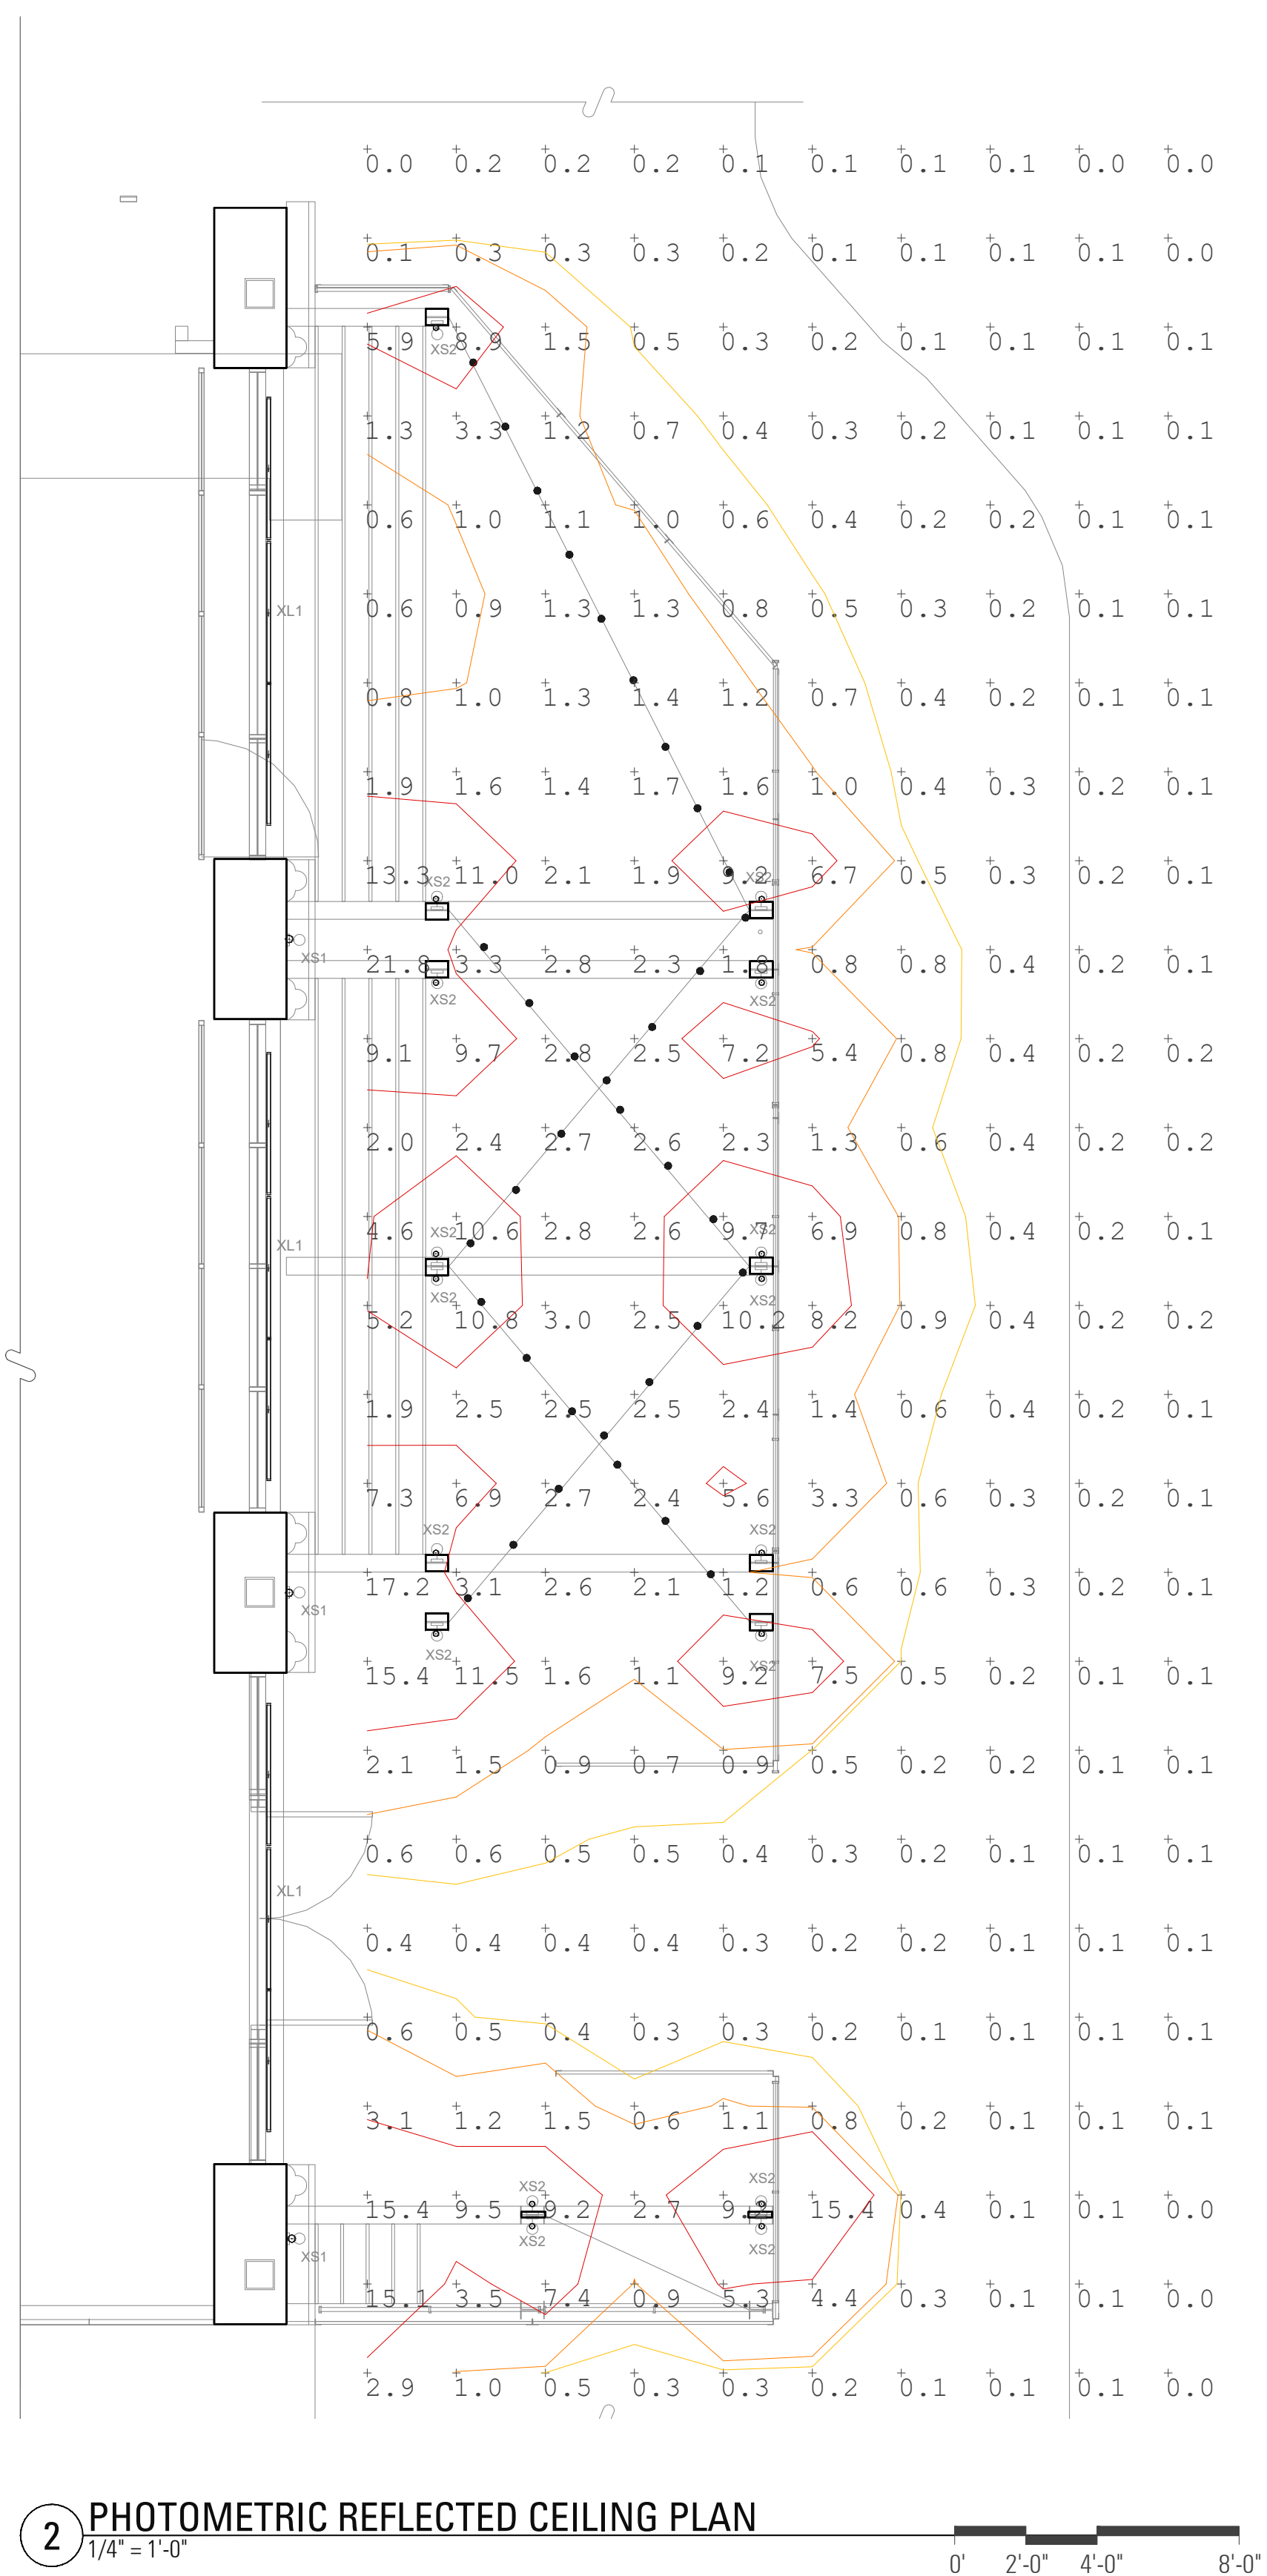
CONSTRUCTION FLOOR PLAN

SHEET NUMBER

A02.01







1 REFLECTED CEILING PLAN
1/4" = 1'-0"



2 PHOTOMETRIC REFLECTED CEILING PLAN
1/4" = 1'-0"

EXTERIOR PHOTOMETRIC REPORT

Calculation Summary							
Label	CalcType	Units	Avg	Max	Min	Avg/Min	Max/Min
Calc Zone 1	Illuminance	Fc	1.82	21.8	0.0	N.A.	N.A.

Luminaire Schedule				
Symbol	Label	LLF	MODEL NUMBER	DESCRIPTION
	XL1	0.800	KBL-F-V-41K-XX-XX-48	SURFACE MOUNTED LINEAR LED
	XL2	0.800	UB-EX_WW_5-14	EXTERIOR LED STRING LIGHTS
	XS1	0.496	DE-LED-TR-X125-FL-9-C-PROTOTYPE	UP & DOWNLIGHT WALL SCONES
	XS2	0.800	HL-3405-3LED-FL	TERRACE SCONCE DOWNLIGHT

KEY NOTES

- ① NEW STOREFRONT GLAZING WITHIN ARCHED OPENING
- ② NEW METAL FRAMING. REFER TO STRUCTURAL DRAWINGS FOR DETAILS.
- ③ CANOPY OF PROPOSED TREE
- ④ COLUMN (N)
 - MATERIAL- WEATHERING STEEL, ASTM A558
 - SECTION- W6x12
- ⑤ RAFTER (N)
 - MATERIAL- WEATHERING STEEL, ASTM A558
 - SECTION- W10x15
- ⑥ PURLIN (N)
 - MATERIAL- WEATHERING STEEL, ASTM A558
 - SECTION- C8x13.75


REFLECTED CEILING PLAN NOTES

1. ALL LIGHTING TO BE LED.
2. EFFECTIVE LIGHTING CONTROLS STANDARD THROUGHOUT.

LIGHTING NOTES

1. UNLESS NOTED OTHERWISE, ALL LIGHTING EQUIPMENT REMOVED AS PART OF THIS CONTRACT SHALL REMAIN THE PROPERTY OF "THE MELT" (THE CLIENT) AND SHALL BE DELIVERED TO CLIENT'S MAINTENANCE FACILITY AFTER REMOVAL.
2. THE CONTRACTOR SHALL COORDINATE ALL WORK AND MATERIALS WITH SPECIAL ATTENTION TO ALL OTHER CONSTRUCTION CONTRACTS.
3. ALL ELECTRICAL & LIGHTING EQUIPMENT SHALL BE PROVIDED COMPLETE WITH ALL ACCESSORIES, HANGERS, SUPPORTS, CONTROLS, ETC FOR A FULLY FUNCTIONING SYSTEM REGARDLESS OF PRESENCE ON PLANS.
4. LOCATION OF FIXTURES AS SHOWN ON THE DRAWINGS ARE APPROXIMATE AND SHALL BE COORDINATED WITH MECHANICAL EQUIPMENT, DUCT, PIPING ETC IN THE FIELD.
5. DESCRIPTIONS, MANUFACTURER'S NAMES AND CATALOG NUMBERS OF LIGHTING FIXTURES ARE SPECIFIED TO ACHIEVE DESIRED LIGHTING LEVELS. REFER TO LIGHTING FIXTURE SPECIFICATION FOR MATERIALS SUBSTITUTIONS.
6. IF CONFLICT IS PRESENT BETWEEN DESCRIPTION AND MODEL #, EQUIPMENT DESCRIPTION SHALL TAKE PRECEDENT.
7. ALL FIXTURES' INSTALLATIONS SHALL BE SUBJECT TO THE REVIEW AND APPROVAL OF THE CLIENT / ARCHITECT.
8. CONTRACTOR SHALL FIELD VERIFY THE MOUNTING HEIGHT OF SUSPENDED/PENDANT LIGHT FIXTURE BEFORE PURCHASING LIGHT FIXTURES. AND THE LENGTH OF HANGING CABLE OR STEM.
9. SEE EXHIBIT SHEETS FOR SPECIFICATION ON LIGHTING FIXTURE

KEY PLAN

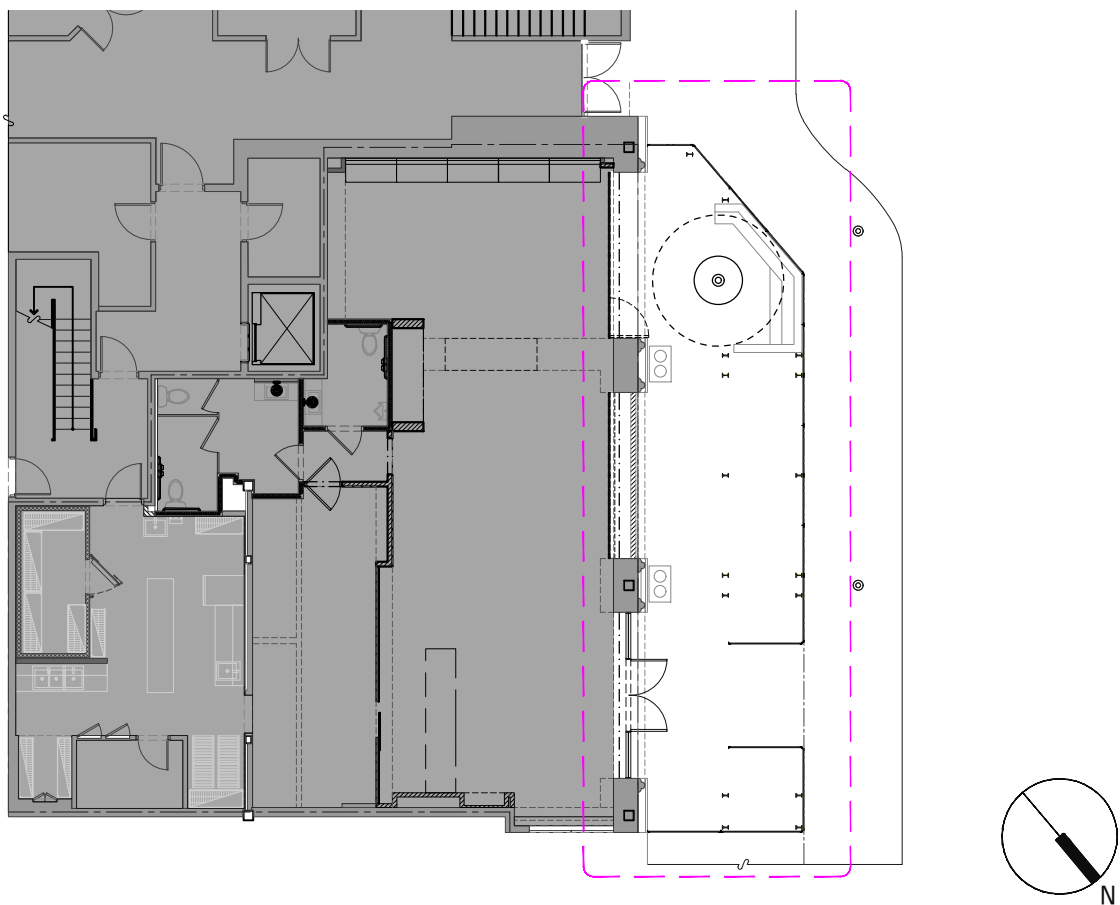

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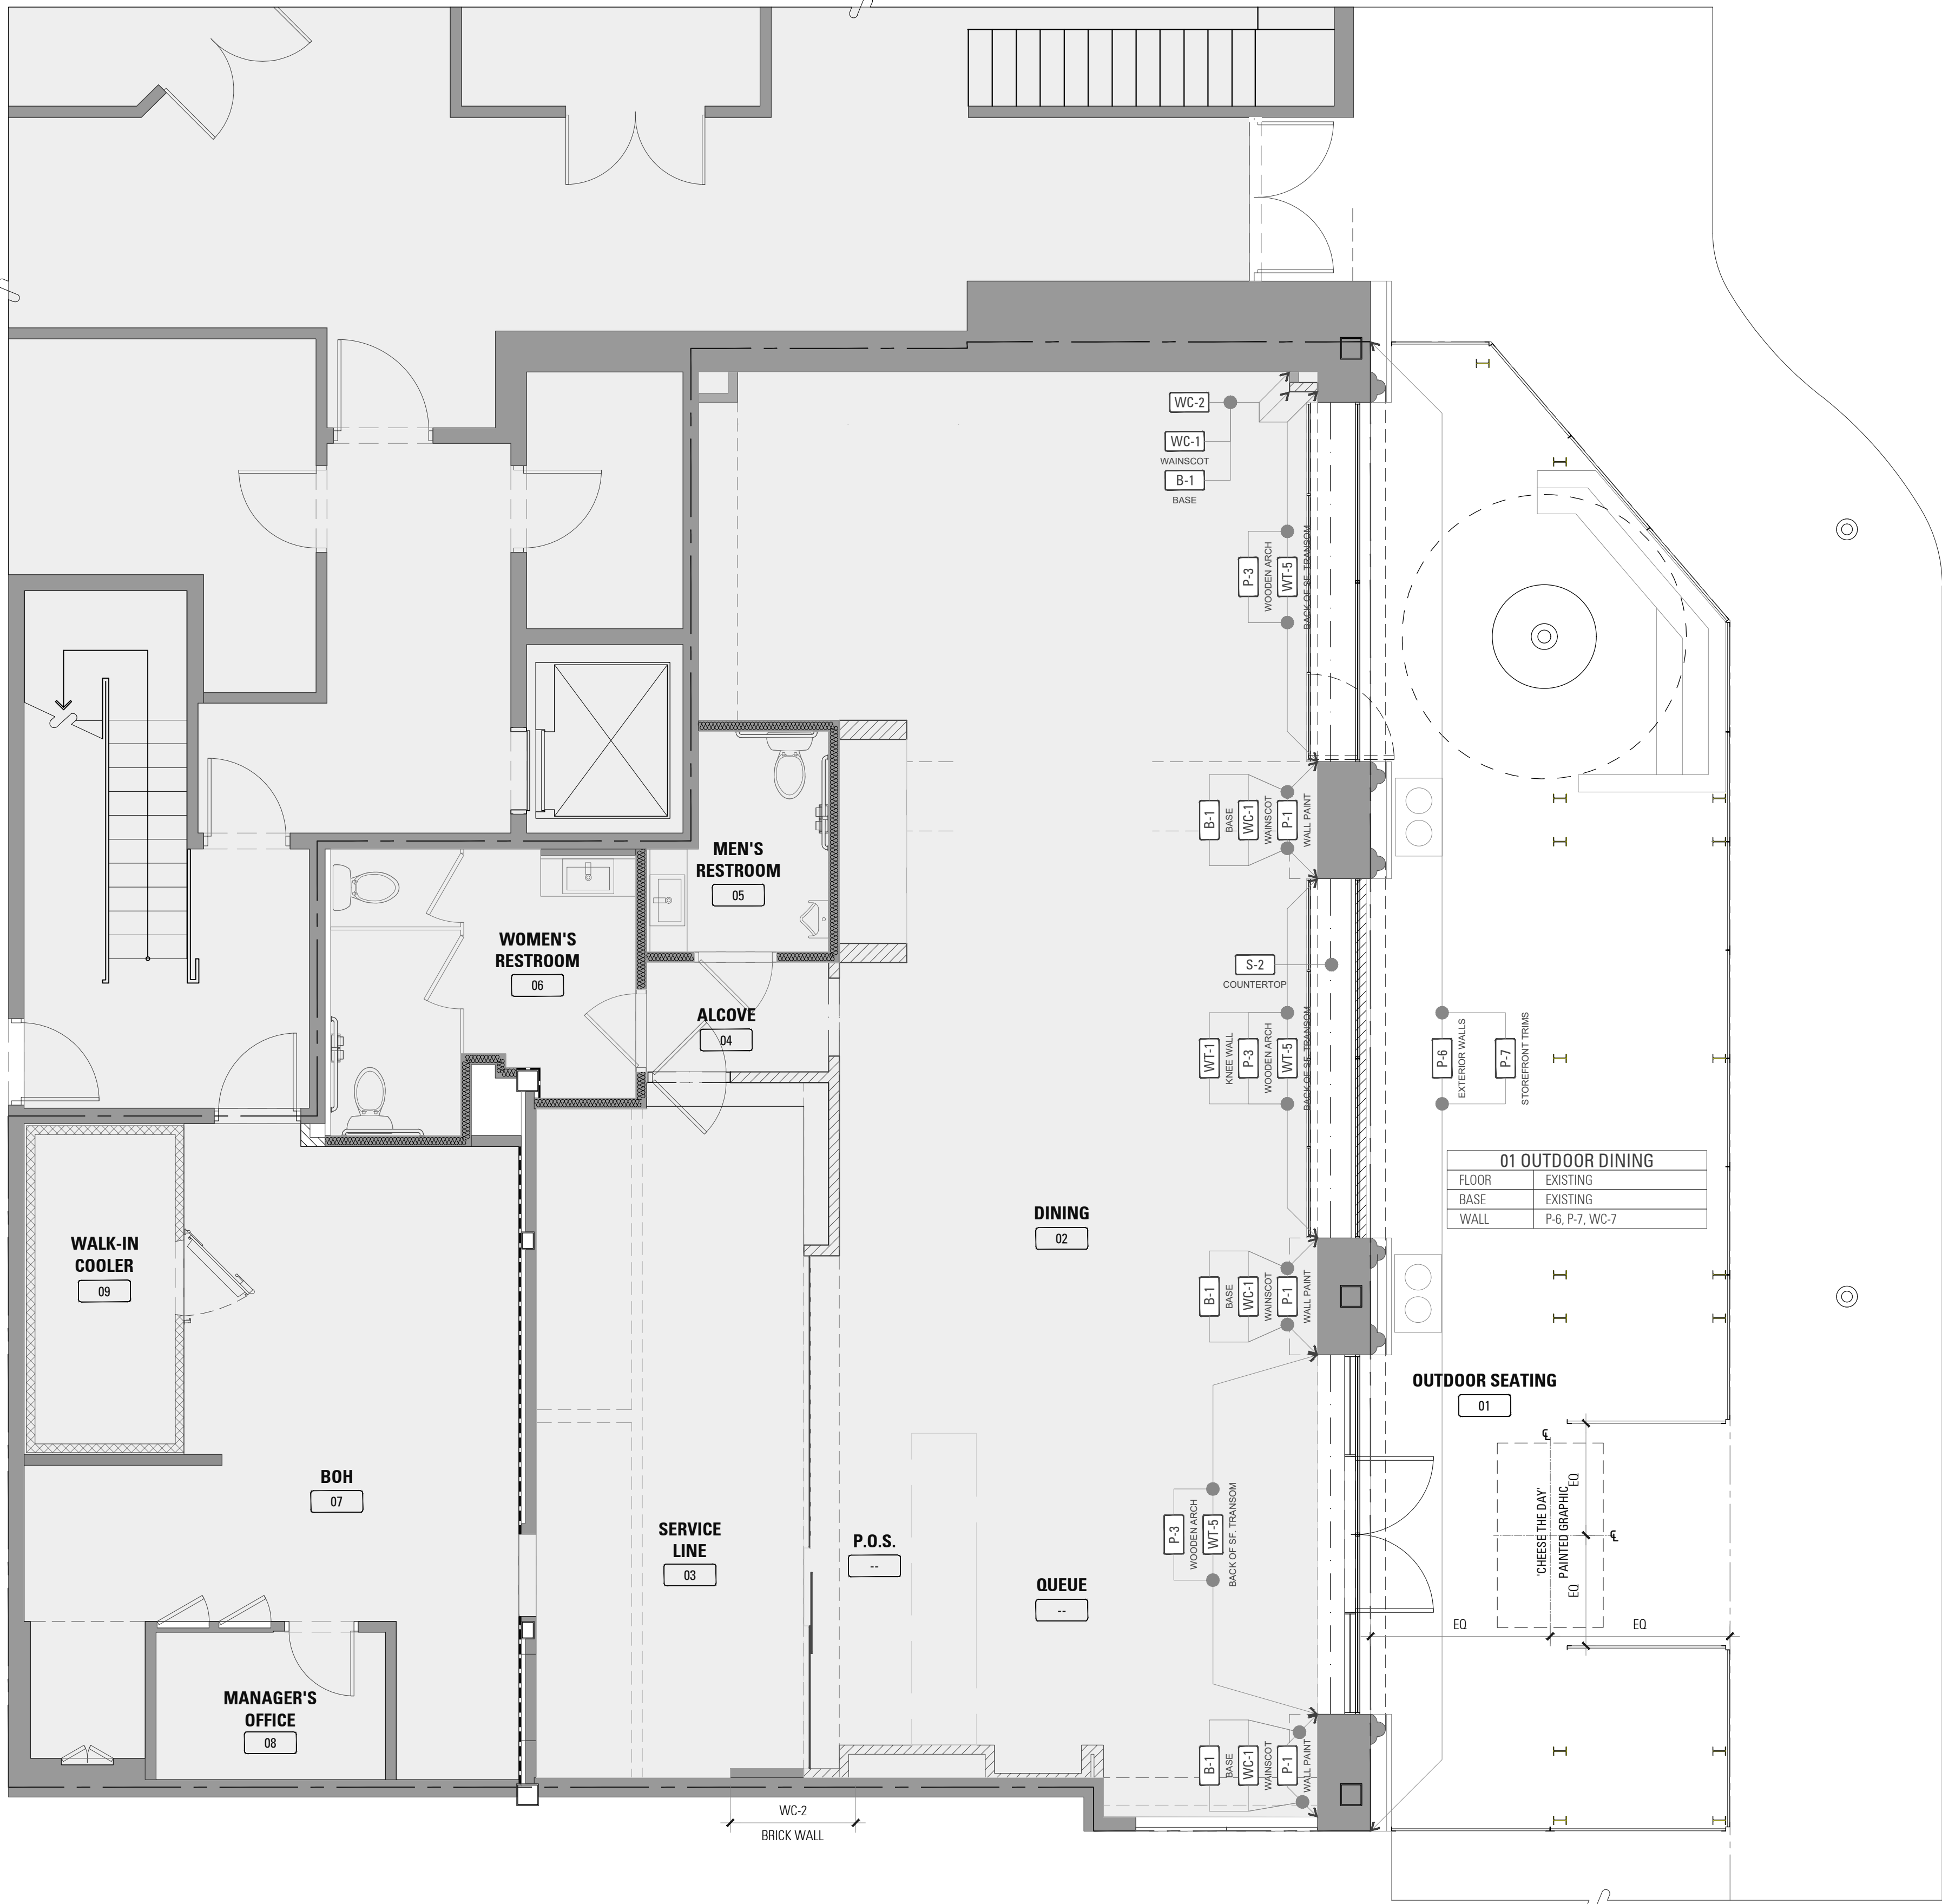
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PLAN AND

PHOTOMETRIC RCP

SHEET NUMBER


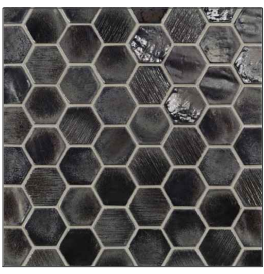



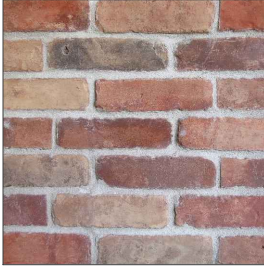
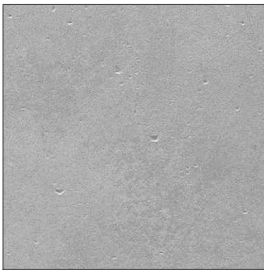



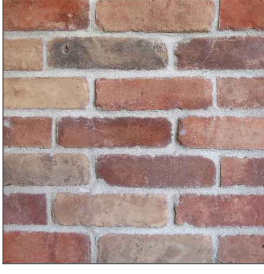
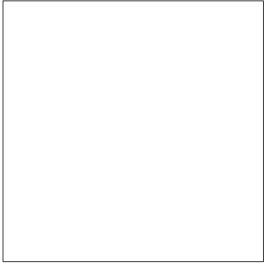


A03.01



1 FINISH PLAN
1/4" = 1'-0"







WALL FINISHES

SWATCH	TAG	PRODUCT/ FINISH	MANUFACTURER	LOCATION	REMARKS
	WT-1	"RUSTICA METAL" PORCELAIN TILE, SATIN FINISH. 1/2" THK JUMBO SLAB 64"H X 128"L, CUT TO SIZE	CORIAN - ENDURA	INTERIOR/EXTERIOR	
	WT-2	4" HEX TILE, 5/16"THK - SHINJU COLOR: OLYMPIA	LUNADA BAYTILES	INTERIOR	
	WT-3	4" HEX, 5/16"THK - CERAMIC HEX TILE, SHINJU. FOR ACCENTS - COLOR: PACIFIC. PLACE AS NOTED IN ELEVATIONS	LUNADA BAYTILES	INTERIOR	
	WT-4	PORCELAIN TILE- LINK- HOOK, 9 MM, 12" X 24"	CAESAR CERAMICS	INTERIOR	
	WC-1	AWP3030 - 17-7/8"H X 119-5/16"L - 5/8"THK VERTICALLY ORIENTED, 9 RIBS / PANEL RIBBED COLOR: INDIGO	NICHIHA	INTERIOR	
	WC-2	FAUX BRICK PANELS, NUSTONE	CREATIVE PALETTE	INTERIOR	
	WC-3	AWP3030 - 17-7/8"H X 119-5/16"L - 5/8" THK HORIZONTALLY ORIENTED, INDUSTRIAL BLOCK; COLOR: GRAY	NICHIHA	INTERIOR	
	WC-4	BRUSHED NON-DIRECTIONAL STAINLESS STEEL	CUSTOM - LOCALLY PROCURED	INTERIOR	BY GC
	WC-5	NUSTONE- CUSTOM FAUX CONCRETE PANEL, 8"H X 60"L	CREATIVE PALETTE	INTERIOR	
	WC-6	LOCAL WOOD PLANKS	VARIES	INTERIOR	
	WC-7	PEPPERMILL- THIN BRICK FLATS : 2-1/4"H X 1/2"W X 7-5/8"L - SKU 6060011298 THIN BRICK CORNERS: 2-1/4"H X 1/2"W X 7-5/8"L - SKU 6060011298	GENERAL SHALE	INTERIOR	
	WC-8	VINYL WALL COVERING WITH CUSTOM WHITE ON BLACK PRINT	DIGICO	INTERIOR	CUSTOM "ICONOGRAPHY"
	WC-9	CORRUGATED METAL	UNION	INTERIOR	BY GC
	WC-10	EBONY WOOD	ANTHOLOGY WOOD / CREATIVE PALETTE	INTERIOR	



WALL FINISHES

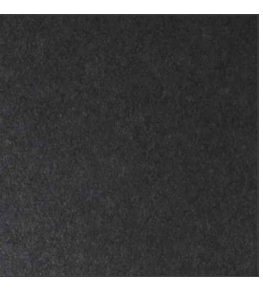SWATCH	TAG	PRODUCT/ FINISH	MANUFACTURER	LOCATION	REMARKS
	WC-11	KANWEER STOREFRONT	KANWEER FINISH NO 29	EXTERIOR	AA-M10C21A44 Architectural Class 1 (0.7 mils minimum)
	WC-12	RAYNOR GARAGE BLACK ANO - 305 AE	RAYNOR GARAGE	EXTERIOR	
	WC-13	MAPES PANEL STANDARD COLORS- BLACK	MAPES PANEL	EXTERIOR	
	WC-14	ONE-WAY PRIVACY FILM	SOLYX	INTERIOR	BY GC

SURFACE FINISHES

	S-1	RESIN INFUSED PAPER SURFACE 1-1/2" THK - VARYING LENGTHS UP TO 120" - GRAYS HARBOR COLOR , LEATHERED FINISH	CROSSVILLE	INTERIOR	
	S-2	SOLID SURFACE:1/2" THK - VARYING LENGTH UP TO 144" WIDTH UP TO 36 " - COLOR: NEUTRAL CONCRETE	CROSSVILLE	INTERIOR	
	S-3	LAMINATE	WILSONART	INTERIOR	
	CR-1	HERITAGE OAK WOOD	R2L MILLWORK WILSONART	INTERIOR	CUSTOM LOCALLY PROCURED BY GC


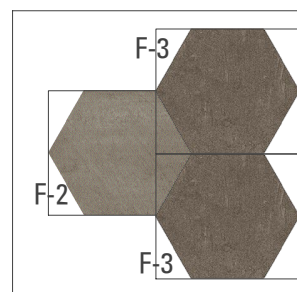
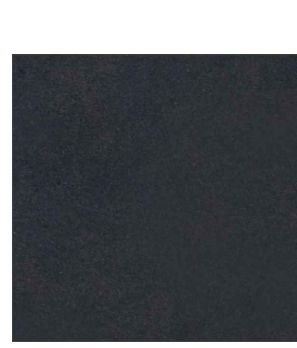

PAINT FINISHES

	P-1	SW7015 - REPOSE GRAY	SHERWIN WILLIAMS	INTERIOR	
	P-2	SW7076 - CYBERSPACE - EGGSHELL & SEMI-GLOSS	SHERWIN WILLIAMS	INTERIOR	
	P-3	SW6258 - TRICORN BLACK - POWDER COAT, MATTE (DRY-FALL FOR CEILING)	SHERWIN WILLIAMS	INTERIOR/ EXTERIOR	
	P-4	K05223000 - CHALKBOARD BLACK	KRYLON	INTERIOR	
	P-5	SW6899 - NASTURTIIUM	SHERWIN WILLIAMS	INTERIOR	

PAINT FINISHES

SWATCH	TAG	PRODUCT/ FINISH	MANUFACTURER	LOCATION	REMARKS
	P-6	SW7019 - GAUNTLET GRAY - EGGSHELL	SHERWIN WILLIAMS	EXTERIOR	
	P-7	SW7048 - URBANE BRONZE - SEMI GLOSS	SHERWIN WILLIAMS	EXTERIOR	
	P-8	A46C00400 - FAUX IMPRESSION LATEX GLAZE	SHERWIN WILLIAMS	INTERIOR	
	P-9	SW9170 - ACIER	SHERWIN WILLIAMS	INTERIOR	

FLOORING/ BASE FINISHES

	F-1	PORCELAIN TILE	ATLAS CONCORDE - RECTANGULAR - BOHO SMOKE - 24 IN X 48 IN	INTERIOR	
	F-2 F-3	PORCELAIN TILE	ATLAS CONCORDE F-2 BOHO SMOKE F-3 COVE STORM HEX-9 IN X 9 IN	INTERIOR	
	B-1	BLACKENED STEEL	SCHLUTER SYSTEMS	INTERIOR	CUSTOM- LOCALLY PROCURED BY GC
	B-2	BRUSHED NON-DIRECTIONAL STAINLESS STEEL	SCHLUTER SYSTEMS	INTERIOR	CUSTOM - LOCALLY PROCURED BY GC

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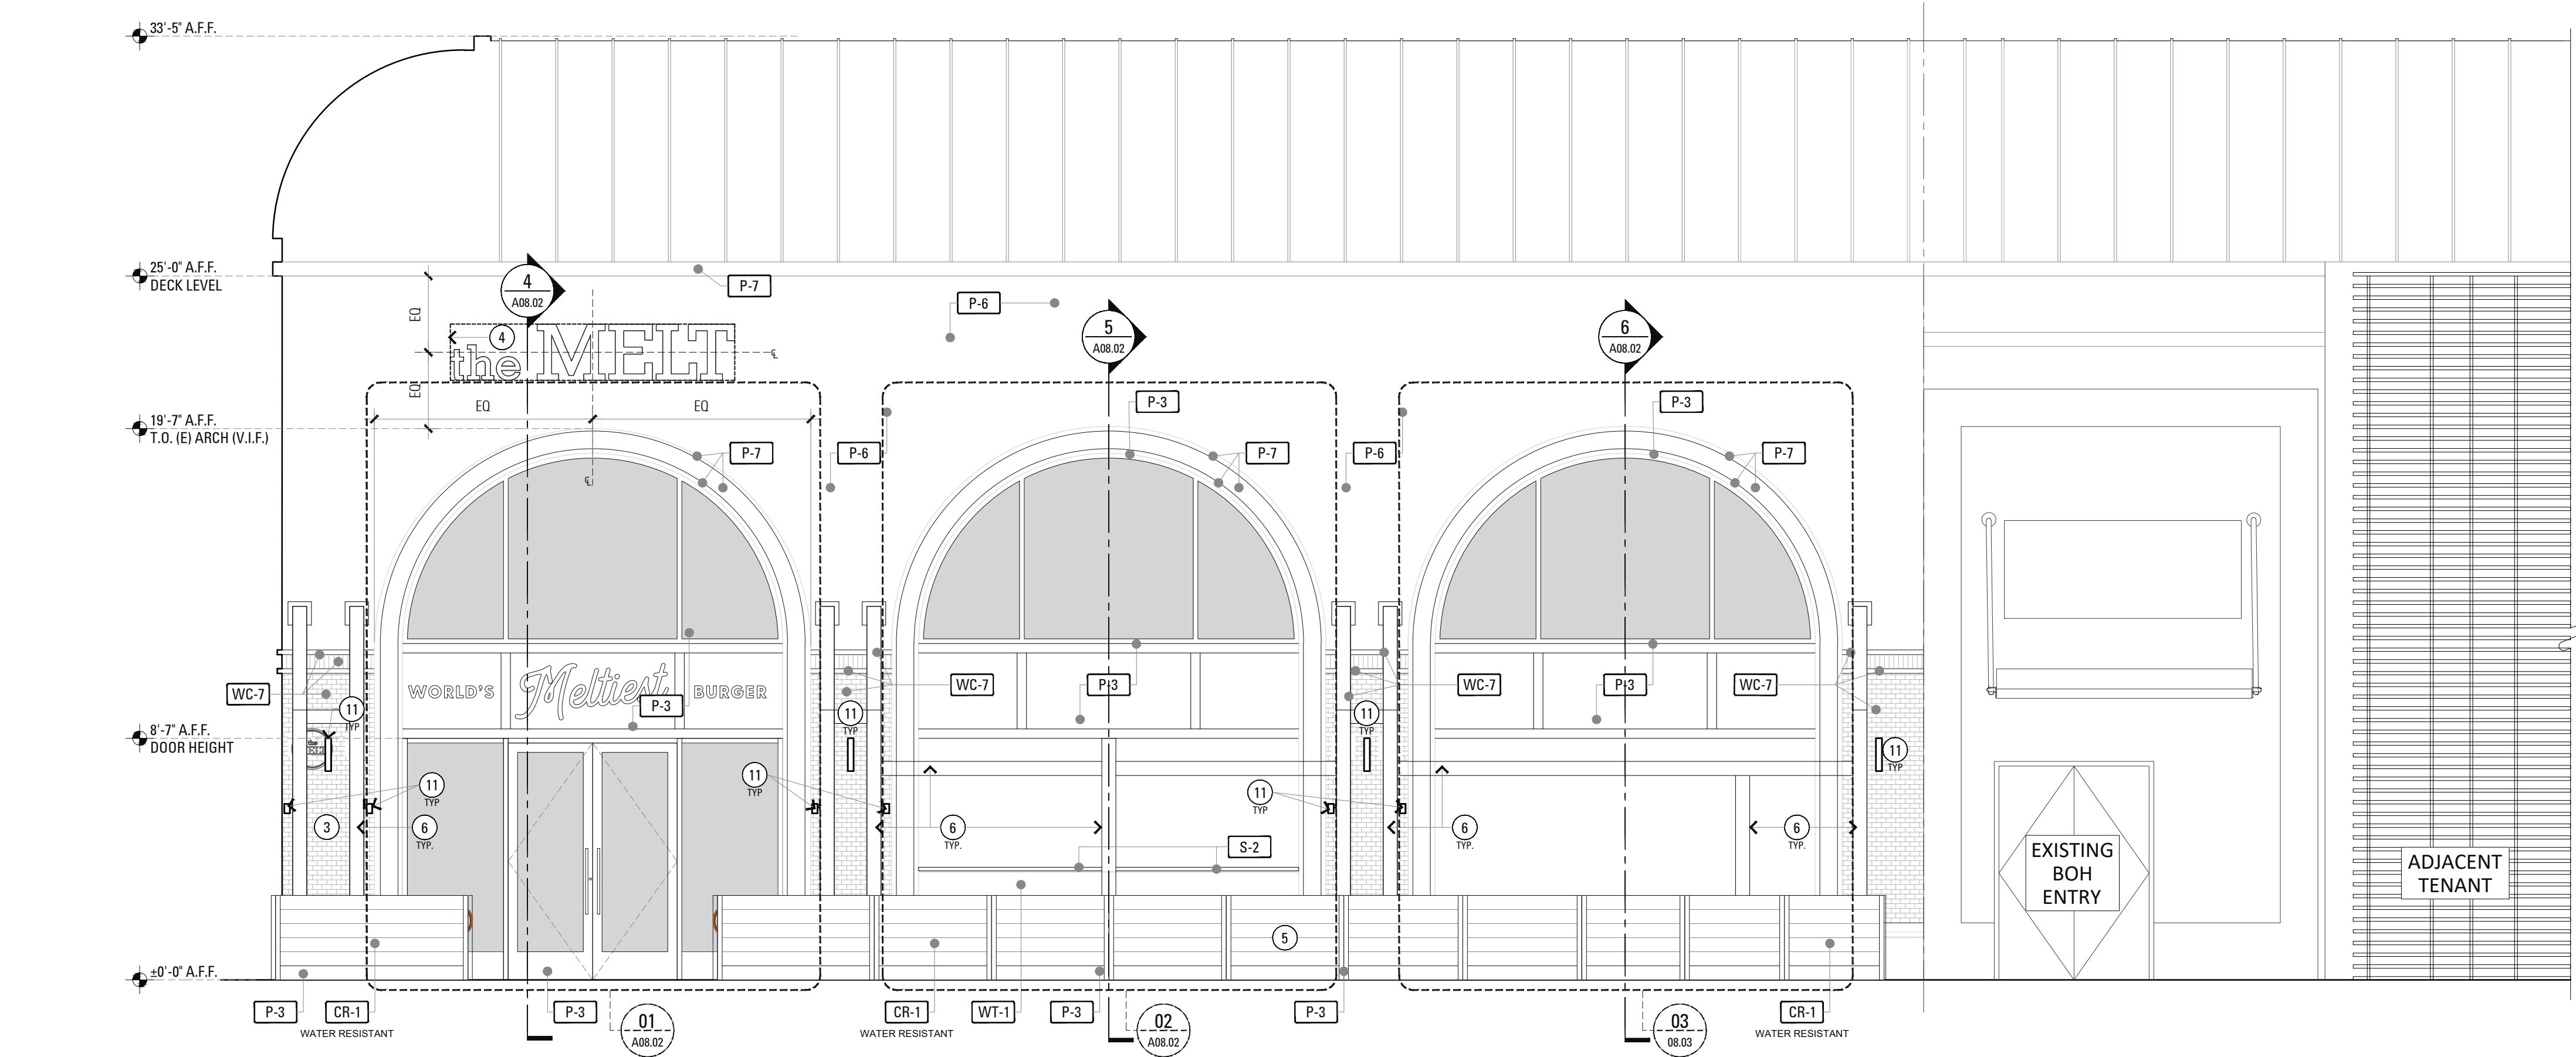
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FINISH SCHEDULE


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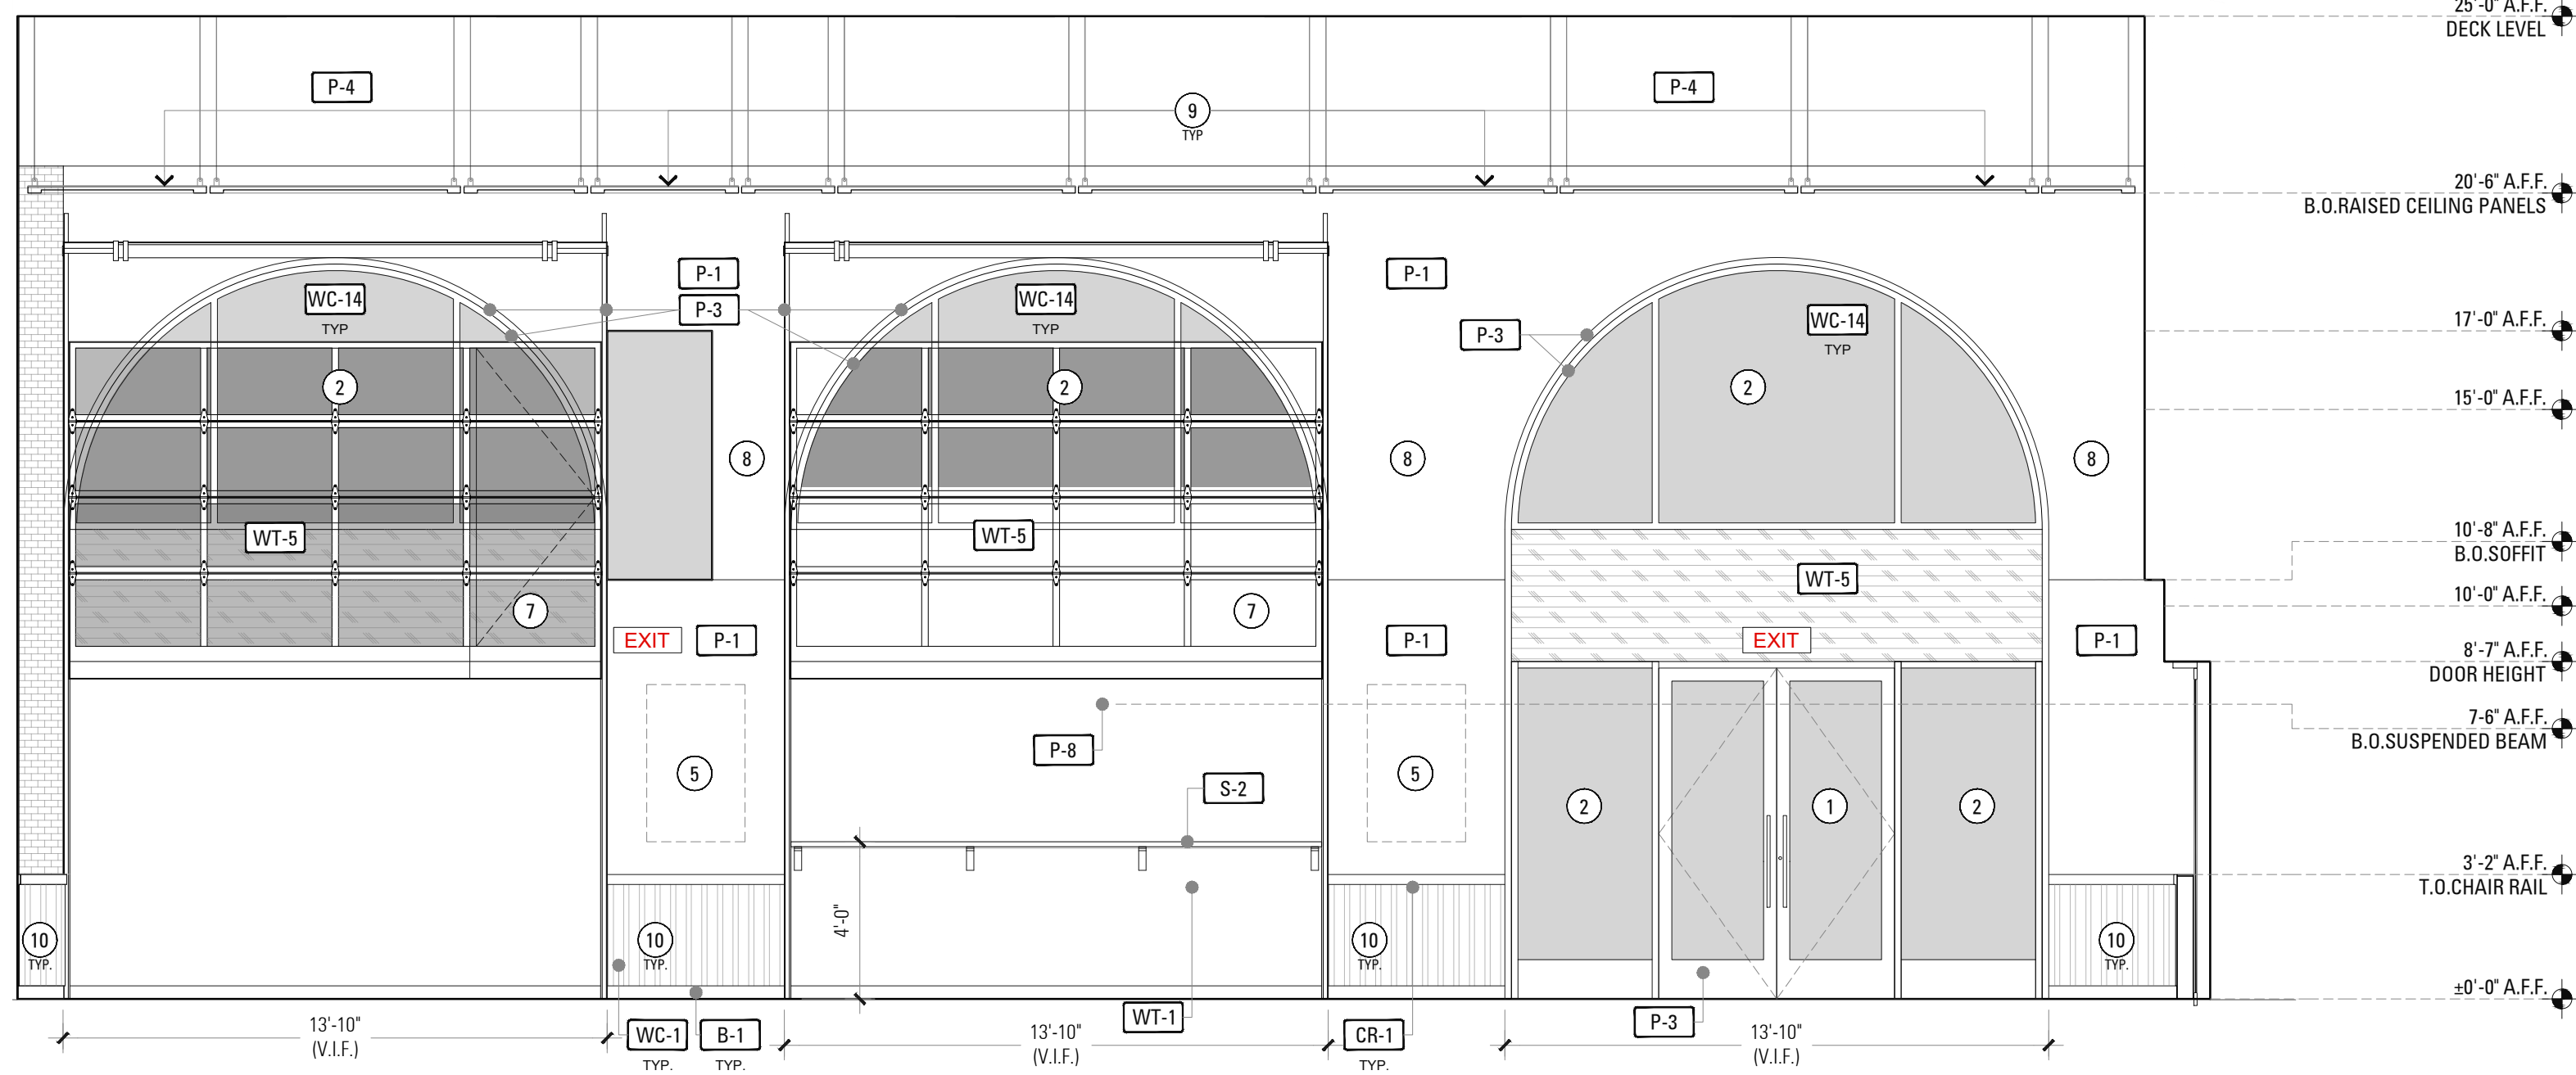
THE MELT, STANFORD
180 EL CAMINO REAL, SUITE 705A, BLDG. E,
PALO ALTO, CALIFORNIA 94304



3 NORTH WEST ELEVATION (EXTERIOR)
1/4" = 1'-0"



1 SOUTH WEST ELEVATION (EXTERIOR)
1/4" = 1'-0"

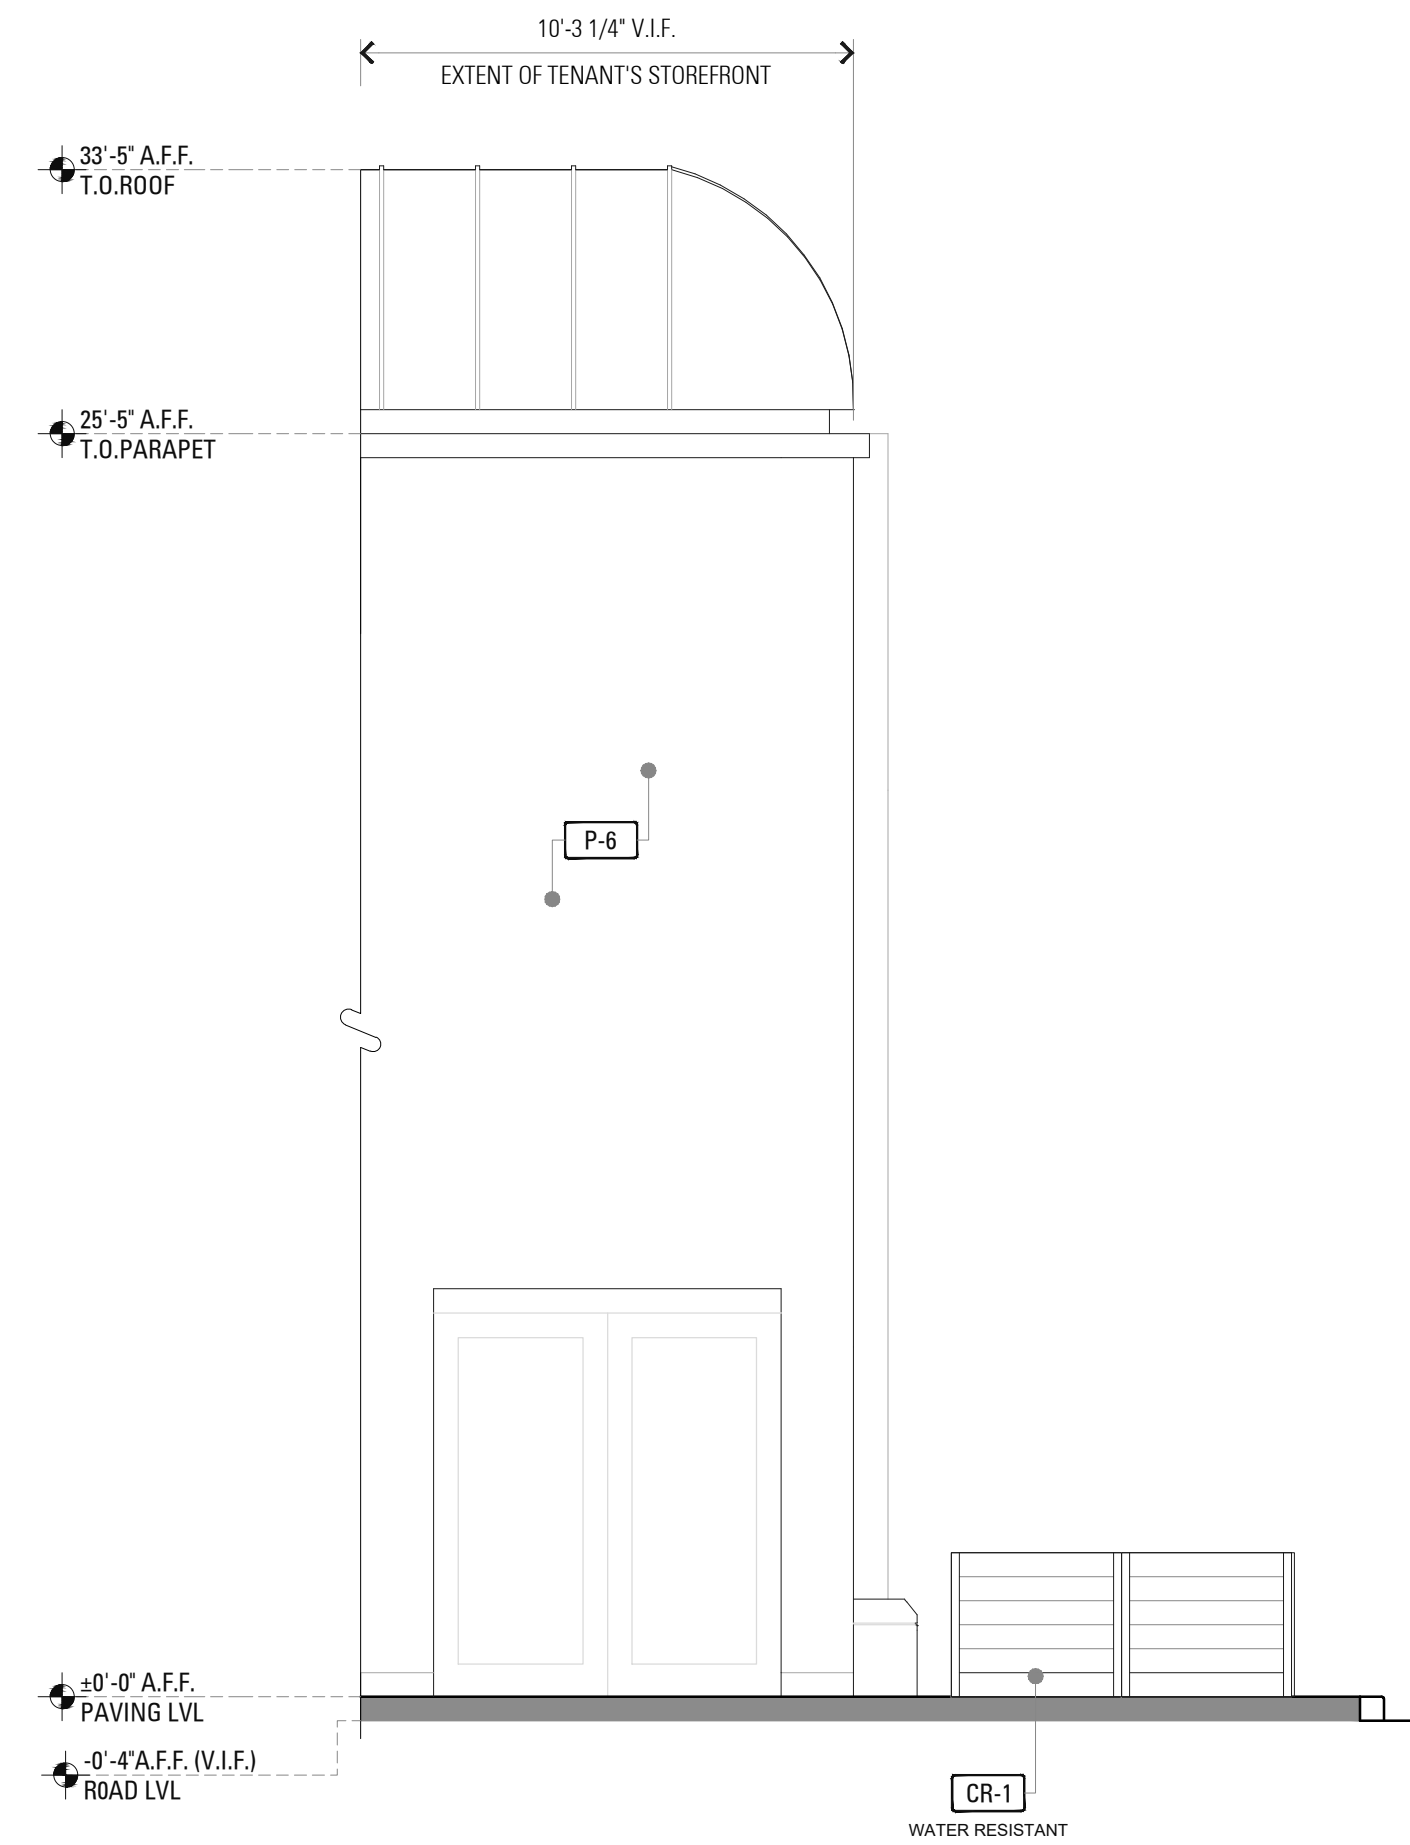

2 NORTH WEST ELEVATION (INTERIOR)
1/4" = 1'-0"

ELEVATION KEY NOTES

- 1 NEW ENTRY DOOR. REFER TO DOOR SCHEDULE FOR DETAILS.
- 2 NEW STOREFRONT GLAZING.
- 3 NEW SIGNAGE. UNDER SEPERATE PERMIT
- 4 ILLUMINATED LOGO FIXED ON THE WALL SURFACE. UNDER SEPARATE PERMIT
- 5 NEW FENCING.
- 6 NEW METAL FRAMING. REFER TO STRUCTURAL DRAWINGS FOR DETAILS
- 7 NEW RAYNOR GARAGE DOOR. SEE DETAIL A ON SHEET A08.03
- 8 EXISTING G.W.B. SOFFIT & FRAMING. PATCH & REPAIR TO RECEIVE NEW FINISH.
- 9 EXISTING CEILING TO BE RAISED ABOVE THE SPRING-POINT OF THE ARCH AND PAINTED P-4
- 10 WAINSCOT PANEL. FIELD VERIFY ALL PANEL DIMENSIONS PRIOR TO FABRICATION.
- 11 NEW LIGHTS/SCONCES

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PH: 510-459-5138

STAMP & SEAL:

PROJECT CONSULTANT:

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SAN JOSE CA 95138

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CLIENT:

the Melt

THE MELT, STANFORD
180 EL CAMINO REAL, SUITE 705A, BLDG. E,
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PROJECT:

PROJECT#: GA21-MLT004
DOCUMENT DATE: 07-05-22
DOCUMENT PHASE:

ARB SET

DATE: 07-05-22
ISSUE: ARB SET

DRAWN BY: NR

CHECKED BY: KCR


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**STOREFRONT
ELEVATIONS**


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A08.01


KEY ELEVATION




4 KEY ELEVATION
1/4" = 1'-0"

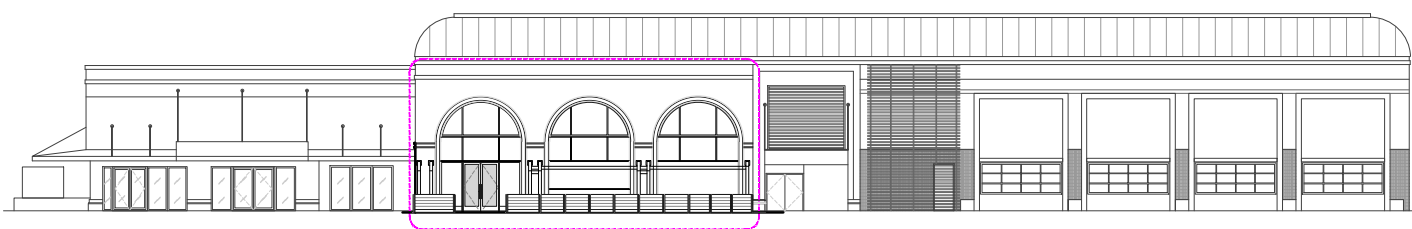

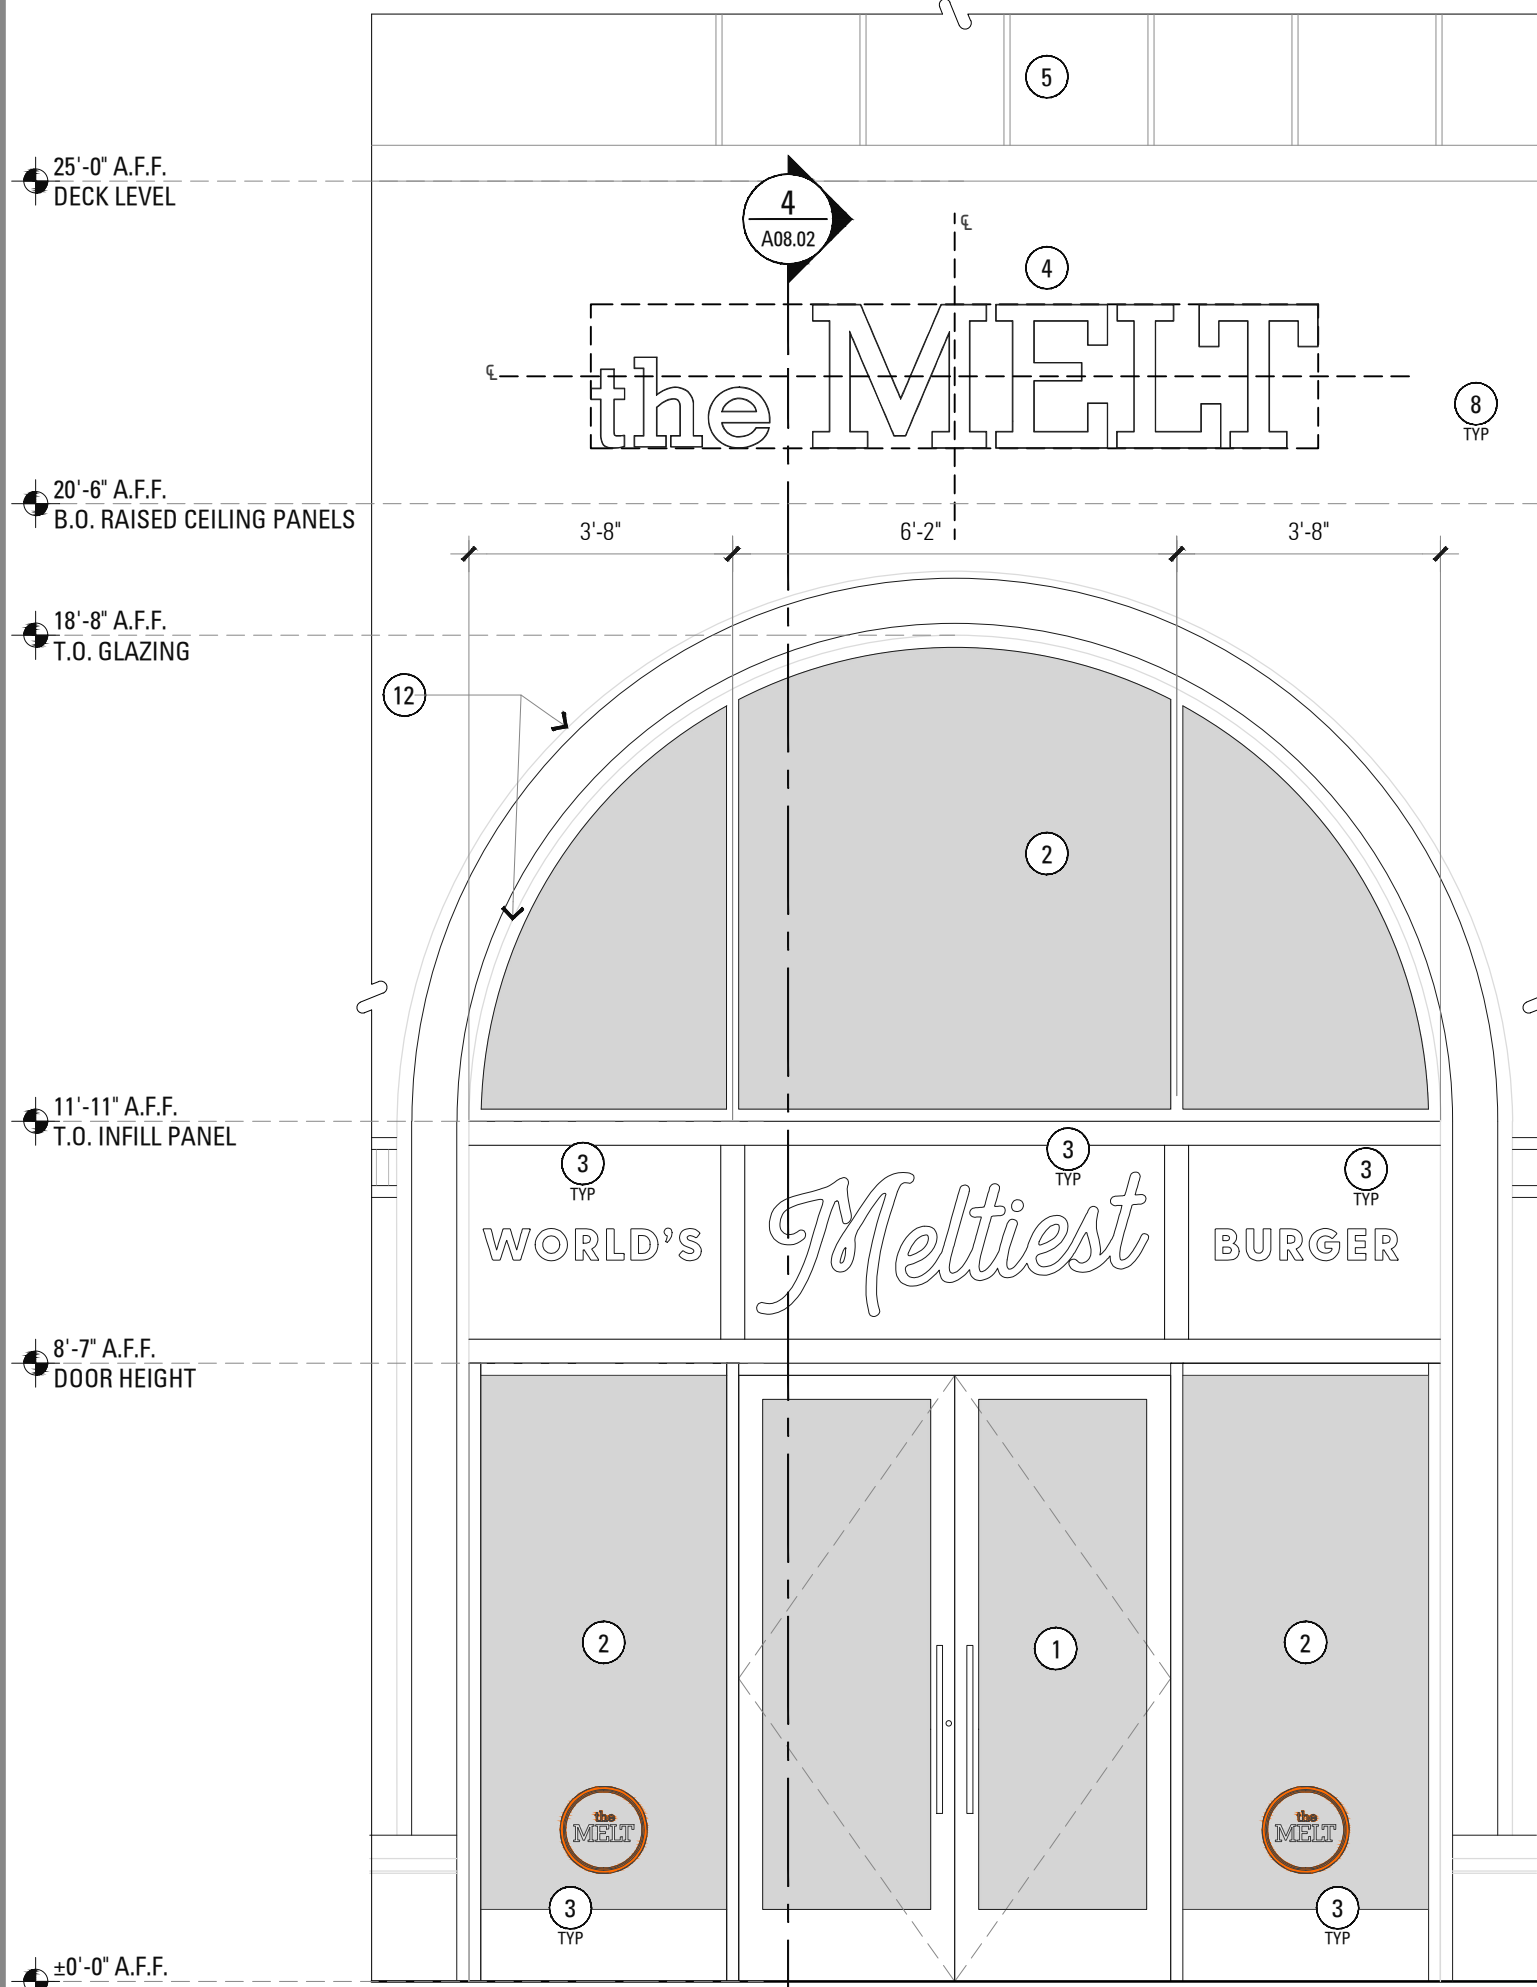
1 ELEVATION 1
3/8" = 1'-0"

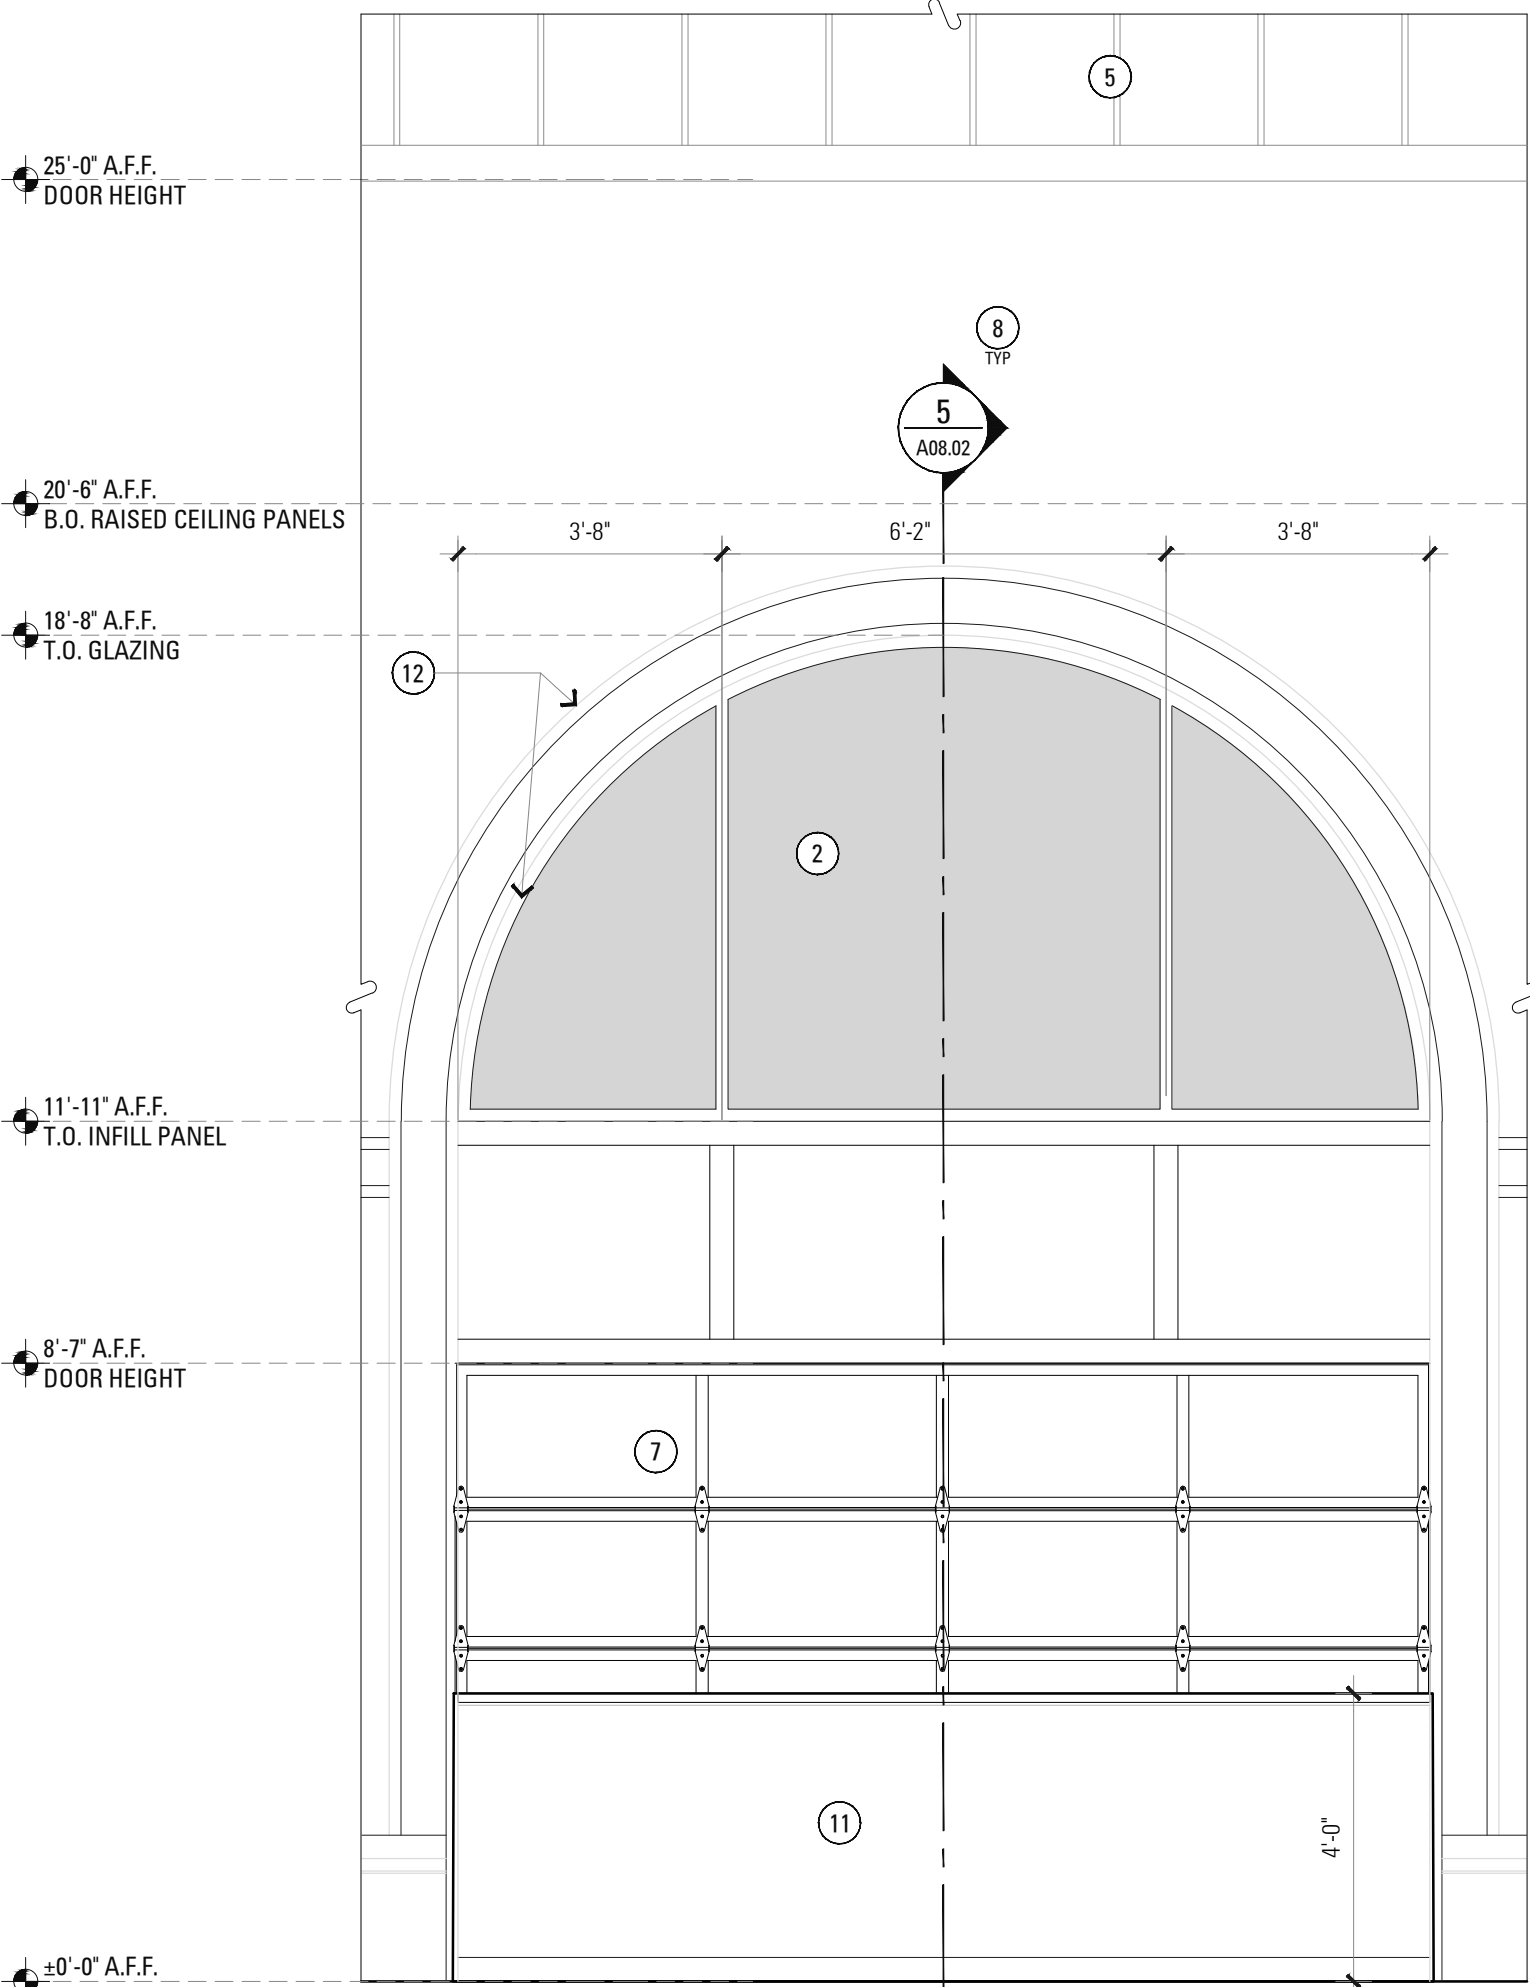


2 ELEVATION 2
3/8" = 1'-0"

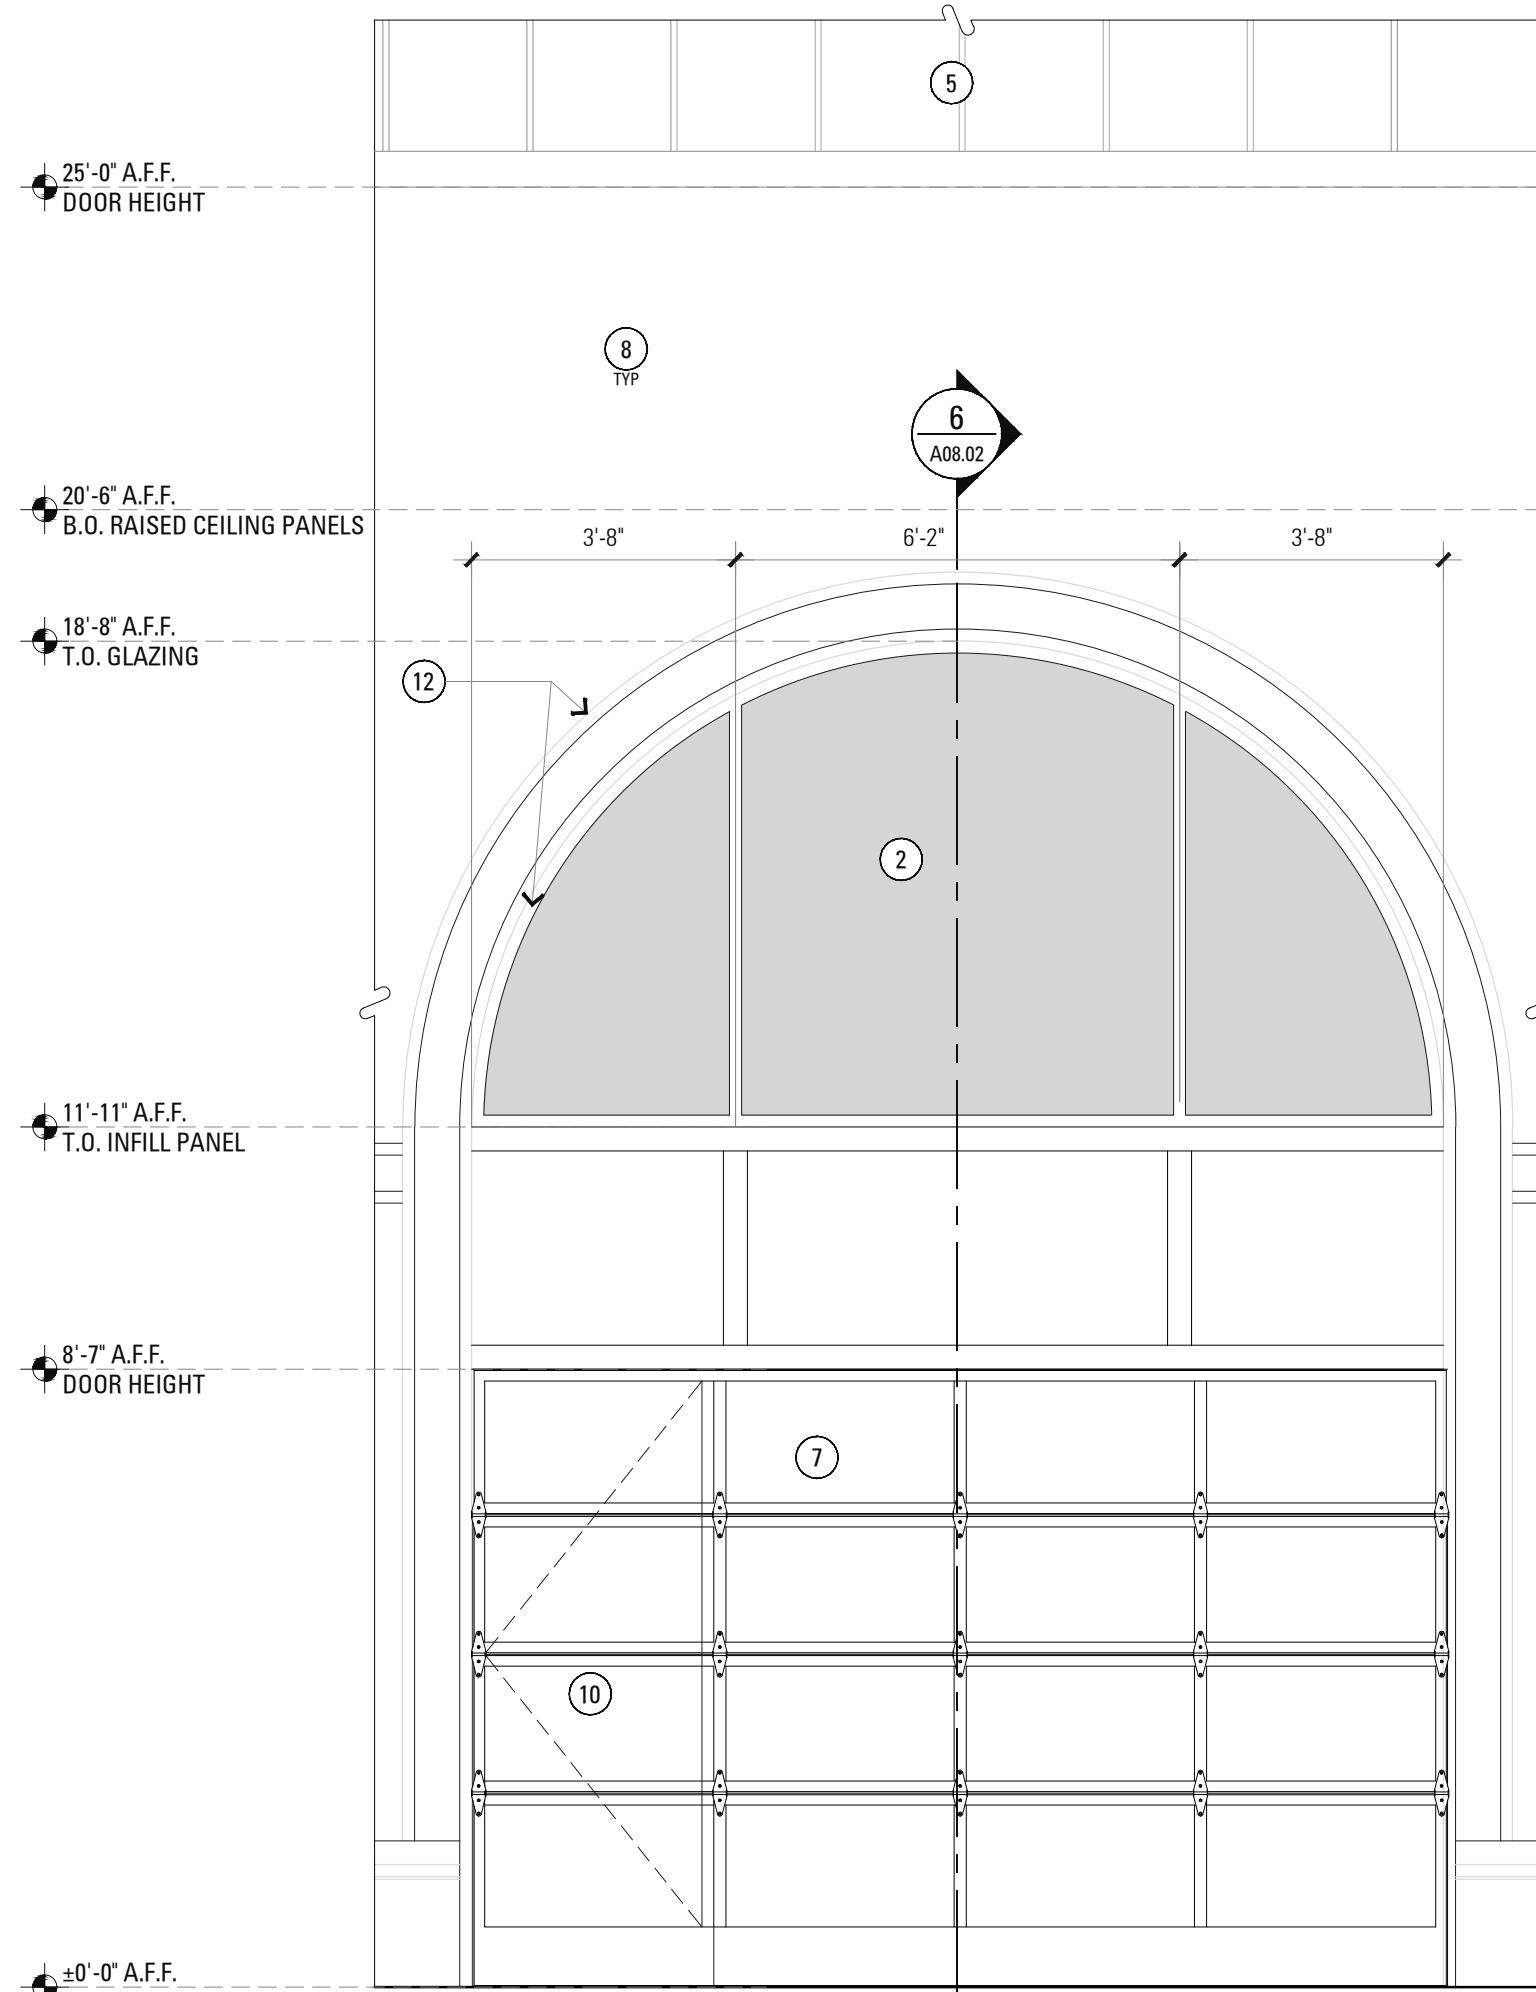


3 ELEVATION 3
3/8" = 1'-0"

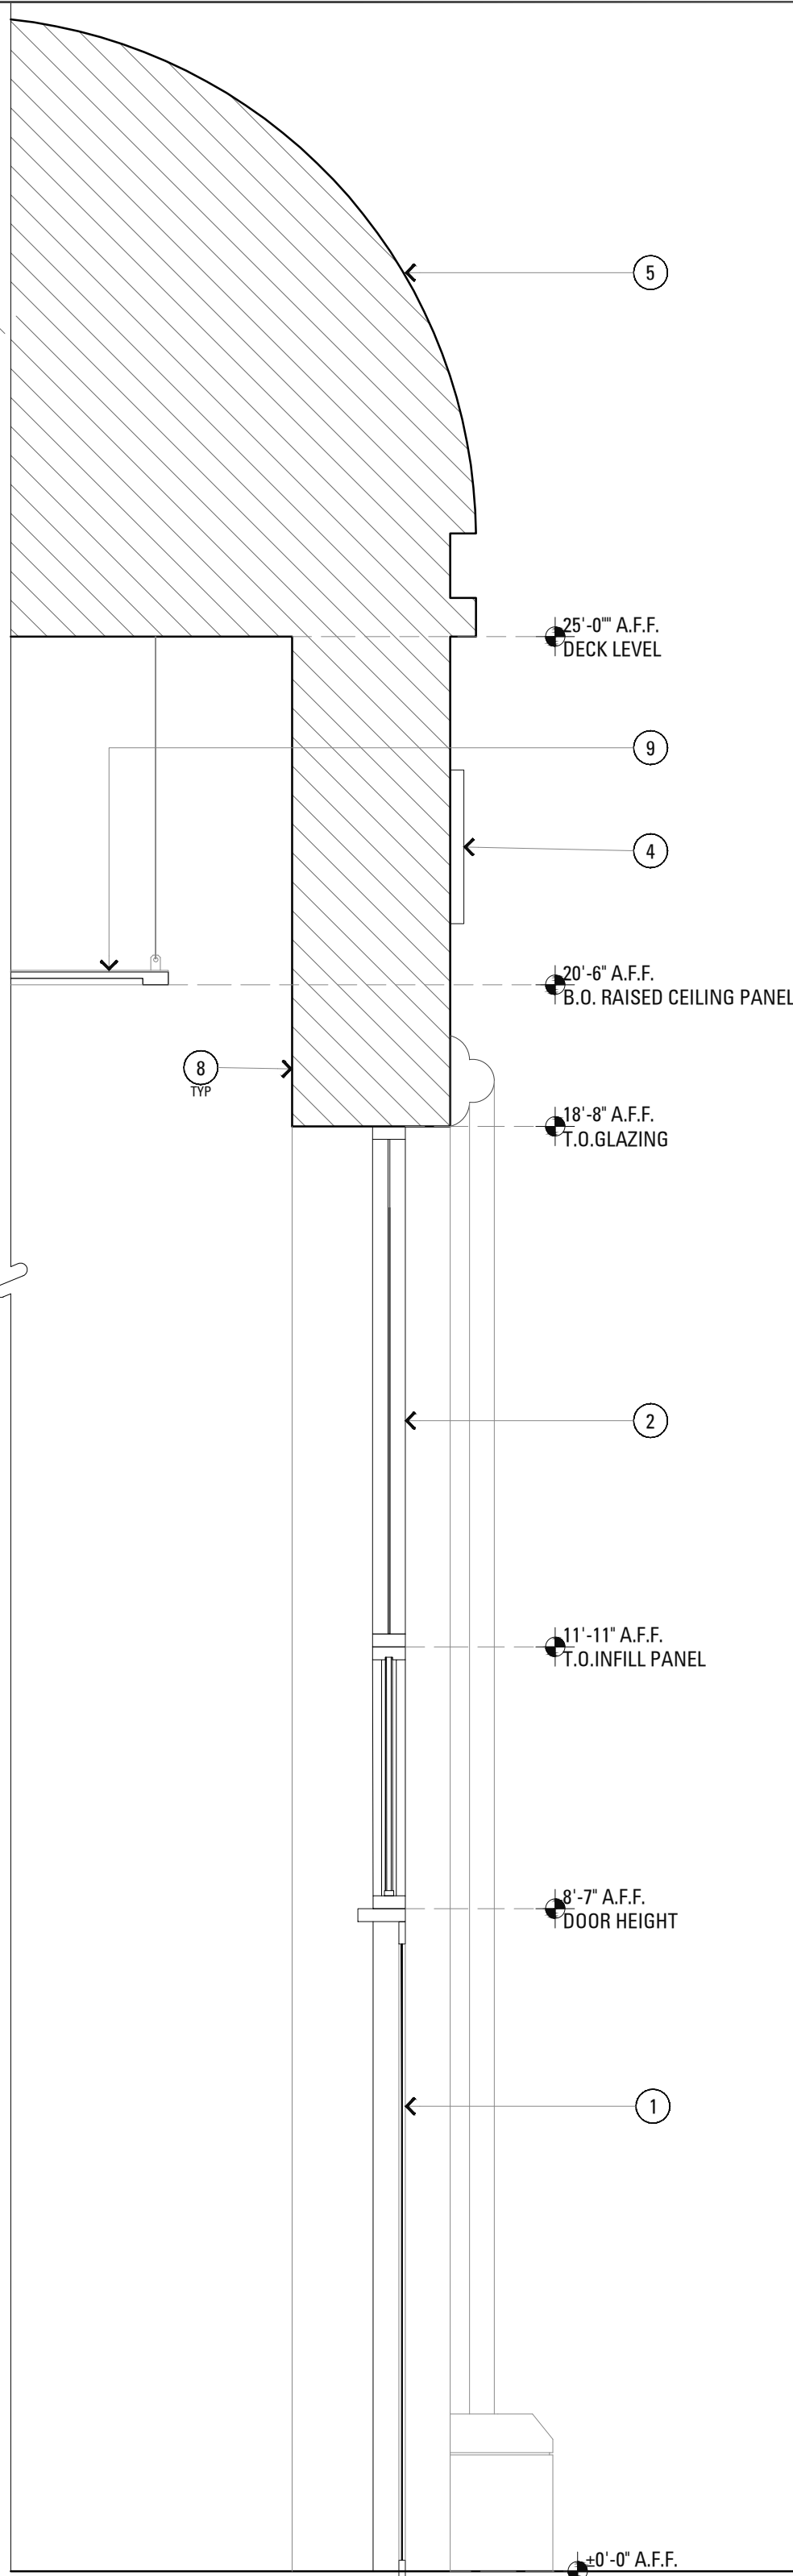

4 SECTION
1/2" = 1'-0"

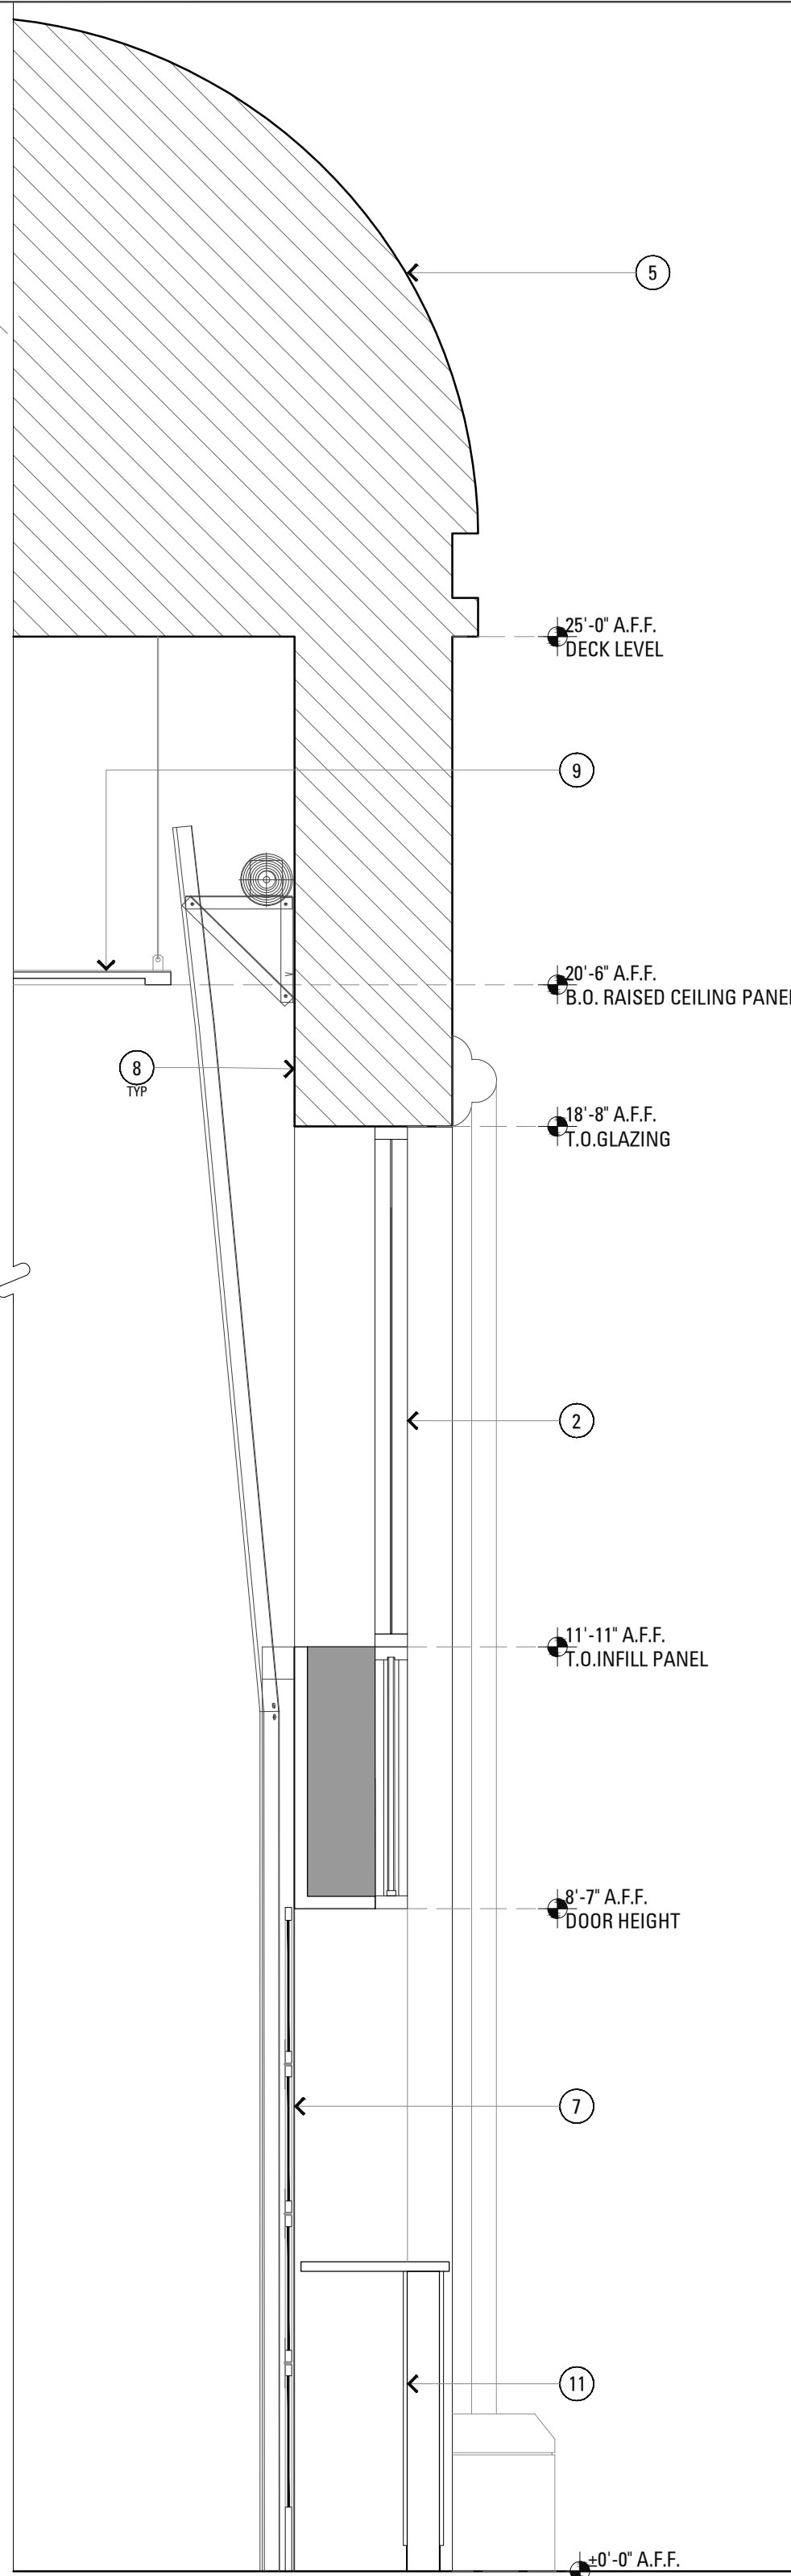

5 SECTION
1/2" = 1'-0"

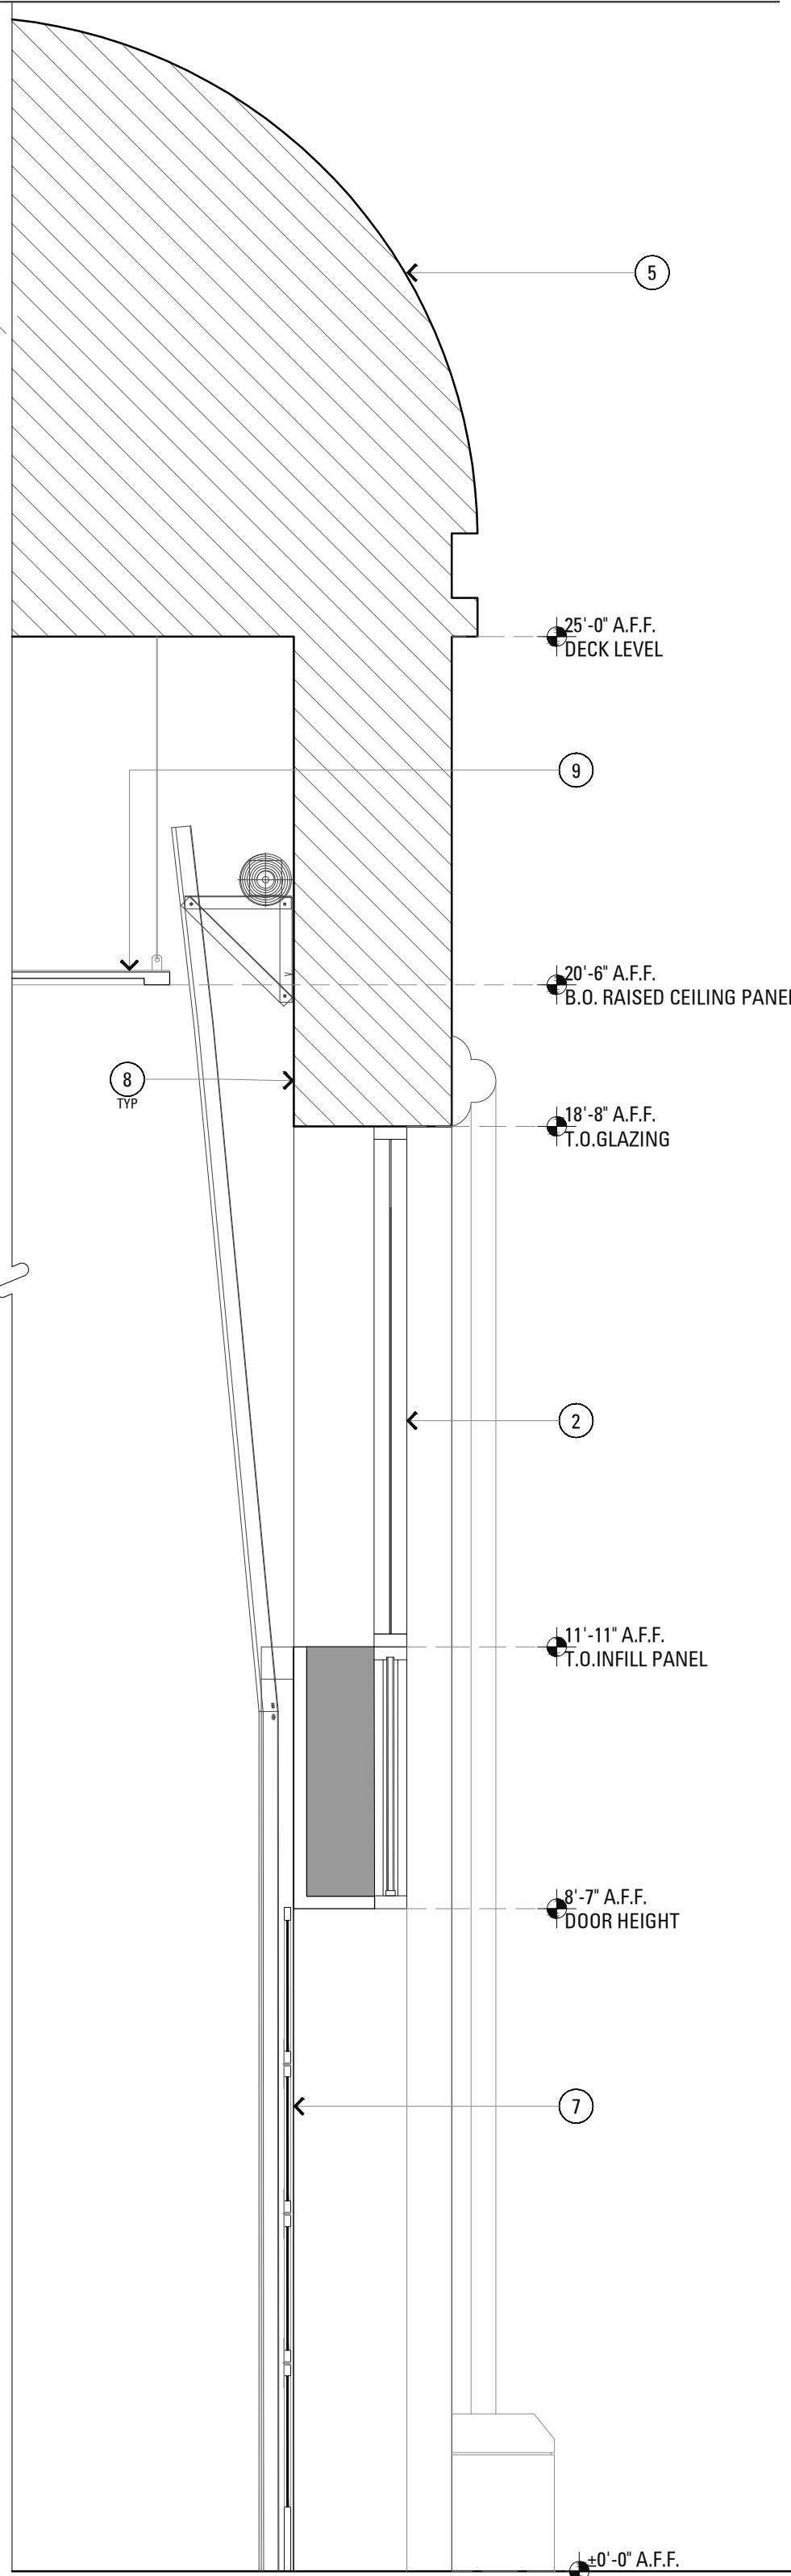

6 SECTION
1/2" = 1'-0"

ELEVATION KEY NOTES

- NEW ENTRY DOOR. REFER TO DOOR SCHEDULE FOR DETAILS.
- NEW STOREFRONT GLAZING.
- NEW SIGNAGE. UNDER SEPERATE PERMIT
- ILLUMINATED LOGO FIXED ON THE WALL SURFACE. UNDER SEPARATE PERMIT
- EXISTING METAL CORNICE/ ROOFING TO REMAIN
- NEW METAL FRAMING. REFER TO STRUCTURAL DRAWINGS FOR DETAILS
- NEW RAYNOR GARAGE DOOR. SEE DETAIL A ON SHEET A08.03
- EXISTING G.W.B. SOFFIT & FRAMING. PATCH & REPAIR TO RECEIVE NEW FINISH.
- EXISTING CEILING TO BE RAISED ABOVE THE SPRING-POINT OF THE ARCH AND PAINTED P-4
- 3' WIDE ADA COMPLAINT PASS DOOR
- BUILT-IN COUNTER ON LOW WALL
- NEW FLEX TRIM ON INNER AND OUTER CORNER OF EXISTING ARCH. SEE DETAIL E ON SHEET A08.03

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PROJECT:

PROJECT#: GA21-MLT004
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ARB SET

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CHECKED BY: KCR


SHEET TITLE

STOREFRONT
DETAILS

SHEET NUMBER

A08.02


GARAGE DOOR DETAILS

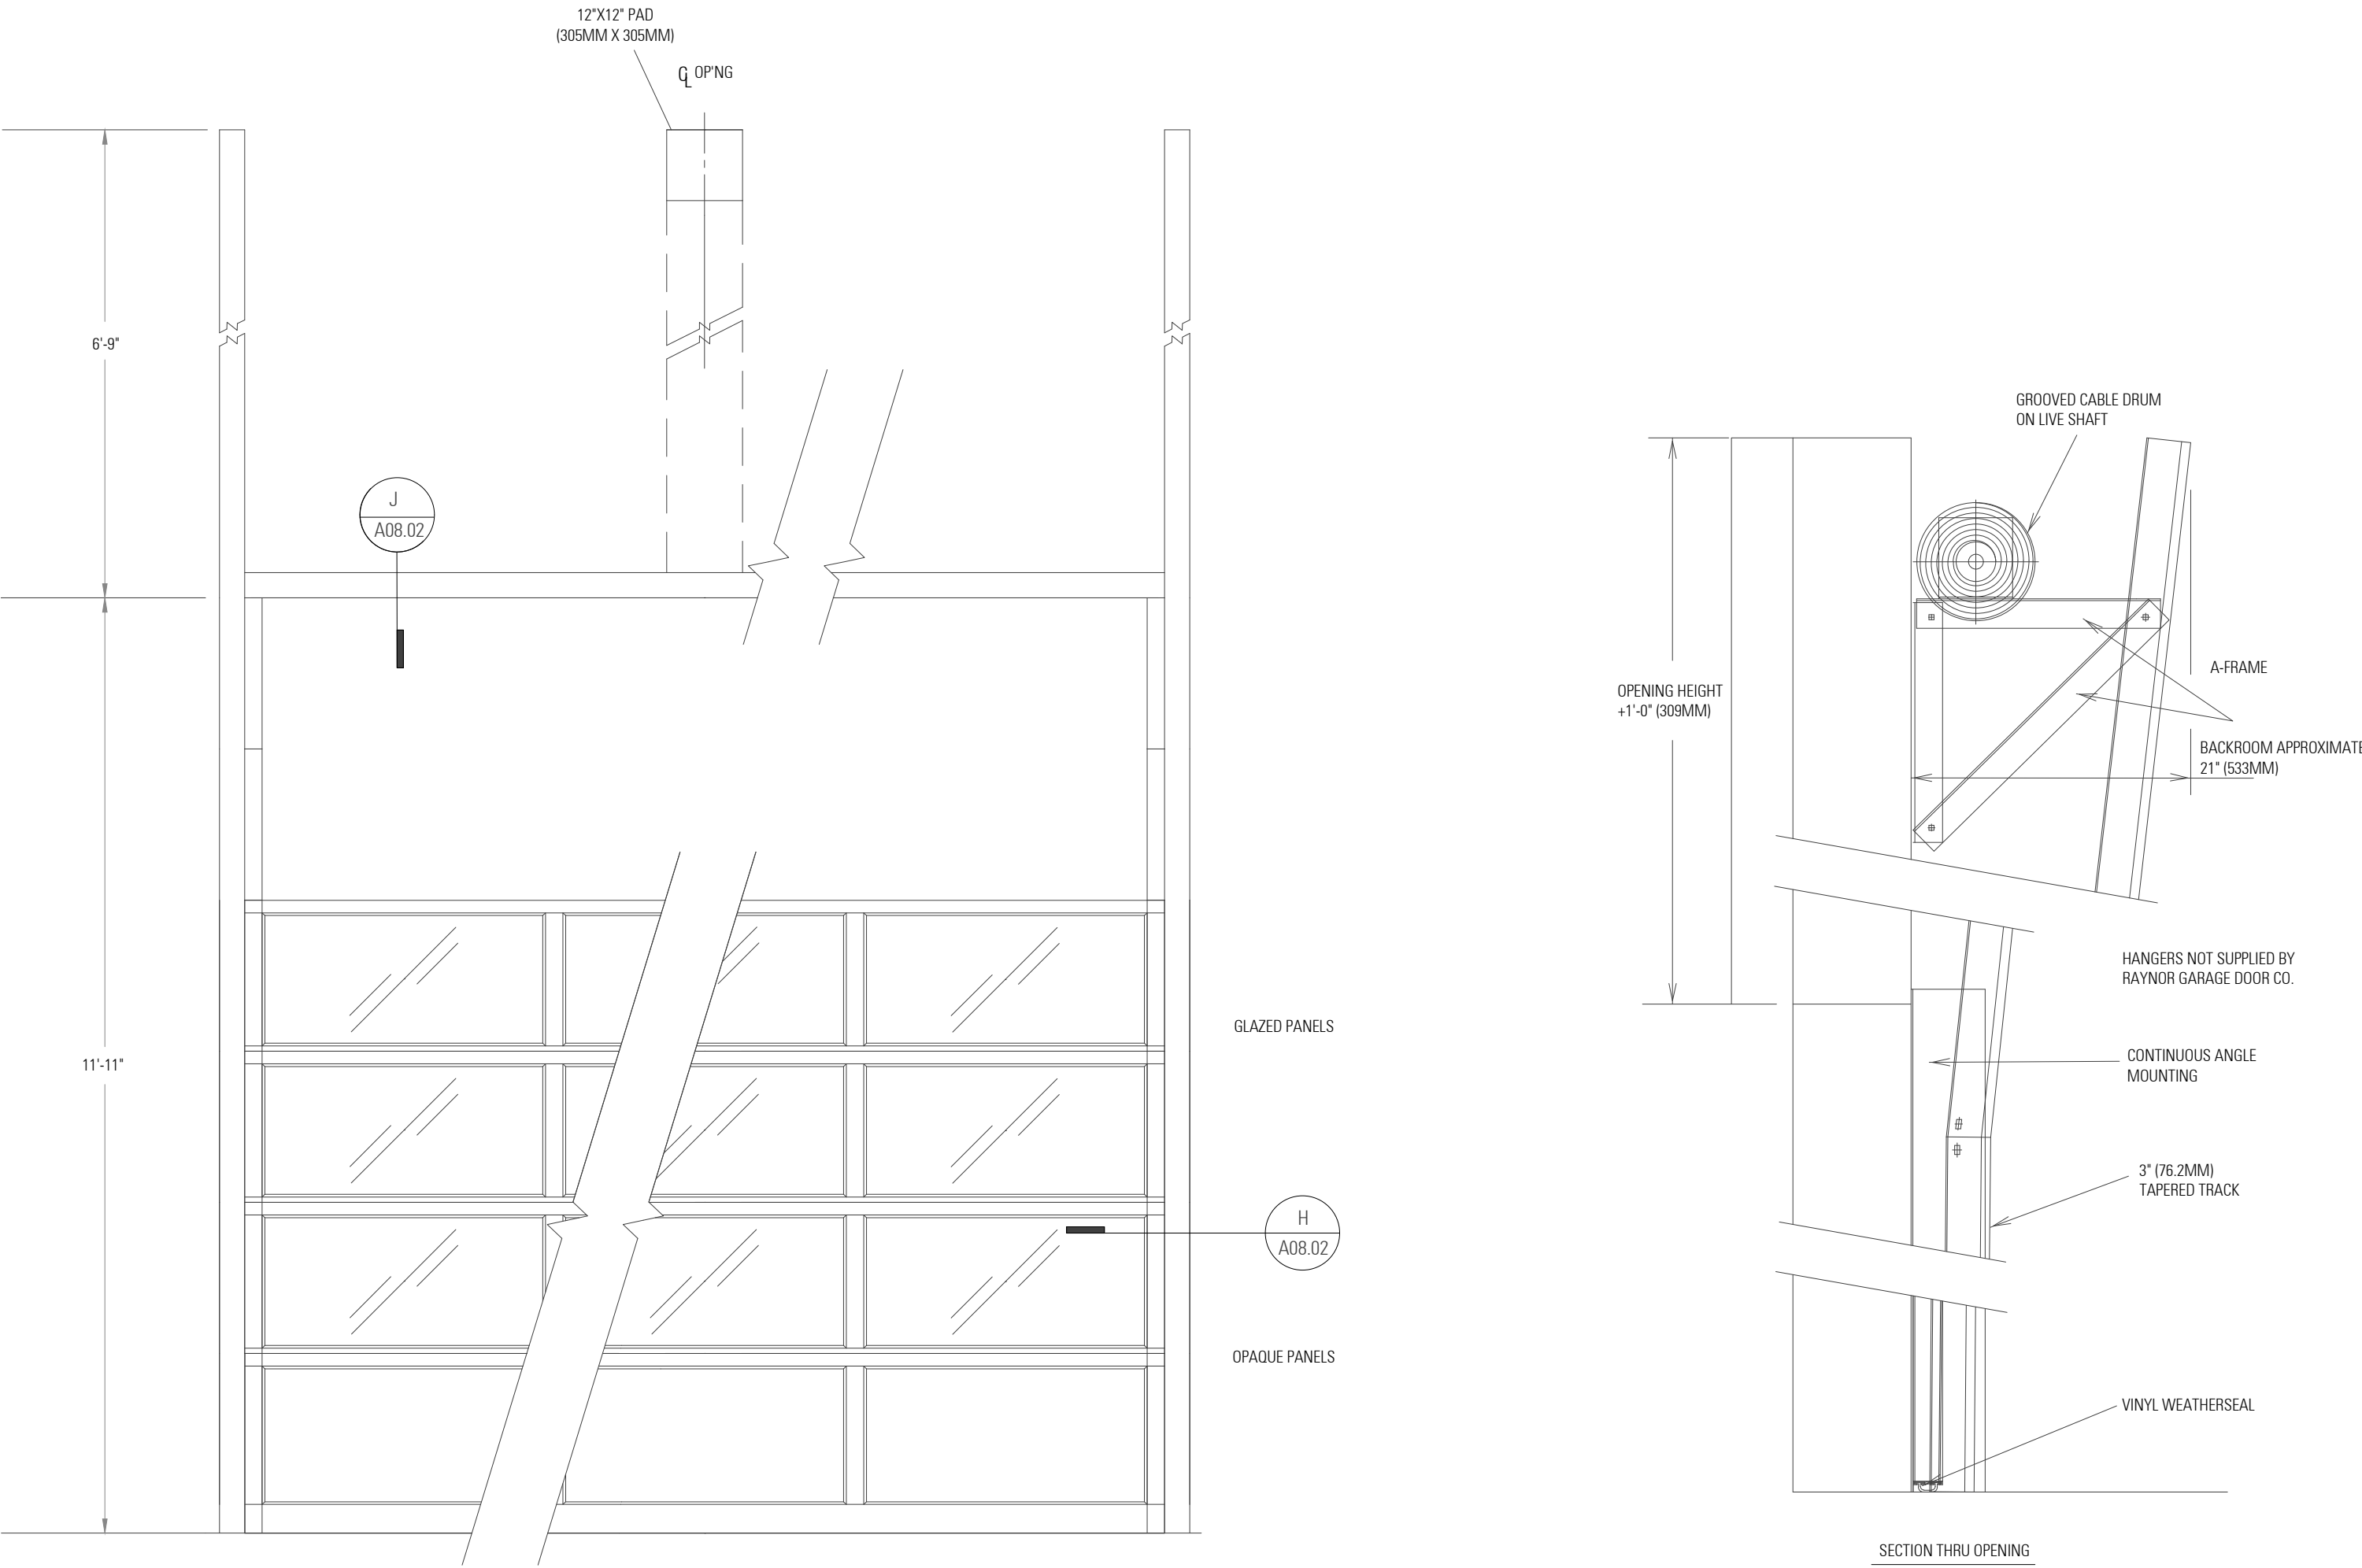

A GARAGE DOOR ELEVATION
1/2" = 1'-0"

B GARAGE DOOR SECTION
1/2" = 1'-0"

DETAILS

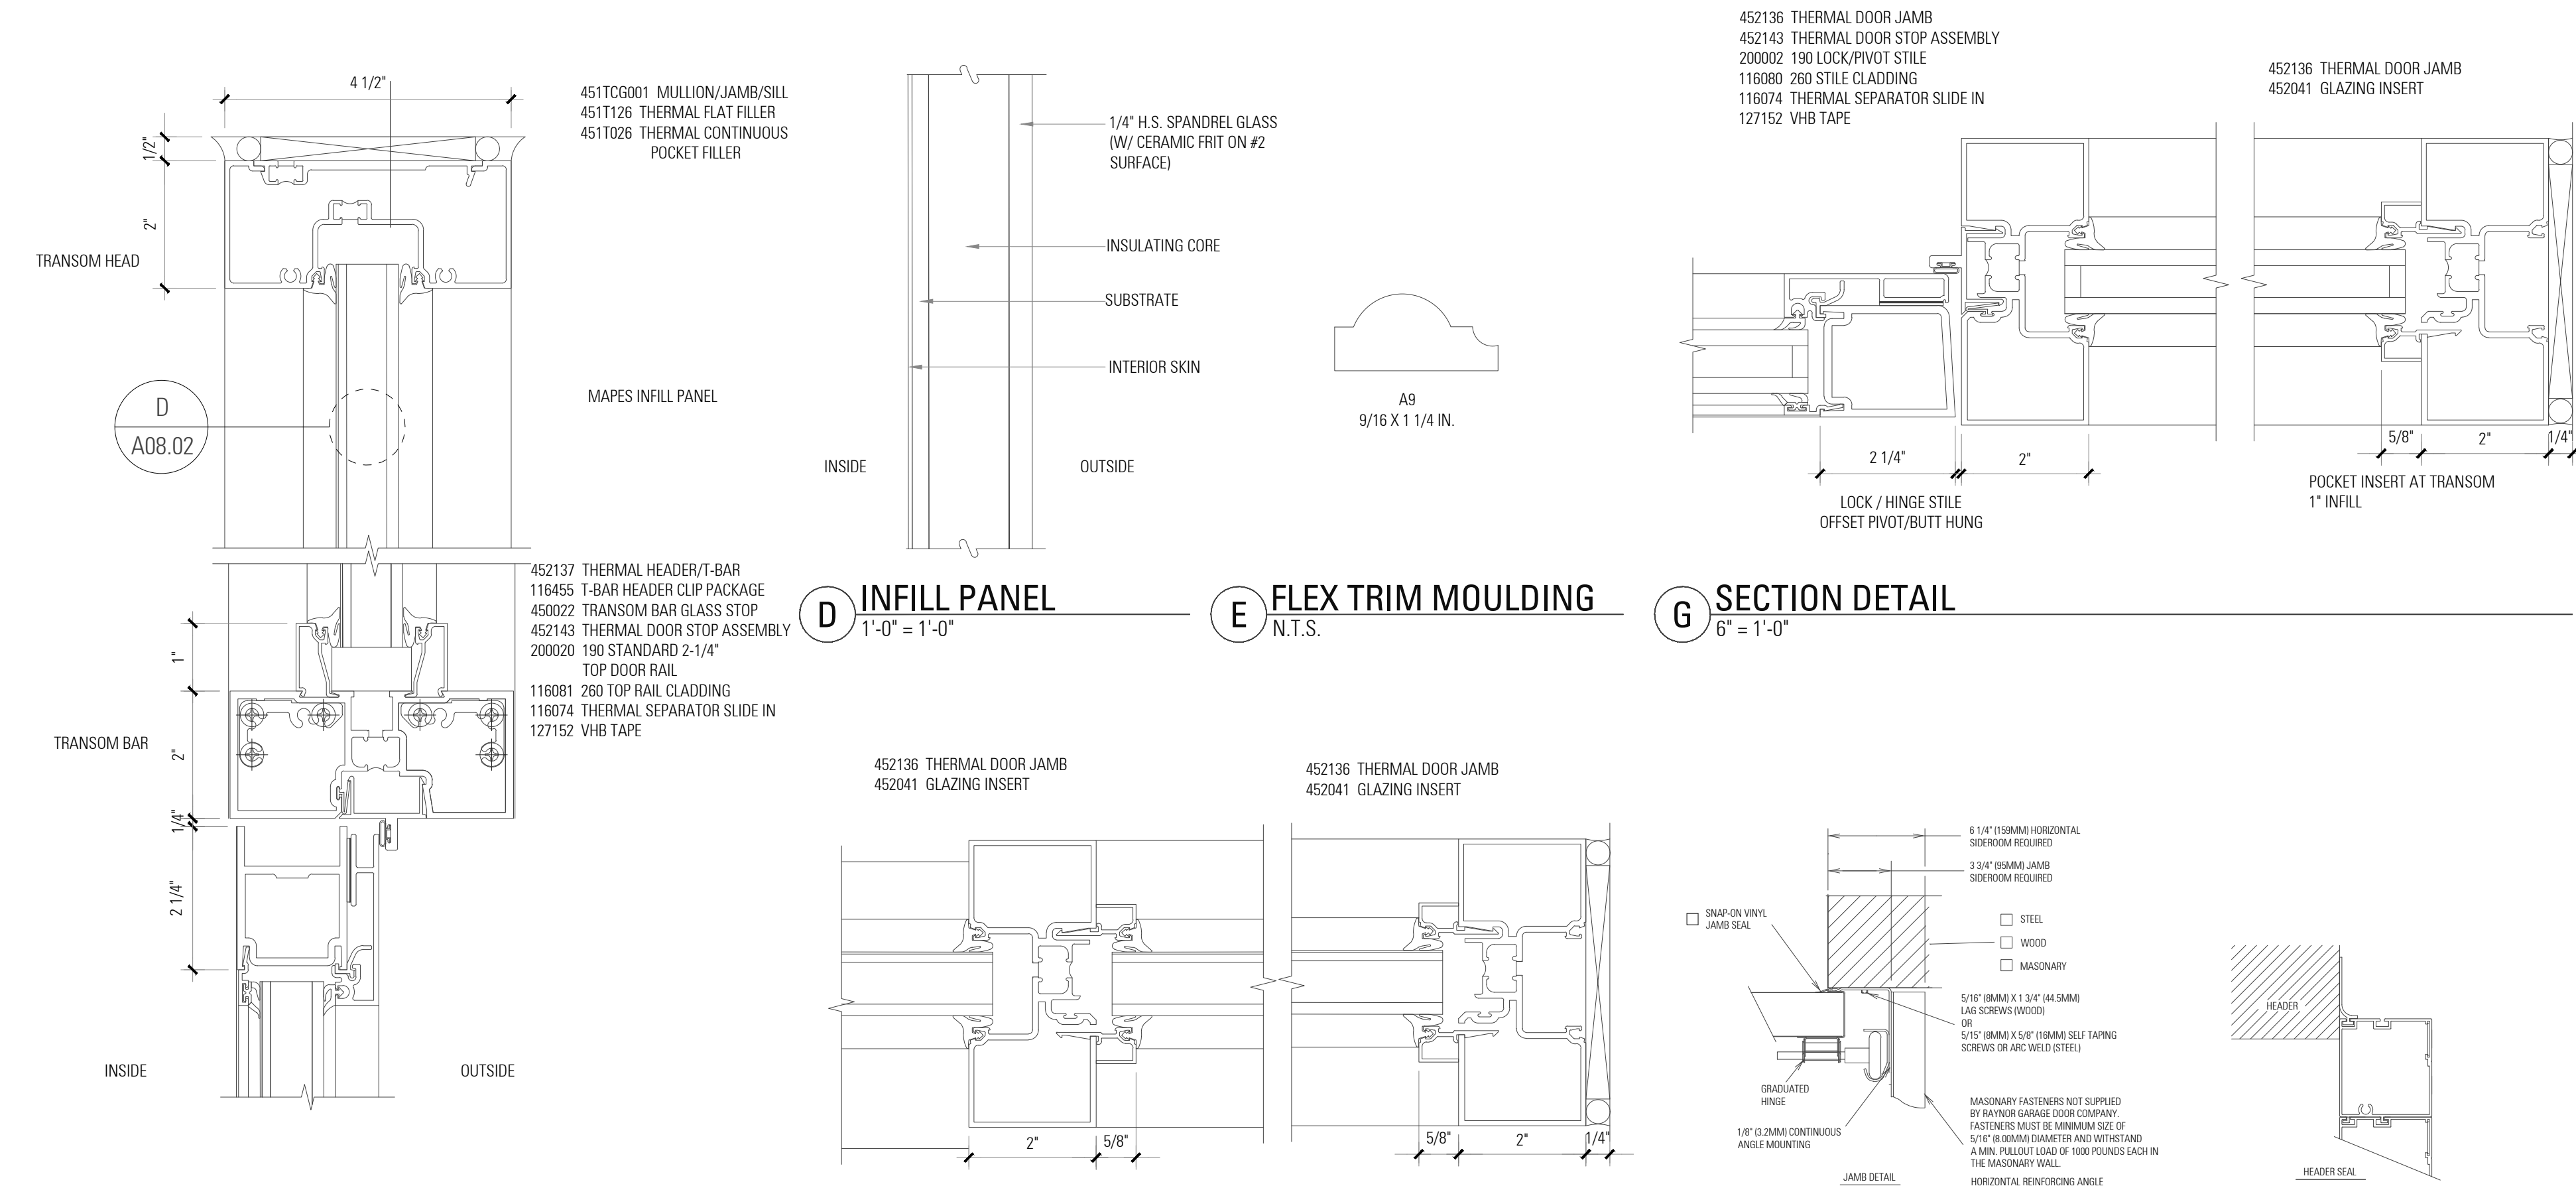

C VERTICAL SECTION- INFILL PANEL ABOVE DOOR
6" = 1'-0"

F HORIZONTAL SECTION- INFILL PANEL ABOVE DOOR
6" = 1'-0"

H JAMB
1/4" = 1'-0"

J HEAD
1/4" = 1'-0"

DOOR SCHEDULE

NO.	LOCATION	TYPE	HEIGHT	WIDTH	THK	MATERIAL	FINISH	HW SET#	FIRE RATING	REMARKS
D1	MAIN ENTRY	A	8'-7"	6'-0"	0'-1 3/4"	ALUM. & GLASS	P-3	01	60 MIN	CRL-US ALUMINUM - OFFICE PARTITION SERIES 250 NARROW W/ 10" BOTTOM RAIL
D2	GARAGE DOOR	B	8'-7"	13'-6"	0'-1 3/4"	ALUM. & GLASS	P-3	02	120 MIN	AMARR/ENTREMATIC BY THE COOKSON COMPANY - HEAVY DUTY ALUMINUM NON-INSULATED FULL VIEW-MODEL: 3552 - STANDARD TRACK LIFT
D2	GARAGE DOOR	B	8'-7"	13'-6"	0'-2 3/4"	ALUM. & GLASS	P-3	02	120 MIN	AMARR/ENTREMATIC BY THE COOKSON COMPANY - HEAVY DUTY ALUMINUM NON-INSULATED FULL VIEW-MODEL: 3552 - STANDARD TRACK LIFT. PROVISION FOR SINGLE PANEL HINGE DOOR WHEN CLOSED.

DOOR HARDWARE SCHEDULE

- ALL HARDWARE TO BE ADA COMPLIANT
- SET 01 ENTRY**
- 3 EA BUTT HINGE
 - 1 EA ENTRANCE LOCKSET
 - 1 EA CRL BLACK JACKSON 10 SERIES NONHANDED CONCEALED VERTICAL ROD EXIT PANIC DEVICE (OR OWNER APPROVED PULL)
 - 1 EA DOOR PULL MATTE BLACK 24" EXTRA LENGTH LADDER STYLE BACK TO BACK PULL (OR OWNER APPROVED ALTERNATE)
 - 1 EA CLOSER
 - 1 EA OVERHEAD STOP
- SET 02 ALUMINUM GARAGE DOOR**
- HINGES: HEAVY DUTY GALVANIZED STEEL HINGES. BALL-BEARING ROLLERS WITH HARDENED STEEL RACES.
 - ENTRANCE LOCKSET: GALVANIZED SINGLE UNIT LOCKSET OR AS PER MANUFACTURER'S PROVISION
 - WEATHERING: FLEXIBLE BULB TYPE STRIP AT BOTTOM SECTION, FLEXIBLE JAMB SEALS OR AS PER MANUFACTURER'S PROVISION
 - TRACK: PROVIDE TRACKS AS RECOMMENDED BY MANUFACTURER TO SUIT LOADING REQUIRED AND CLEARANCES AVAILABLE.
 - ELECTRIC MOTOR OPERATION: PROVIDE UL LISTED ELECTRIC POWER OPERATOR, SIZE AND TYPE AS RECOMMENDED BY THE MANUFACTURER TO MOVE THE DOOR IN EITHER DIRECTION.
 - CONTROL: PUSH BUTTON AND KEY OPERATED CONTROL STATIONS WITH OPEN AND CLOSE AND STOP BUTTONS.

DOOR NOTES

- ALL EXTERIOR ALUMINUM DOOR FRAMES TO BE PROVIDED AS PART OF THE STOREFRONT SYSTEM. PROVIDE DOOR MANUFACTURER'S STANDARD REINFORCING AT VERTICAL/HORIZONTAL MEMBERS TO MEET CODE REQUIRED WIND LOADS.
- CONTRACTOR SHALL FIELD VERIFY ALL CONDITIONS PRIOR TO BEGINNING DEMOLITION AND REPORT ANY DISCREPANCIES WITH THE DRAWINGS AND/OR SPECIFICATIONS TO THE ARCHITECT. CONTRACTOR SHALL SUBMIT SHOP DRAWINGS, PRODUCT DATA AND SAMPLES TO CLEARLY ILLUSTRATE APPLICABLE PORTIONS OF THE WORK.
- ALL DOOR HARDWARE SHALL BE INSTALLED TO COMPLY WITH ADA AND LOCAL REQUIREMENTS. MAX. DOOR OPENING FORCES SHALL COMPLY WITH ADA AND FBC 1010.1.3
- FOLLOW MANUFACTURER'S SPECIFICATIONS/ INSTALLATION REQUIREMENTS FOR ALL FIRE RATED AND FIRERESISTIVE GLAZING ASSEMBLIES
- THE BOTTOM 10 INCHES OF ALL DOORS SHALL HAVE A SMOOTH AND UNINTERRUPTED SURFACE.
- THRESHOLDS AT DOORWAYS SHALL NOT EXCEED 1/2 INCH ABOVE THE FINISHED FLOOR OR LANDINGS. RAISED THRESHOLDS AND LEVEL CHANGES GREATER THAN 1/4 INCH AT DOORWAYS SHALL BE BEVELED WITH A SLOPE NOT GREATER THAN ONE UNIT VERTICAL IN TWO UNITS HORIZONTAL.
- ADA COMPLIANT TACTILE EXIT SIGNAGE TO BE PROVIDED AT ALL EXIT DOORS.
- COORDINATE KEYING WITH THE OWNER 'S DESIGNATED REPRESENTATIVE.
- SAFETY GLAZING: DOORS AND SIDELITES: ALL GLAZING IN FIXED AND OPERABLE PANELS OF SWINGING, SLIDING, AND BIFOLD DOORS SHALL BE TEMPERED. GLAZING ADJACENT TO DOORS SHALL BE TEMPERED IF THE BOTTOM EDGE OF THE GLAZING IS LESS THAN 60 INCHES ABOVE THE WALKING SURFACE: WITHIN 24 INCHES OF EITHER SIDE OF THE DOOR IF GLAZING IS IN THE SAME PLANE AS THE DOOR, OR IF GLAZING IS IN A WALL PERPENDICULAR TO THE DOOR WITHIN 24 INCHES ON THE HINGE SIDE OF AN INSWING DOOR.

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PALO ALTO, CALIFORNIA 94304

PROJECT:

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DOCUMENT DATE: 07-05-22
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SHEET TITLE

**STOREFRONT
DETAILS**

SHEET NUMBER

A08.03

The Melt, Stanford Shopping Center – Palo Alto, CA

Shimstone Design Studio
LIGHTING DESIGN

LIGHTING FIXTURE SCHEDULE – PERMIT SET (NOT FOR CONSTRUCTION)

Issued: 04/05/22

Type	Location	Description	(Qty) Lamp	Manufacturer, & Series No	Input Watts	Remarks
XL1	Exterior Façade	Surface-mounted low voltage linear LED tape w/ extruded channel, outdoor rated.	Integral LED, 2700K, CRI 90+	Feelux, FTP15-27K-24V-C90 Extrusion: FTP-EXL	5.5 W/ft	<ul style="list-style-type: none"> Provide brackets and accessories as required for complete installation. Field cuttable. IP66 rating for Outdoor use. Remote power supply required. UL listed for Wet locations. 48"
XL2	Exterior Terrace	Exterior LED string lights	(15) G25 LED, 2700K	Rejuvenation, A4126 Steel Cable: A9915	375w	<ul style="list-style-type: none"> UL listed for Wet locations. Provide single lamp for downwards illumination only. Remote 12V transformer required. UL listed for Wet locations. Remote 12V transformer required.
XS1	Exterior Terrace	Brass low voltage wall sconce, downlight only	(1) LED MR16, 2700K	Volt Lighting, VHS-650-4-BBZ	Allow 60 W	
XS2	Exterior Terrace	Terrace Sconce Down Light	Integral LED, 2700K, CRI 90+	Hevi Lite, HL-340S-(finish)-8LED-FL-12V	8 W	

REJUVENATION



REJUVENATION

Steel Cable & Hooks for Commercial String Lights
Item A9915
<http://www.rejuvenation.com/a9915>

Specification	Detail
Item #	A9915
Width	60"
Working Load Limit	100 lbs.
Cable Thickness	1/16"
Price as shown : \$60.00	
Shipping and handling fees apply	

COMPONENTS

Mounting Brackets
_FTP-BRACKET1FTP Extrusion Line
_FTP-EXL (1200mm)Indoor Power Cable
_FTP-INPC (200mm)
with END CAPIndoor Direct Connector
_FTP-INCPCL15 G25 Clear LED Bulb String Lights
Item A4126
<http://www.rejuvenation.com/a4126>



Specification	Detail
Item #	A4126
Width	48 feet
Sockets	15
Maximum Wattage per Socket	25W MAX per socket
Spacing	sockets are 3 feet apart
Price as shown : \$250.00	
Shipping and handling fees apply	

Shimstone Design Studio
LIGHTING DESIGNThe Melt: Stanford Shopping Center
Palo Alto, CA

FEELUX

FLXible LED Tape Pro

* Finished view
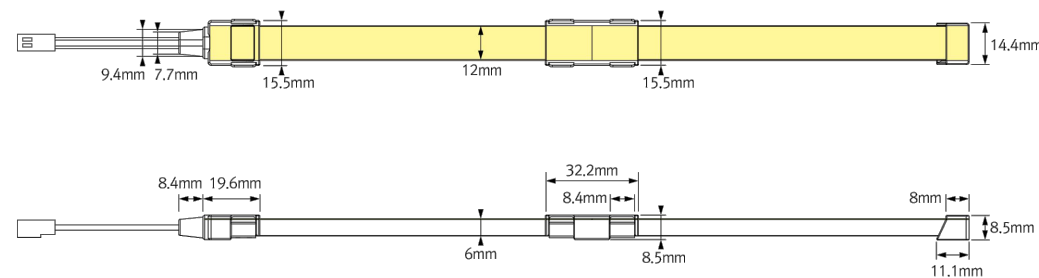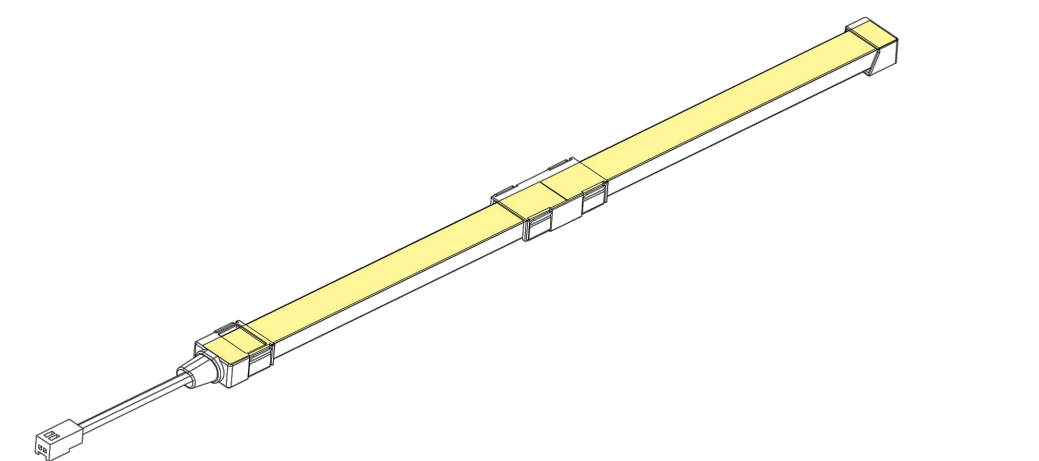
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5

SDS PROJECT #: 0609.0

MODEL #: REFER TO LIGHTING FIXTURE SCHEDULE FOR MODEL NUMBER AND DESCRIPTION

TYPE: XL1






Shimstone Design Studio LLC, 7400 1st Avenue, North Bergen, NJ 07047, Tel: 201.861.5390

Shimstone Design Studio
LIGHTING DESIGNThe Melt: Stanford Shopping Center
Palo Alto, CA

FEELUX


FLXible LED Tape Pro

I INSTALLATION – Extrusion

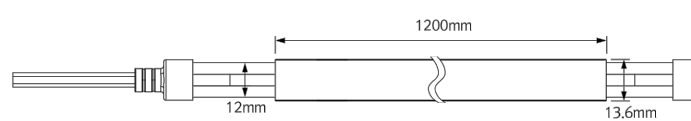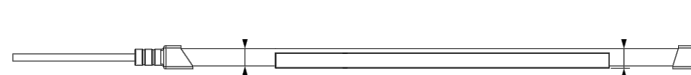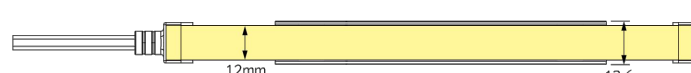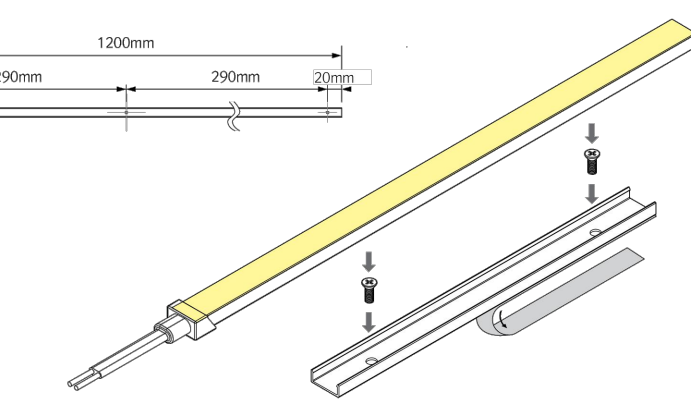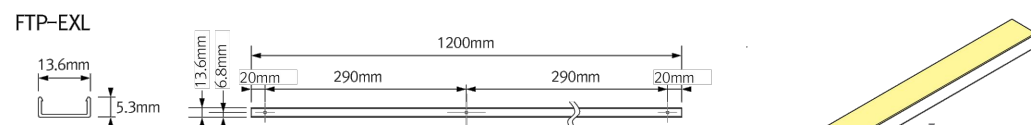

I INSTALLATION – Indoor Termination (IP20)

* Components
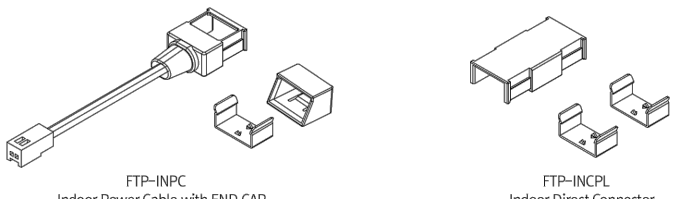
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5

SDS PROJECT #: 0609.0

MODEL #: REFER TO LIGHTING FIXTURE SCHEDULE FOR MODEL NUMBER AND DESCRIPTION

TYPE: XL1

Shimstone Design Studio LLC, 7400 1st Avenue, North Bergen, NJ 07047, Tel: 201.861.5390

Shimstone Design Studio
LIGHTING DESIGNThe Melt: Stanford Shopping Center
Palo Alto, CA

PRODUCT SPECIFICATIONS

VOLT®

VOLT® Low Voltage Landscape Lighting
VOLT® Ultra Premium Up/Down Sconce- VHS-650-4-BBZ

Product Description

The Ultra Premium Up/Down Sconce light is probably the finest up/down low voltage landscape lighting sconce on the market. It has many unique features, such as glass lenses that have etched edges, enabling the center of the glass to be flush 1mm above the top of the brass. This feature prevents any water from puddling or collecting on top. The body of the fixture is threaded and screws together tightly with an O-ring seal, making it completely water proof. These luminaires offset further from wall, so light does not get blocked by aggregate surfaces or header cap stones. Plus, the offset also allows for better photometrics/illumination than other sconce designs. These are very heavy at 3 lbs of solid cast brass, with a sturdy 1-piece arm and mounting. They are much larger than what you'd typically find with other brands (7" x 4 1/2"). The Ultra Premium Up/Down Sconce features a bronze finish, has a 16G SPT-2 tinned copper lead wire, beryllium copper sockets, heat shrink tubing over internal splice, UL braided sleeve protectors, and two sockets pre-greased with dielectric grease. Uses two MR16 lamps (sold separately). Comes with a lifetime replacement warranty.



Specifications

- Construction: Brass
- Finish: Bronze
- Lead Wire: 16AWG
- Lens: Clear Protective Glass
- Light Source (sold separately): MR16 (LED or Halogen)
- Operating Voltage: 12VAC
- Powered by: VOLT's Low Voltage Transformer

Warranty

Lifetime Warranty

Certifications



Features & Benefits

- Solid Brass
- Pre-aged finish: a natural patina that does not corrode
- Beryllium copper socket - more corrosion resistant than copper
- Pressure rubber gasket for a moisture tight design

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www.voltlighting.com

SDS PROJECT #: 0609.0

MODEL #: REFER TO LIGHTING FIXTURE SCHEDULE FOR MODEL NUMBER AND DESCRIPTION

TYPE: XS1

Shimstone Design Studio LLC, 7400 1st Avenue, North Bergen, NJ 07047, Tel: 201.861.5390

Shimstone Design Studio
LIGHTING DESIGNThe Melt: Stanford Shopping Center
Palo Alto, CA

FEELUX

FLXible LED Tape Pro

PRODUCT IMAGE



PRODUCT FEATURES

- Seamless Dot-Free Illumination
- Ultra Slim
- High Efficiency / High Output
- High CRI (91-93)
- Clear Photo LEDs
- Bend Direction Vertically
- Indoor/Outdoor Application (IP66)
- Field Cut Cable (33.3mm)
- Available in Standard Lengths of 5M reels
- Dimmable


PRODUCT SPECIFICATIONS

IP Rate	IP66 with Factory Termination (Customized Length Available)
Lamp Power	15W/m
Power Input	24V DC
Color Rendering	R9090
Operating Temperature Ranges	0-45°C
Burn Angle	110°
Material	Silicon
Available Color	2700K, 3000K, 3500K, 4000K

SPECIFICATIONS TABLE


Model Number	Color	Lamp Power	Luminous Flux (lm/ft)	Lumen/W
FTP15-27K-24V-C90	2700K	4.2W/ft	415lm	98.24lm/W
FTP15-30K-24V-C90	3000K	4.3W/ft	440lm	102.07lm/W
FTP15-35K-24V-C90	3500K	4.3W/ft	465lm	108.64lm/W
FTP15-40K-24V-C90	4000K	4.4W/ft	478lm	108.77lm/W

PHYSICAL SPECIFICATIONS

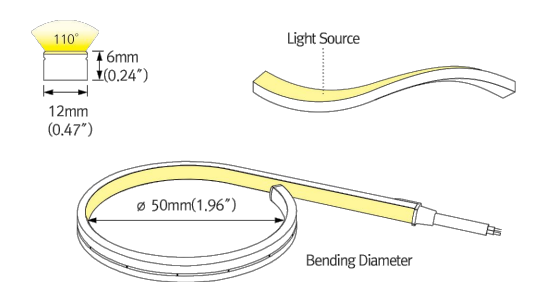

PHYSICAL SPECIFICATIONS


Model Number	A Length	B Core/Glass Width	C Pin Width	D Thickness
FTP15-30K-24V-C90	1.012mm (0.04")	33.3mm (1.31")	12mm (0.47")	6mm (0.24")
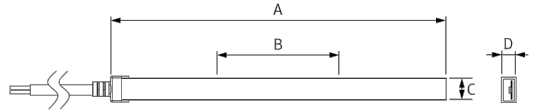
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231-48, Gwanggeon-ro, Gwanggeon-myeon, Yangju, Gyeonggi-do, Korea | T: +82-70-7780-8200 | F: +82-70-7780-8209 | info@feelux.comShimstone Design Studio
LIGHTING DESIGNThe Melt: Stanford Shopping Center
Palo Alto, CA


FEELUX

FLXible LED Tape Pro

DIMENSIONS

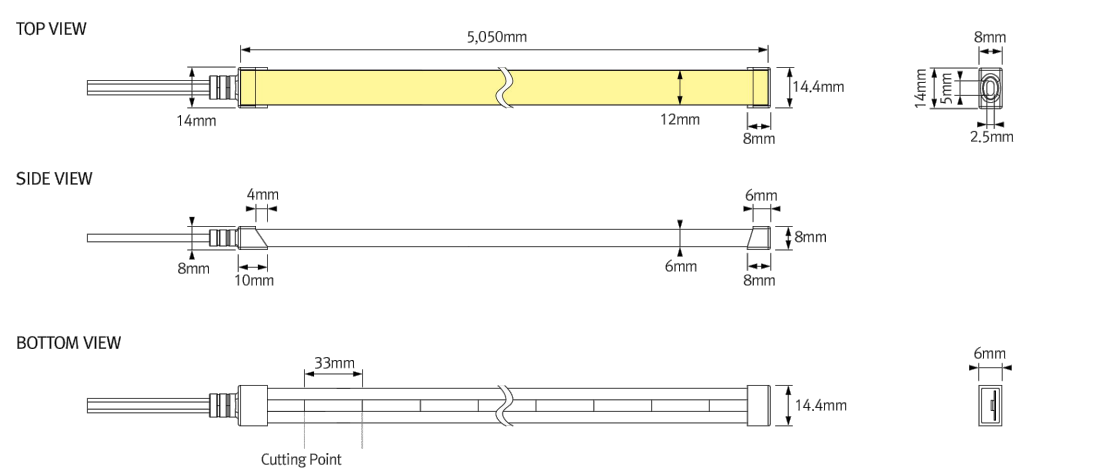

INSTALLATION – Bracket
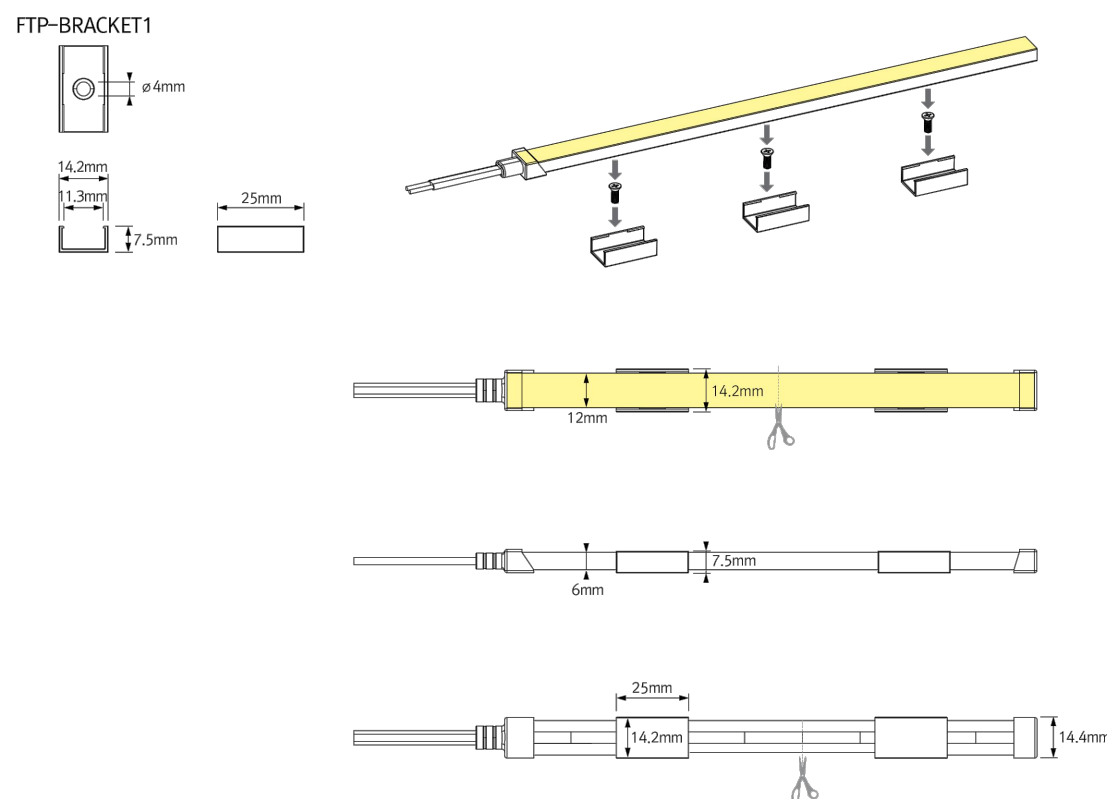
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2

SDS PROJECT #: 0609.0

MODEL #: REFER TO LIGHTING FIXTURE SCHEDULE FOR MODEL NUMBER AND DESCRIPTION

TYPE: XL1


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Shimstone Design Studio
LIGHTING DESIGNThe Melt: Stanford Shopping Center
Palo Alto, CA


FEELUX

FLXible LED Tape Pro

* Expanded View

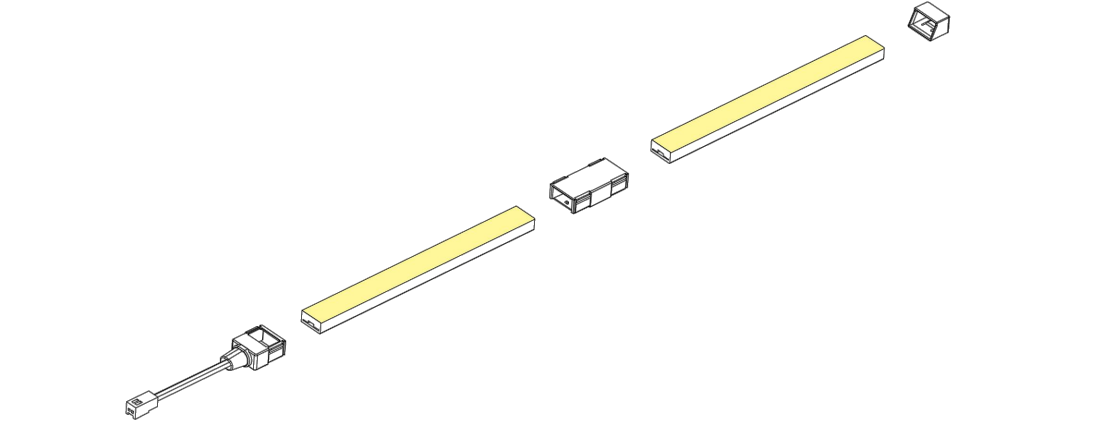

* Installation Method
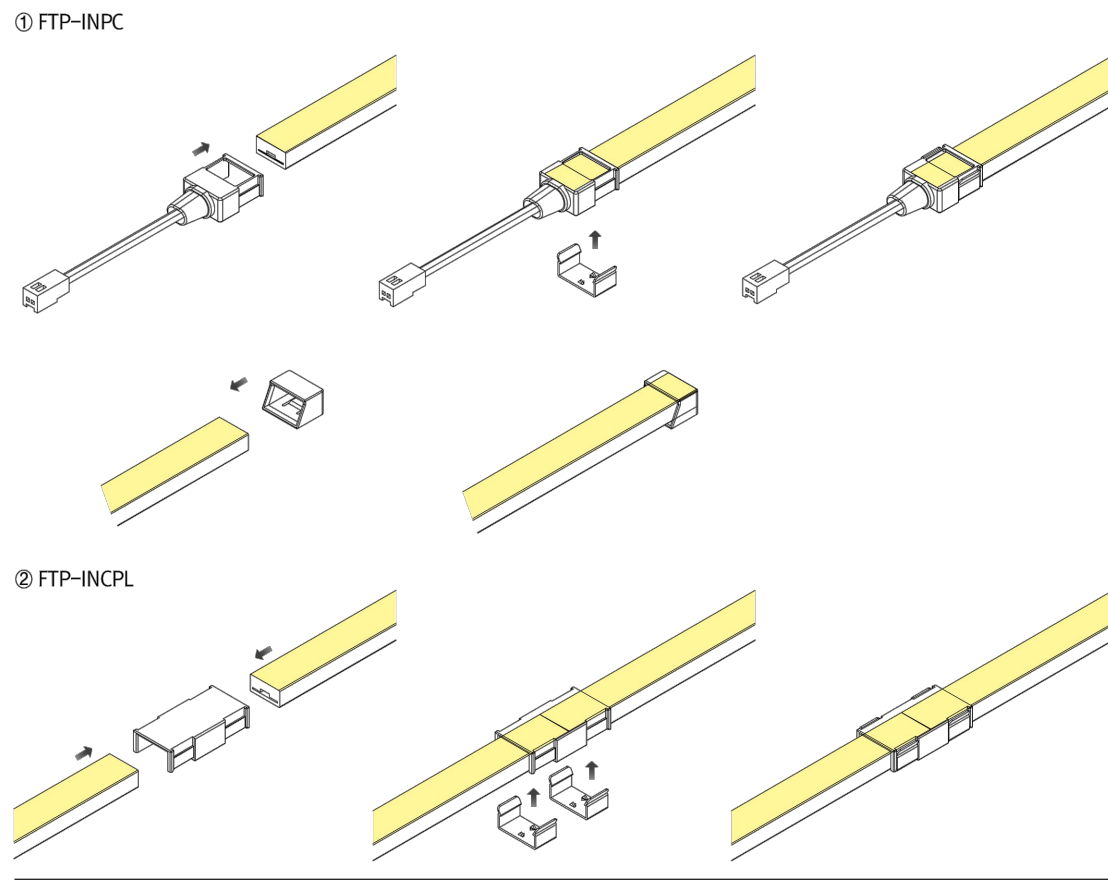
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4

SDS PROJECT #: 0609.0

MODEL #: REFER TO LIGHTING FIXTURE SCHEDULE FOR MODEL NUMBER AND DESCRIPTION

TYPE: XL1

Shimstone Design Studio LLC, 7400 1st Avenue, North Bergen, NJ 07047, Tel: 201.861.5390

Shimstone Design Studio
LIGHTING DESIGNThe Melt: Stanford Shopping Center
Palo Alto, CA

SPECIFICATIONS

DESCRIPTION:
Wall mount square MR16 accent fixture.
Suitable for wet/damp/typical location installations.

MATERIAL:
Standard overall material is 6061 aluminum.
HL-340S - Machined Aluminum (Standard)

FINISH:
AA - Anodized Satin Aluminum
AP - Powder Coat Aluminum
BK - Powder Coat Black
BZ - Powder Coat Bronze
WT - Powder Coat White

HALOGEN LAMPING OPTION:
Lamp Type - 12V Halogen MR16 lamp, bi-pin GX5.3 base, 50W max, not included (standard).

LED OPTIONS
Integral high output LED, warm white 85 CRI (3000K CCT) standard, others available.
3LED - 3W LED - 180 lumens
6LED - 6W LED - 360 lumens
12LED - 12W LED - 720 lumens

OPTICS
3LED and 6LED:
SP - Spot, 12°
MF - Narrow Flood, 24°
FL - Flood, 36°
12LED:
SP - Spot 14°
MF - Narrow Flood, 25°
MF - Medium Flood, 30°
FL - Flood, 40°

VOLTAGE:
12 - 12 VAC output transformer required, not included.

MOUNTING:
Fixture is equipped with a 4.75" mounting plate and G1 mounting screws.




OPTIONS:
Lenses/Louvers/Color Filters:
LA-1 - Horizontal Louver (Black)
LA-2 - Prismatic lens
LA-3 - Linear spread lens
LA-4 - Soft focus lens (diffused)
LA-5 - Moonlight lens
LA-6 - Blue lens
See future accessories for more information.

SAMPLE ORDER SPECIFICATION:
HL-340S-AA-12-LA-6

RATING:
Wet/damp/typical location.



MADE IN THE USA

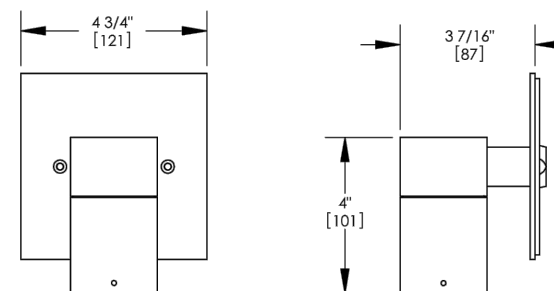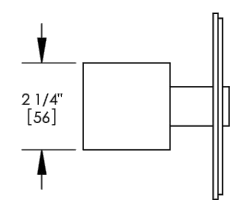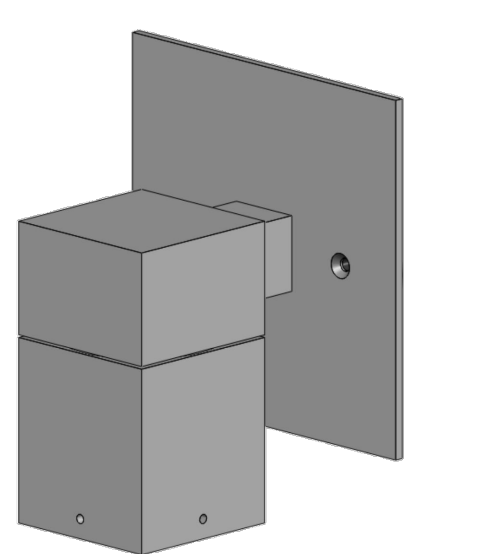

ORDER SPECIFICATION:

PROJECT:

APPROVED:

NOTE:

TYPE:

HEVI LITE, INC.
9714 Varrel Ave, Chatsworth, CA 91311
Tel., (818) 341-8091 • Fax (818) 998-1988
Web Site <http://www.hevilight.com>

CATALOG NUMBER:

HL-340S

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SDS PROJECT #: 0609.0

MODEL #: REFER TO LIGHTING FIXTURE SCHEDULE FOR MODEL NUMBER AND DESCRIPTION

TYPE: XS2

Shimstone Design Studio LLC, 7400 1st Avenue, North Bergen, NJ 07047, Tel: 201.861.5390

ARCHITECT:

KATHRYN CULLEY-RAPATA, AIA
CA LICENSE NO. C-31564
CONTACT: KATE CULLEY-RAPATA
PH: 510-459-5138

STAMP & SEAL:

PROJECT CONSULTANT:



globeateliê
5655 SILVER CREEK VALLEY ROAD #260,
SAN JOSE CA 95138

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CLIENT:

theMELT

THE MELT, STANFORD

180 EL CAMINO REAL, SUITE 705A, BLDG. E,
PALO ALTO, CALIFORNIA 94304

PROJECT:

PROJECT#: GA21-MLT004

DOCUMENT DATE: 07-05-22

DOCUMENT PHASE:

ARB SET

DATE

07-05-22

ISSUE

ARB SET

DRAWN BY:

NR

CHECKED BY:



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SHEET TITLE

LIGHTING CUT
SHEETS


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X.02




DETAIL B
SCALE 3/8

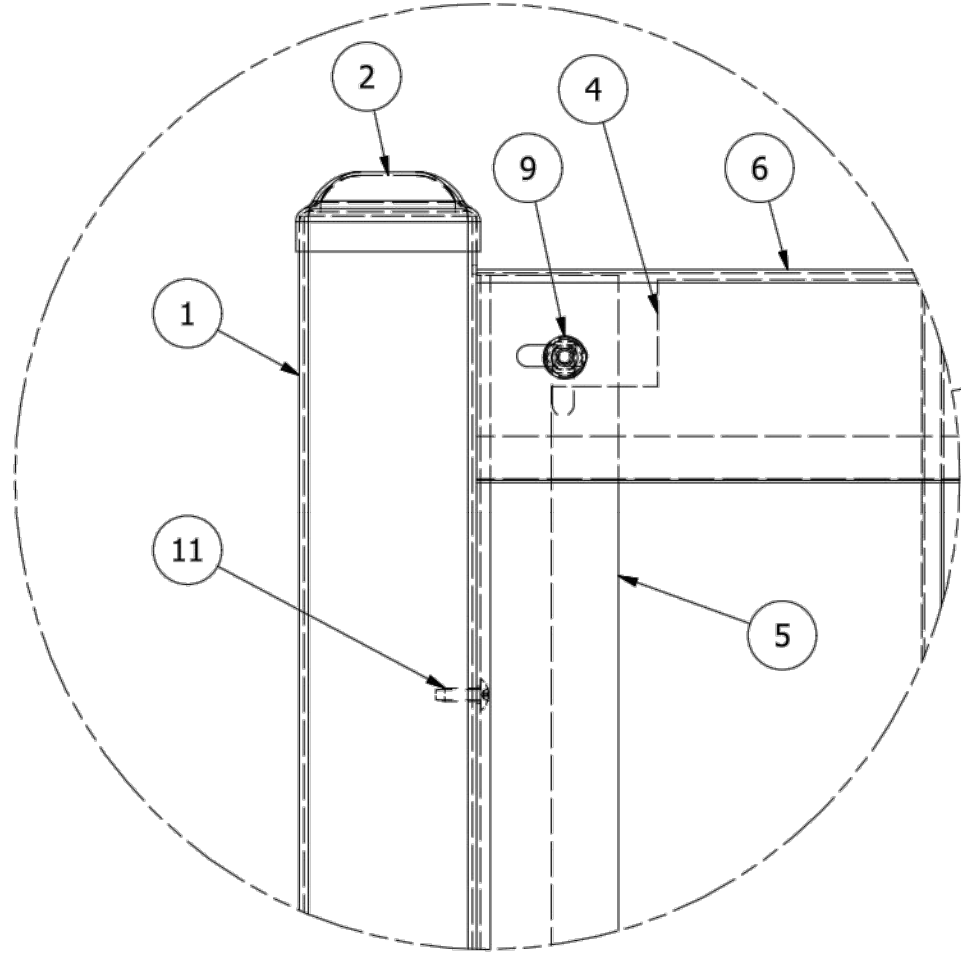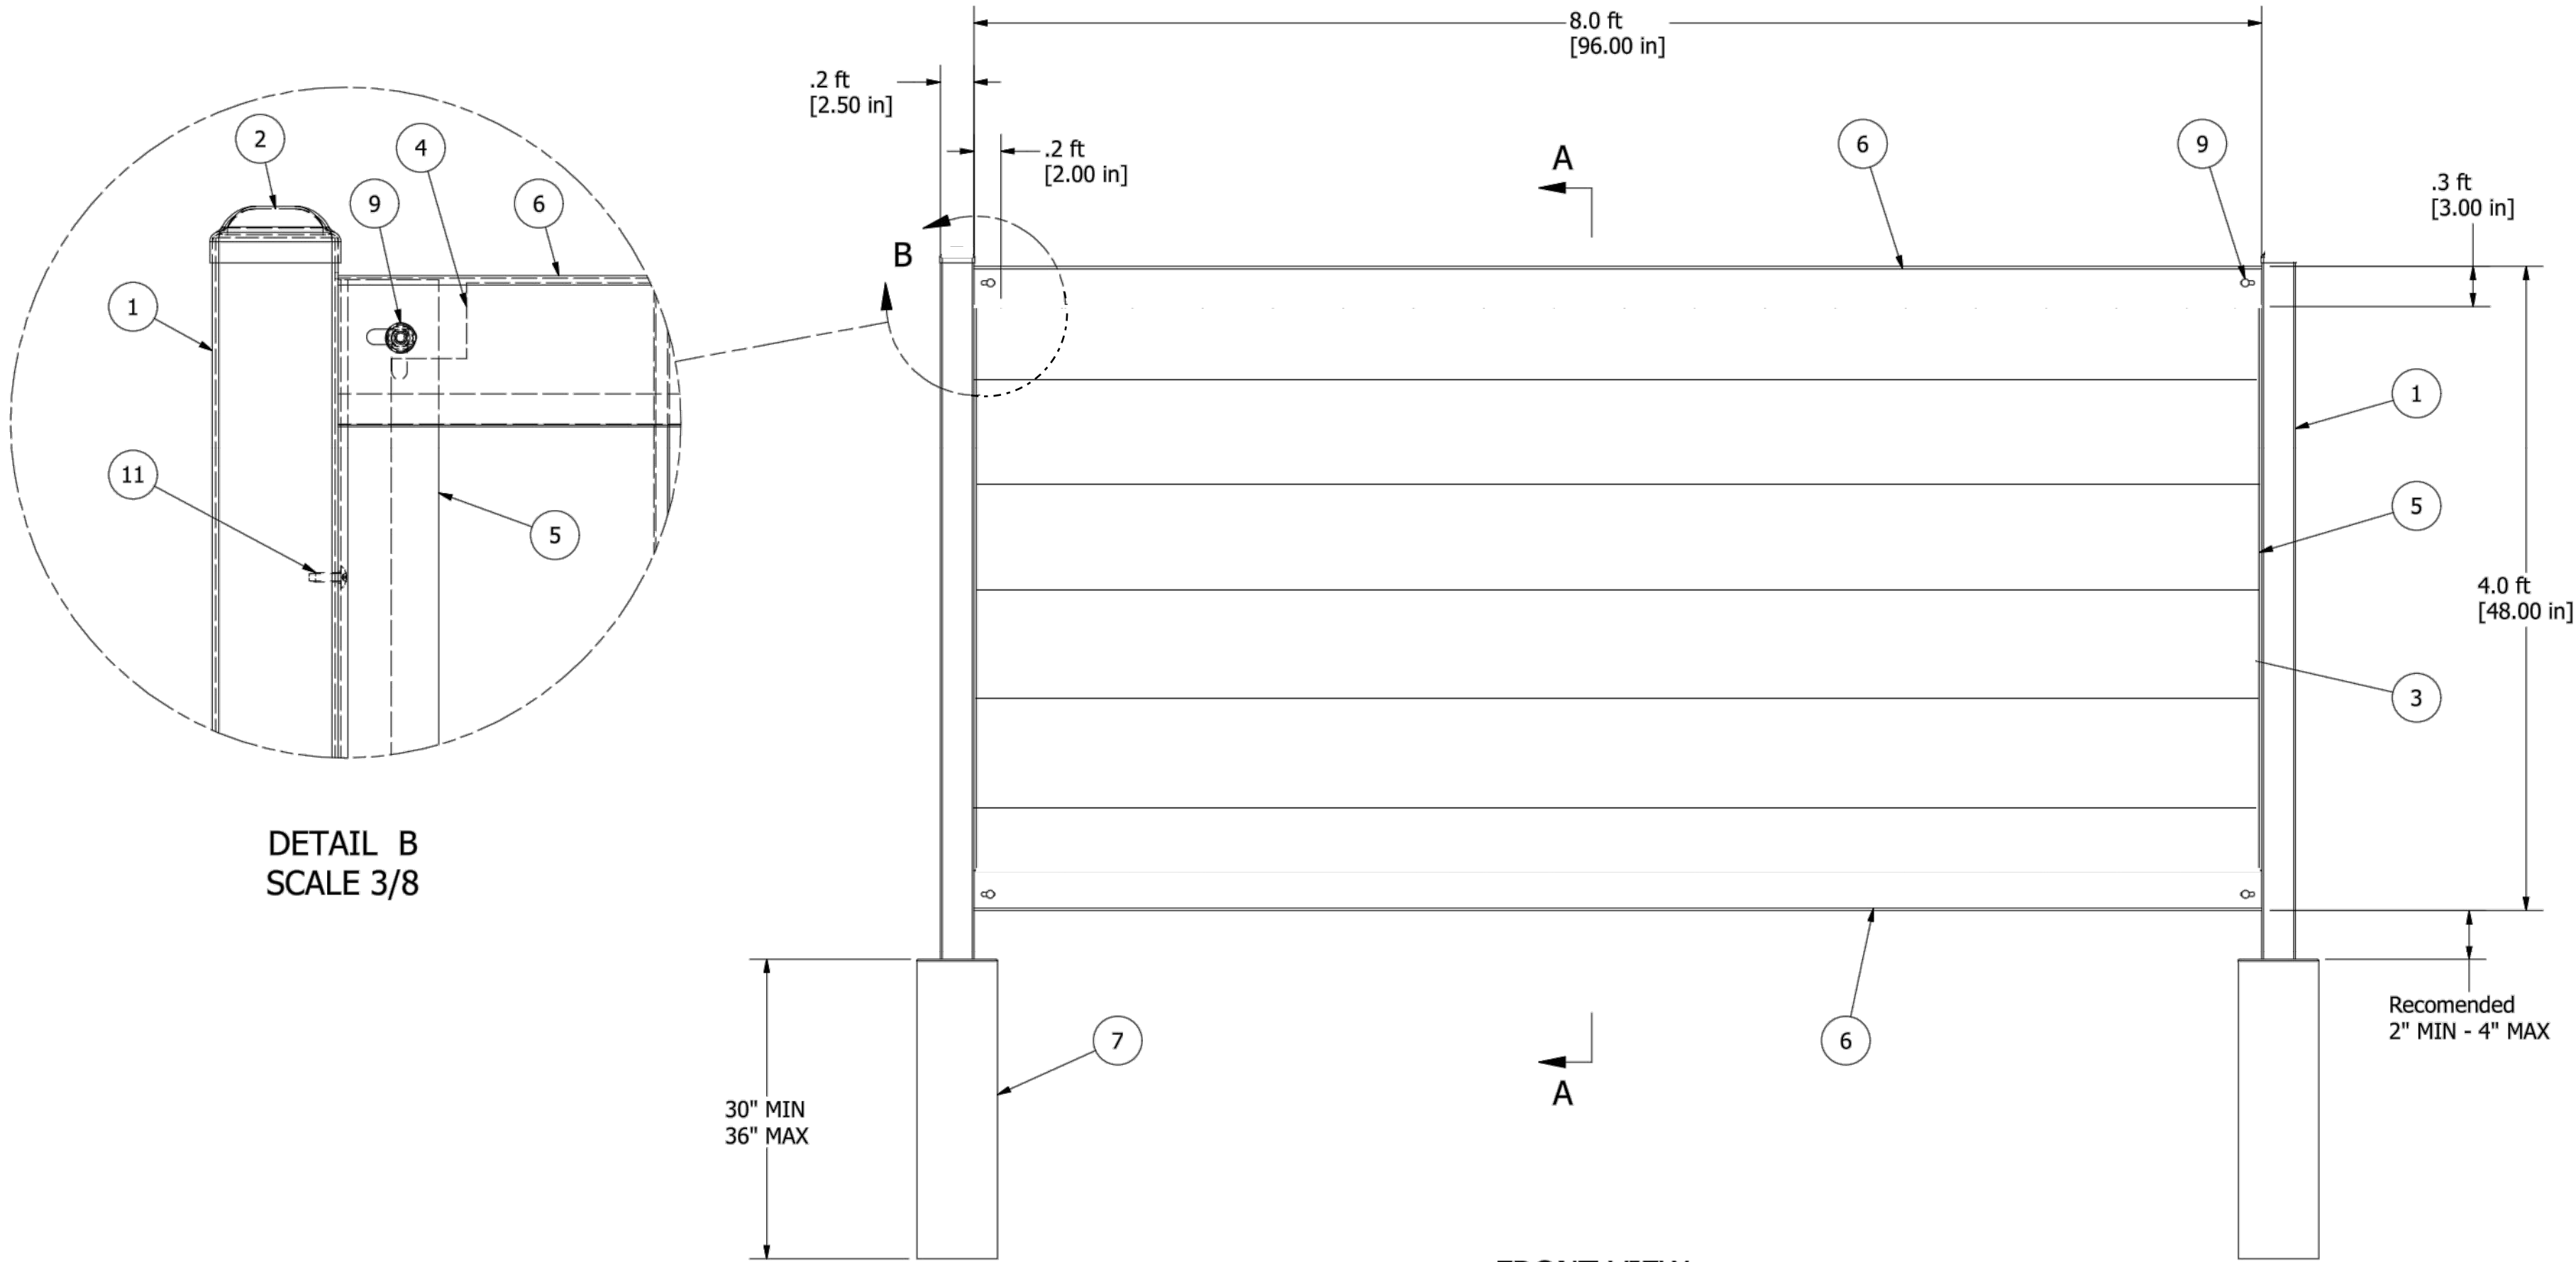
FRONT VIEW
SCALE 1:10

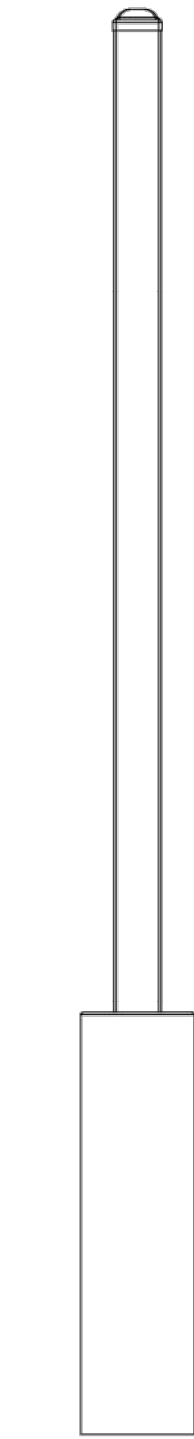

RIGHT VIEW
SCALE 1:10

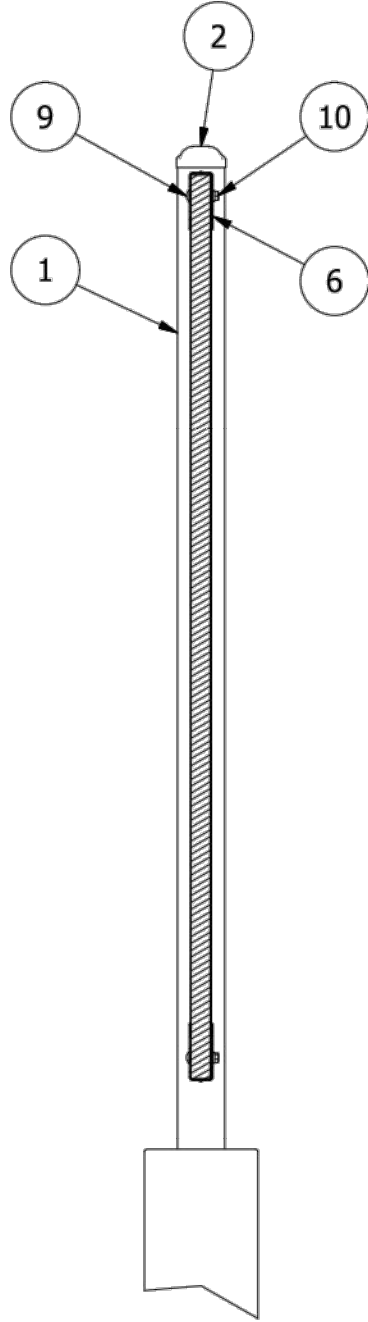

SECTION A-A
SCALE 1:10

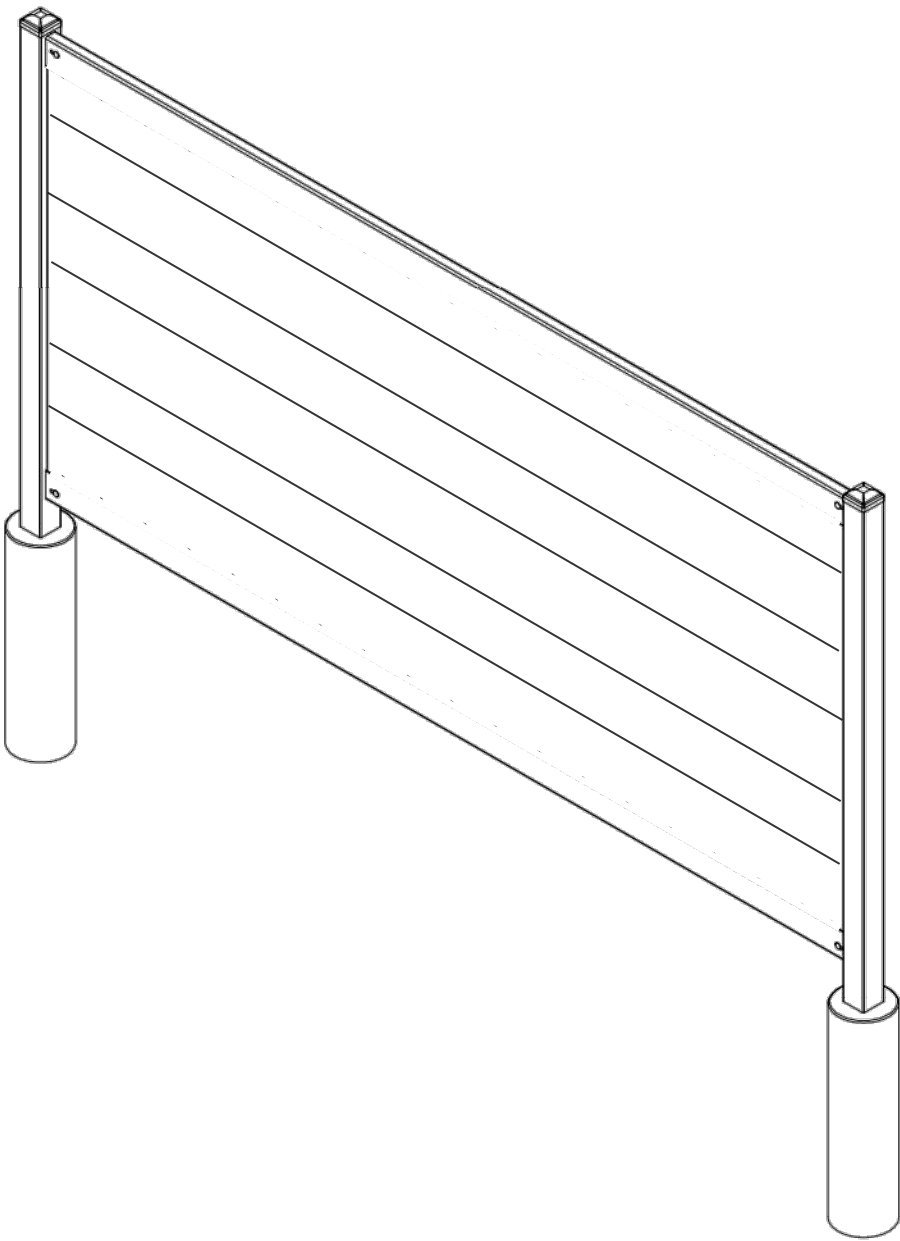

PARTS LIST		
ITEM	PART NUMBER	DESCRIPTION
1	2.5in x 2.5in x 7ft 16ga Post	
2	2.5in x 2.5in Post Cap	
3	1in x 6in x 4ft Boards	Quantity may vary depending on the type of boards or infill chosen.
4	1in x 6in x 4ft Boards Notched	2 Boards or infill to be notched for bolt clearance at the left and right ends.
5	2in x 4ft Fence Rail	
6	3in x 8ft Fence Rail	
7	Concrete Pillar 6in Diameter	
8	Hardware Kit Items Listed Below	
9	ANSI B18.5 - 1/4-20 UNC - 1.5	Round Head Square Neck Bolt
10	IFI 100/107 - 1/4 - 20	Prevailing Torque Type Hex Flange Nut
11	ANSI B18.6.4 - No. 10 - 16 - 5/8	Cross Recessed Truss Head Tapping Screw - Type BT - Type I

ARCHITECT:

KATHRYN CULLEY-RAPATA, AIA
CA LICENSE NO. C-31564
CONTACT: KATE CULLEY-RAPATA
PH: 510-459-5138

STAMP & SEAL:

PROJECT CONSULTANT:

globeateliè
5655 SILVER CREEK VALLEY ROAD #200,
SAN JOSE CA 95138

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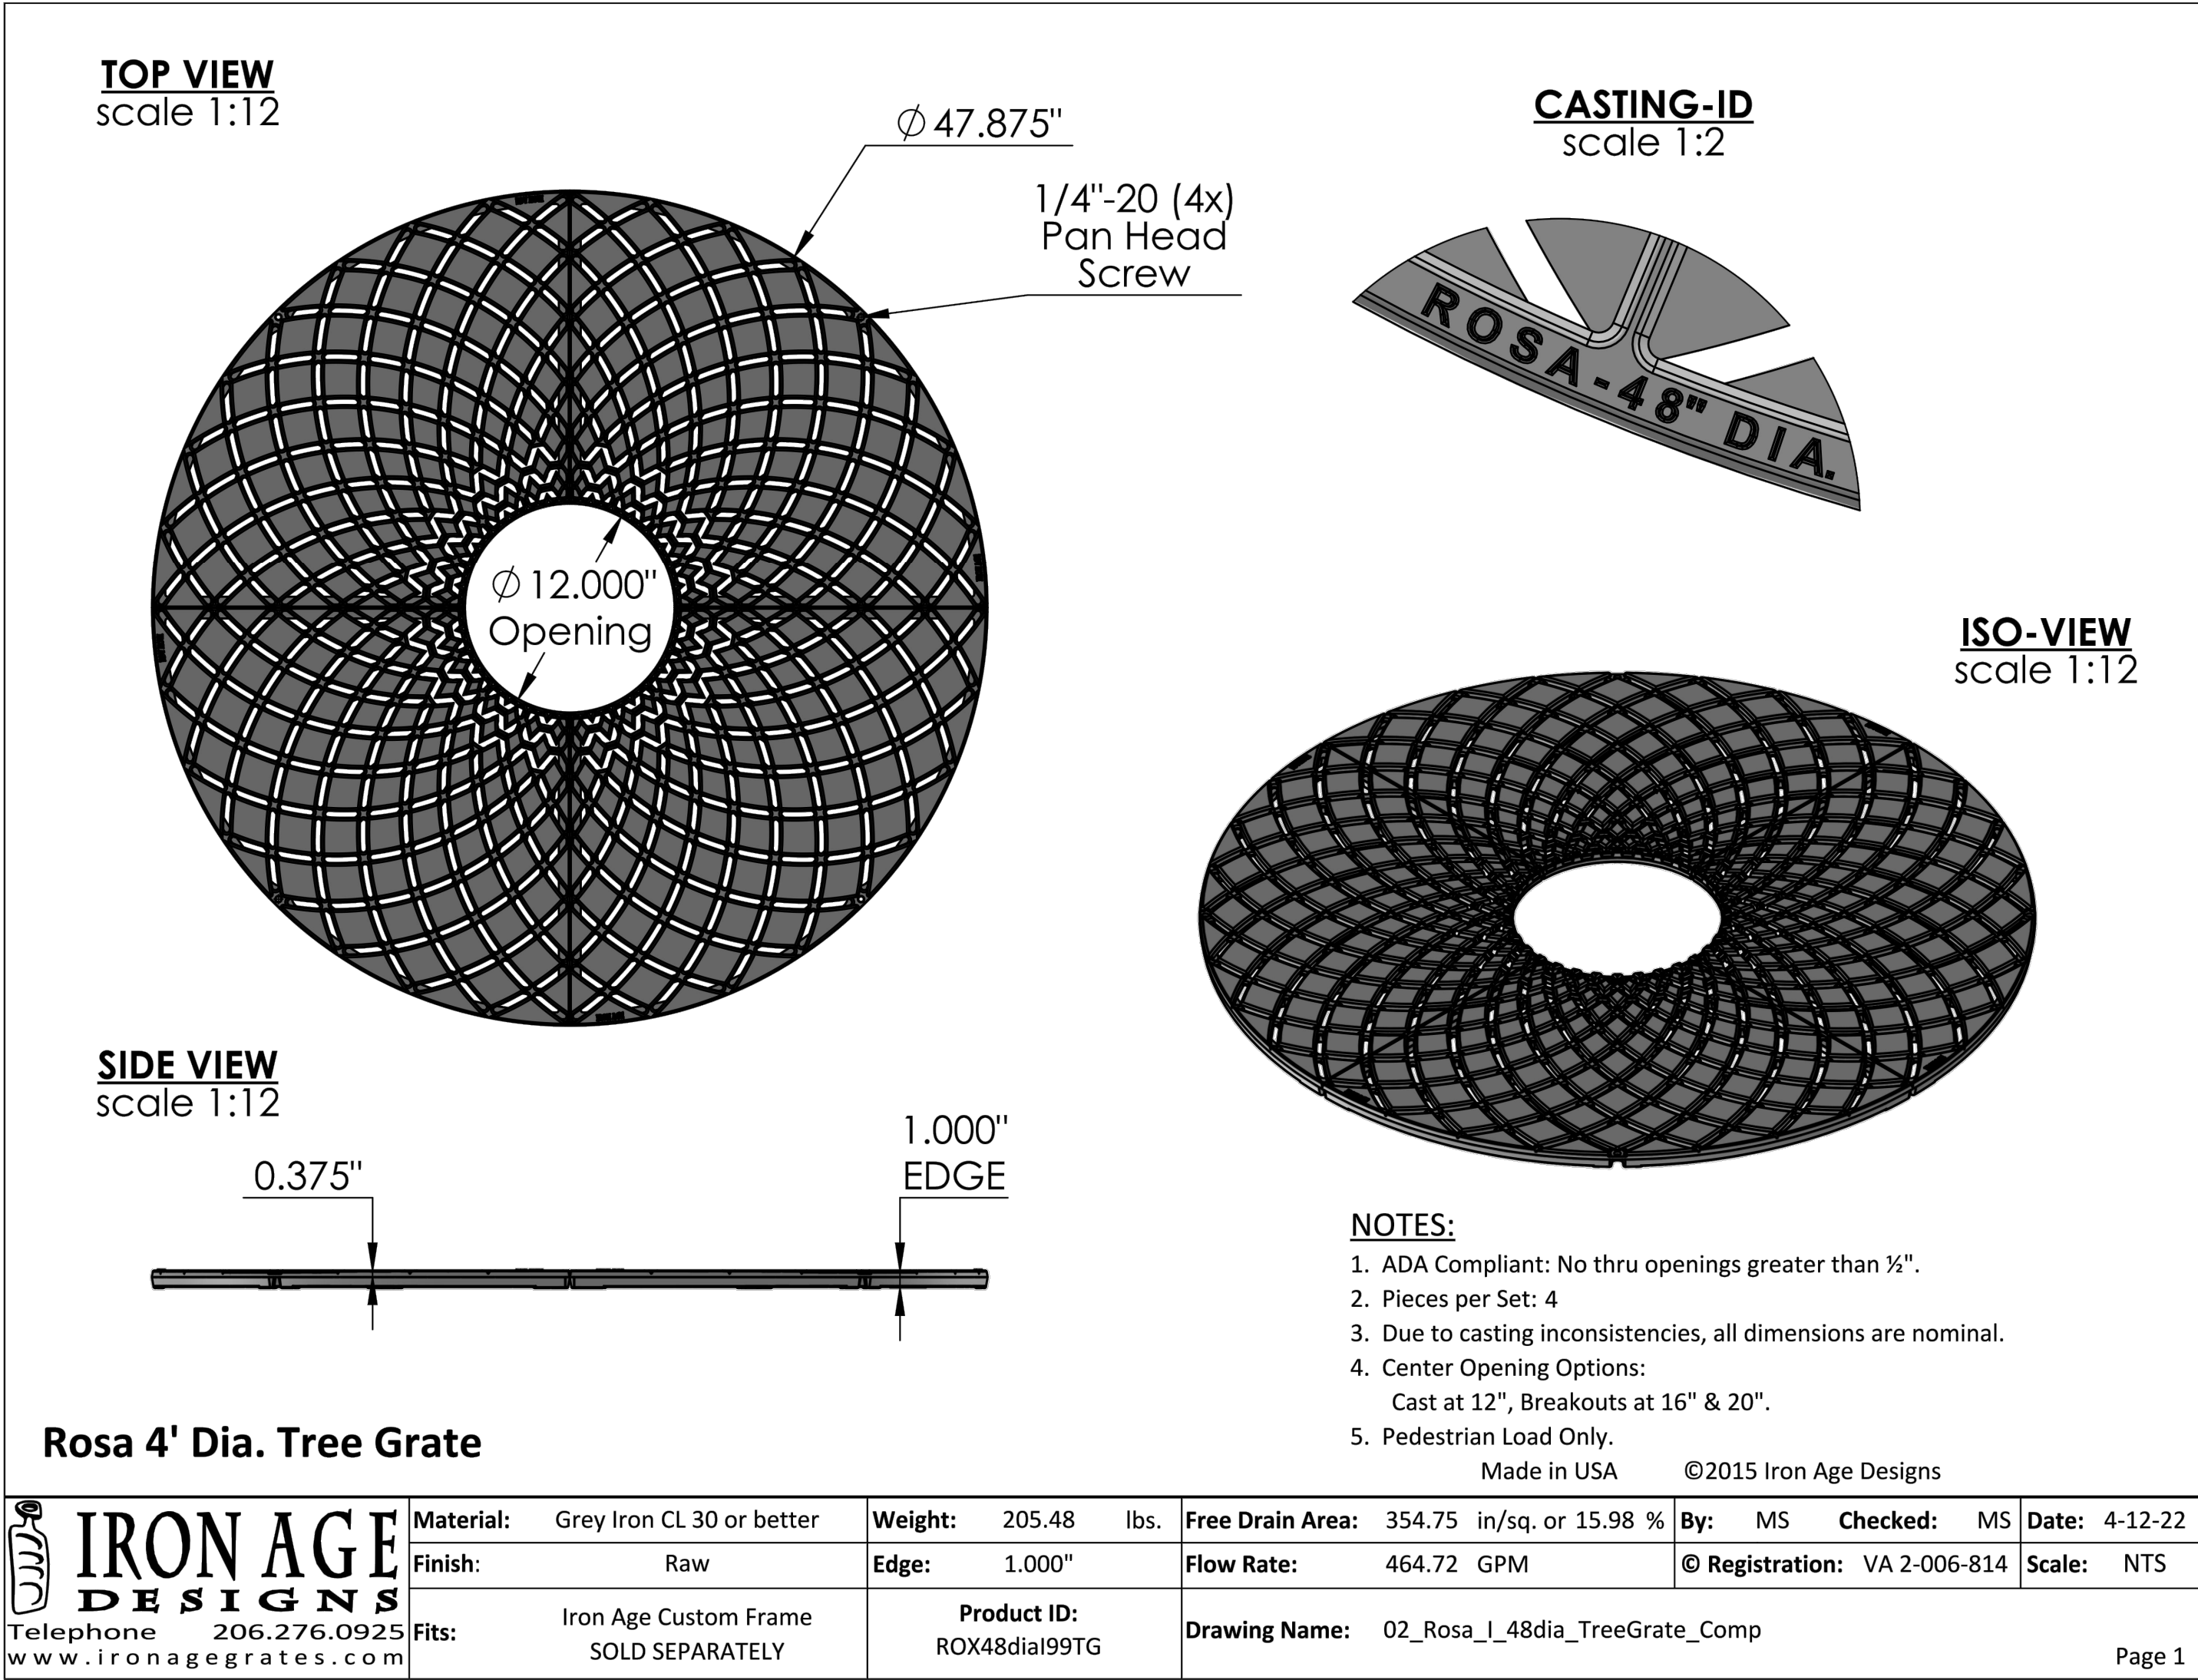
DRAWN BY: NR
CHECKED BY: KCR

SHEET TITLE

**FENCE
SPECIFICATION**

SHEET NUMBER


X.03



City of Palo Alto Tree Protection - It's Part of the Plan!

Make sure your crews and subs do the job right!

Fenced enclosures around trees are essential to protect them by keeping the foliage canopy and branching structure clear from contact by equipment, materials and activities, preserving roots and soil conditions in an intact and non-compacted state, and identifying the Tree Protection Zone (TPZ) in which no soil disturbance is permitted and activities are restricted, unless otherwise approved. **An approved tree protection report must be added to this sheet when project activity occurs within the TPZ of a regulated tree.** For detailed information on Palo Alto's regulated trees and protection during development, review the **City Tree Technical Manual (TTM)** found at www.cityofpaloalto.org/trees/.



TREE DISCLOSURE STATEMENT

CITY OF PALO ALTO
Planning Division, 250 Hamilton Avenue
Palo Alto, CA 94301
(650) 329-2441
<http://www.cityofpaloalto.org>

Palo Alto Municipal Code, Chapter 8.10.040, requires disclosure and protection of certain trees located on private and public property, and that they be shown on approved site plans. A completed disclosure statement must accompany all building permit applications that include exterior work, all demolition or grading permit applications, or other development activity.

PROPERTY ADDRESS: _____

Are there Regulated trees on or adjacent to the property? ☐ YES ☐ NO (If no, proceed to Section 4)

[Sections 1-4 MUST be completed by the applicant. Please circle and/or check where applicable.]

1. Where are the trees? Check those that apply. (Plans must be submitted showing over 4" diameter trees)
☐ On the property
☐ On adjacent property overhanging the project site
☐ In the City planter strip or right-of-way easement within 30' of property line (Street Trees)*

*Street trees require special protection by a fenced enclosure, per the attached instructions. Prior to receiving any permit, you must provide an authorized Street Tree Protection Verification form by calling Public Works Operations at 493-5953 for inspection of required type I, II or III fencing (see attached Detail #605).

2. Are there any Protected or Designated Trees? ☐ YES (Check where applicable) ☐ NO
☐ Protected Tree (s)
☐ Designated Tree (s)
☐ On or overhanging the property

3. Is there activity or grading within the dripline? (radius 10 times the trunk diameter) of these trees? ☐ YES ☐ NO
If Yes, a **Tree Preservation Report** must be prepared by an ISA certified arborist and submitted for staff review (see TTM, Section 6.25). Attach this report to Sheet T-1, Tree Protection, its Part of the Plan! per Site Plan Requirements.

4. Are the Site Plan Requirements** completed? ☐ YES ☐ NO

**Protection of Regulated trees during development require the following: (1) Plans must show the measured trunk diameter and canopy dripline; (2) Plans must denote, as a bold dashed line, a fenced enclosure area out to the dripline, per Sheet T-1 and Detail #605 - <http://www.cityofpaloalto.org/trees/forms.htm> (See also TTM - Section 2.15 for area to be fenced)

I, the undersigned, agree to the conditions of this disclosure. I understand that knowingly or negligently providing false or misleading information in response to this disclosure requirement constitutes a violation of the Palo Alto Municipal Code Section 8.10.040, which can lead to criminal and/or civil legal action.

Signature: _____ Print: _____ Date: _____
(Prop. Owner or Agent)

FOR STAFF USE:
Protective Fencing
Sections 5-6 must be completed by staff for the issuance of any development permit (demolition, grading or building permit).

5. Protected Trees. The specified tree fencing is in place. A written statement is attached verifying that protective fencing is correctly in place around protected and/or designated trees. ☐ YES ☐ NO
(N/A if there are no protected trees, check here ☐)

6. Street Trees. A signed Public Works Street Tree Protection Verification form is attached. ☐ YES ☐ NO
(N/A if there are no street trees, check here ☐)

Regulated Trees – a) Street trees – trees on public property; b) Protected trees – Coast Live Oaks or Valley Oaks which are 11.5" in diameter or larger, Coast Redwoods which are 18" in diameter or larger, when measured 54" above natural grade; and Heritage trees are trees designated by City Council; and c) Designated Trees – commercial or non-residential property trees, which are part of an approved landscape plan.

Palo Alto Tree Technical Manual (TTM) contains instructions for all requirements on this form, available at <http://www.cityofpaloalto.org/planning-community/tree-technical-manual.html>

S:Plan/Pladv/Arborist/Tree Protection Info/Tree Disclosure Statement

Revised 09/06

City of Palo Alto

250 Hamilton Avenue, Palo Alto, CA 94301


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June, 2001 First Edition

View by section:

Table of Contents (PDF, 87KB)

Intent and Purpose (PDF, 1.05MB)

Introduction – Use of Manual (PDF, 1.05MB)

Section 1.0 – Definitions (PDF, 96KB)

Section 2.0 – Protection of Trees During Construction (PDF, 259KB)

Section 3.0 – Removal, Replacement & Planting of Trees (PDF, 117KB)

Section 4.0 – Hazardous Trees (PDF, 105KB)

Section 5.0 – Tree Maintenance Guidelines (PDF, 110KB)

Section 6.0 – Tree Reports (PDF, 84KB)

View ALL sections:

Tree Technical Manual – Full (PDF, 1.84MB)

APPENDICES

A: Palo Alto Municipal Code Chapter 8.10, Tree Preservation & Management Regulations

B: Tree City – USA

C: ISA Hazard Evaluation Form

D: List of Inherent Failure Patterns for Selected Species (Reference source)

E: ISA Tree Pruning Guidelines (PDF, 1.85MB)

F: Tree Care Safety Standards, ANSI Z133.1-1994 (Reference source)

G: Pruning Performance Standards, ANSI A300-1995 (Reference source)

H: Tree Planting Details, Diagram 504 & 505

I: Tree Disclosure Statement

J: Palo Alto Standard Tree Protection Instructions

For written specifications associated with illustrations below, see Public Works Specifications Section 31

Detailed specifications are found in the Palo Alto Tree Technical Manual (TTM) (www.cityofpaloalto.org/trees/)

Tree Protection Zone (TPZ) shown in gray (radius of TPZ equals 10-times the diameter of the tree or 10-feet, whichever is greater).

• Restricted activity area – see Tree Technical Manual Sec 2.15(E).

• Restricted trenching area – see Tree Technical Manual Sec 2.20(C-D), any proposed trench or form work within TPZ of a protected tree requires approval from Public Works Operations. Call 650-496-5953.

For all Ordinance Protected and Designated trees, as detailed in the site specific tree preservation report (TPR) prepared by the applicant's project arborist as diagramed on the plans.

Type I Tree Protection

8.5x11-inch Warning Signs one each side

6-foot high chain link fence, typical

TPZ either 10 x Tree Diameter or 10-feet whichever is greater

Warning

TPZ

TPZ

Note: Ordinance Protected & Designated Trees. Issuance of a permit requires applicant's project arborist written verification Type I is installed correctly according to the plans and Tree Preservation Report

Any inadvertent sidewalk or curb replacement or trenching requires approval

Fence distance to outer branches or TPZ

Warning

Street

Parkway

Sidewalk

Yard

Strip

TPZ

Type II Tree Protection

2-inches of Orange Plastic Fencing overlaid with 2-inch Thick Wooden Slats

Any proposed trench in TPZ requires approval See TTM 2.20 C-D for instructions

Restricted use for trees in sidewalk cutting-tree wells only

Note: Street Trees. Issuance of a permit requires Public Works Operations inspection and signed approval on the Street Tree Verification (STV) form provided.

Type III Tree Protection

(to be used only with approval of Public Works Operations)

Tree fencing is required and shall be erected before demolition, grading or construction begins.

Rev By Date

0 DWH 12/14/92

01 D.D. 08/04/04

02 D.D. 08/10/06

Scale: NTS

Tree Protection During Construction

City of Palo Alto Standard

Approved by: Dave Dockter

PE No. _____

Date 2006

Dwg No. 605

City of Palo Alto

250 Hamilton Avenue, Palo Alto, CA 94301


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H: Tree Planting Details, Diagram 504 & 505

I: Tree Disclosure Statement

J: Palo Alto Standard Tree Protection Instructions

City of Palo Alto Tree Technical Manual

ADDENDUM 11

Arborist Firm Data Here

RCA/ISA Certified Arborist #WE-000
Contact Cell # _____

Monthly Tree Activity Report- Construction Site

Inspection Date: _____

Site address: _____

Inspector # _____

Contractor- Main Site Contact Information

#1: Job site superintendent
Company: _____
Email: _____
Job site Office: _____
Cell: _____
Mail: _____

Also present:

• _____
• _____

Distribution:

1. City of Palo Alto

2. Others

Attn: Dave Dockter

Dave.dockter@cityofpaloalto.org

650-329-2440

Provide the requested minimum information with each report, customize as necessary. To be completed by project site arborist. Send monthly to city arborist at above address until project completion. Use additional sheets as needed.

1. Assignment Activity (Demolition/grading/sewer/trenching/foundation list relevant visits)
a. Pre-construction meeting requirement with sub-contractors
b. Inspect to verify that tree protection measures are in place
c. Determine if field adjustments, watering or plan revisions may be needed

2. Field Observations (general site-wide and list by individual tree number)
a. Tree Protection Fences (TPF) are ...
b. Trenching has/will occur ...

3. Action Items (list site-wide, by tree number and date to be satisfied) and Date Due
a. Tree Protection Fence (TPF) needs adjusting (tree # x, x, x)
b. Root zone buffer material (wood chips) can be installed next
c. Schedule sewer trench, foundation dig with ...

4. Photographs (use often)

5. Tree Location Map (mandatory 8.5 x 11 sheet)

6. Recommendations, notes or monitor items for project/staff/schedule

• _____

7. Past visits (list carry-over items satisfied/still outstanding)

• _____

Respectfully submitted,

Project site arborist
Consultant contact information (Include email, cell#, and mailing)
Cc: _____
Enter Date _____ CPA Monthly Tree Activity Report: Type site address here Page #1 of 1

City of Palo Alto

Tree Department

Public Works Operations

PO Box 10250 Palo Alto, CA 94303

650/496-5953 FAX: 650/802-4289

treeprotection@cityofpaloalto.org

Verification of Street Tree Protection

Applicant Instructions: Complete upper portion of this form. Mail or FAX this form along with signed Tree Disclosure Statement to Public Works Dept. Public Works Tree Staff will inspect and notify applicant.

APPLICATION DATE:

ADDRESS/LOCATION OF STREET TREES TO BE PROTECTED:

APPLICANT'S NAME:

APPLICANT'S ADDRESS:

APPLICANT'S TELEPHONE & FAX NUMBERS:

This section to be filled out by City Tree Staff

1. The Street Trees at the above address(es) are adequately protected. The type of protection used is:

YES ☐ NO ☐

* If NO, go to #2 below

Inspected by:

Date of Inspection:

2. The Street Trees at the above address are NOT adequately protected. The following modifications are required:

Indicate how the required modifications were communicated to the applicant.

Subsequent Inspection

Street trees at above address were found to be adequately protected:

YES ☐ NO ☐

* If NO, indicate in "Notes" below the disposition of case.

Inspected by:

Date of Inspection:

Notes: List City street trees by species, site, condition and type of tree protection installed. Also note if pictures were taken. Use back of sheet if necessary.

Return approved sheet to Applicant for demolition or building permit issuance.

S:\PW\GIS\Tree\GIS\TreeProtect

9/17/06

City of Palo Alto Tree Technical Manual

ADDENDUM 11

Arborist Firm Data Here

RCA/ISA Certified Arborist #WE-000
Contact Cell # _____

Monthly Tree Activity Report- Construction Site

Inspection Date: _____

Site address: _____

Inspector # _____

Contractor- Main Site Contact Information

#1: Job site superintendent
Company: _____
Email: _____
Job site Office: _____
Cell: _____
Mail: _____

Also present:

• _____
• _____

Distribution:

1. City of Palo Alto

2. Others

Attn: Dave Dockter

Dave.dockter@cityofpaloalto.org

650-329-2440

Provide the requested minimum information with each report, customize as necessary. To be completed by project site arborist. Send monthly to city arborist at above address until project completion. Use additional sheets as needed.

1. Assignment Activity (Demolition/grading/sewer/trenching/foundation list relevant visits)
a. Pre-construction meeting requirement with sub-contractors
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5. Tree Location Map (mandatory 8.5 x 11 sheet)

6. Recommendations, notes or monitor items for project/staff/schedule

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• _____

Respectfully submitted,

Project site arborist
Consultant contact information (Include email, cell#, and mailing)
Cc: _____
Enter Date _____ CPA Monthly Tree Activity Report: Type site address here Page #1 of 1

---WARNING---

Tree Protection Zone

This fencing shall not be removed without City Arborist approval (650-496-5953)

Removal without permission is subject to a \$500 fine per day*

*Palo Alto Municipal Code Section 8.10.110

City of Palo Alto Tree Protection Instructions are located at <http://www.city.palo-alto.ca.us/trees/technical-manual.html>

SPECIAL INSPECTIONS

PLANNING DEPARTMENT

TREE PROTECTION INSPECTIONS MANDATORY

PAMC 8.10 PROTECTED TREES. CONTRACTOR SHALL ENSURE PROJECT SITE ARBORIST IS PERFORMING REQUIRED TREE INSPECTION AND SITE MONITORING. PROVIDE WRITTEN MONTHLY TREE ACTIVITY REPORTS TO THE PLANNING DEPARTMENT LANDSCAPE REVIEW STAFF BEGINNING 14 DAYS AFTER BUILDING PERMIT ISSUANCE.

BUILDING PERMIT DATE: _____

DATE OF 1ST TREE ACTIVITY REPORT: _____

CITY STAFF: _____

REPORTING DETAILS OF THE MONTHLY TREE ACTIVITY REPORT SHALL CONFORM TO SHEET T-1 FORMAT, VERIFY THAT ALL TREE PROTECTION MEASURES ARE IMPLEMENTED AND WILL INCLUDE ALL CONTRACTOR ACTIVITY, SCHEDULED OR UNSCHEDULED, WITHIN A TREE PROTECTION ROOT ZONE. NON-COMPLIANCE IS SUBJECT TO VIOLATION OF PAMC 8.10.080. REFERENCE: PALO ALTO TREE TECHNICAL MANUAL, SECTION 2.00 AND ADDENDUM 11.

APPLY TREE PROTECTION REPORT ON SHEET(S) T-2


Use additional "T" sheets as needed

ARCHITECT:

KATHRYN CULLEY-RAPATA, AIA
CA LICENSE NO. C-31564
CONTACT: KATE CULLEY-RAPATA
PH: 510-459-5136

STAMP & SEAL:

PROJECT CONSULTANT:


globeatelié
5655 SILVER CREEK VALLEY ROAD #260,
SAN JOSE CA 95138

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theMELT

THE MELT, STANFORD

180 EL CAMINO REAL, SUITE 705A, BLDG. E,
PALO ALTO, CALIFORNIA 94304

PROJECT:

PROJECT#: GA21-MLT004
DOCUMENT DATE: 07-05-22
DOCUMENT PHASE:

ARB SET

DATE 07-05-22 ISSUE ARB SET

DRAWN BY: NR
CHECKED BY: KCR
SHEET TITLE

SPECIAL TREE PROTECTION INSTRUCTION SHEET

SHEET NUMBER

T-1

City of Palo Alto

Tree Protection - It's Part of the Plan!

Make sure your crews and subs do the job right!


Fenced enclosures around trees are essential to protect them by keeping the foliage canopy and branching structure clear from contact by equipment, materials and activities, preserving roots and soil conditions in an intact and non-compacted state, and identifying the Tree Protection Zone (TPZ) in which no soil disturbance is permitted and activities are restricted, unless otherwise approved. **An approved tree protection report must be added to this sheet when project activity occurs within the TPZ of a regulated tree.**

For detailed information on Palo Alto's regulated trees and protection during development, review the **City Tree Technical Manual** (TTM) found at www.cityofpaloalto.org/trees/.

DESCRIPTION :

LITTLE LEAF PALO VERDE

- CALIFORNIA NATIVE
- PLANTING AREA: 2' TO 5'
- WATER USE RATING: LOW
- TREE SHAPE: ROUNDED
- FOLIAGE TYPE: DECIDUOUS
- MAXIMUM TREE HEIGHT: 20 FEET
- CANOPY WIDTH: 20 FEET
- GROWTH RATE: ~36 IN/YEAR
- LEAF ARRANGEMENT AND FORM: ALTERNATE, PINNATELY COMPOUND
- LEAF/LEAFLET SHAPE: OVAL
- LEAF COLOR: LIGHT GREEN
- FLOWERS: SHOWY
- FLOWER COLOR: YELLOW.
- FLOWER TYPE: HAS MALE AND FEMALE REPRODUCTIVE PARTS IN EACH FLOWER (PERFECT)
- FLOWERING TIME: SPRING
- FRUIT: LARGE BROWN OR MOSTLY GREEN LEGUME
- FRUITING TIME: WINTER OR SUMMER
- BARK: GREEN OR ORANGE, EXFOLIATING, SMOOTH
- LITTER: DRY FRUIT

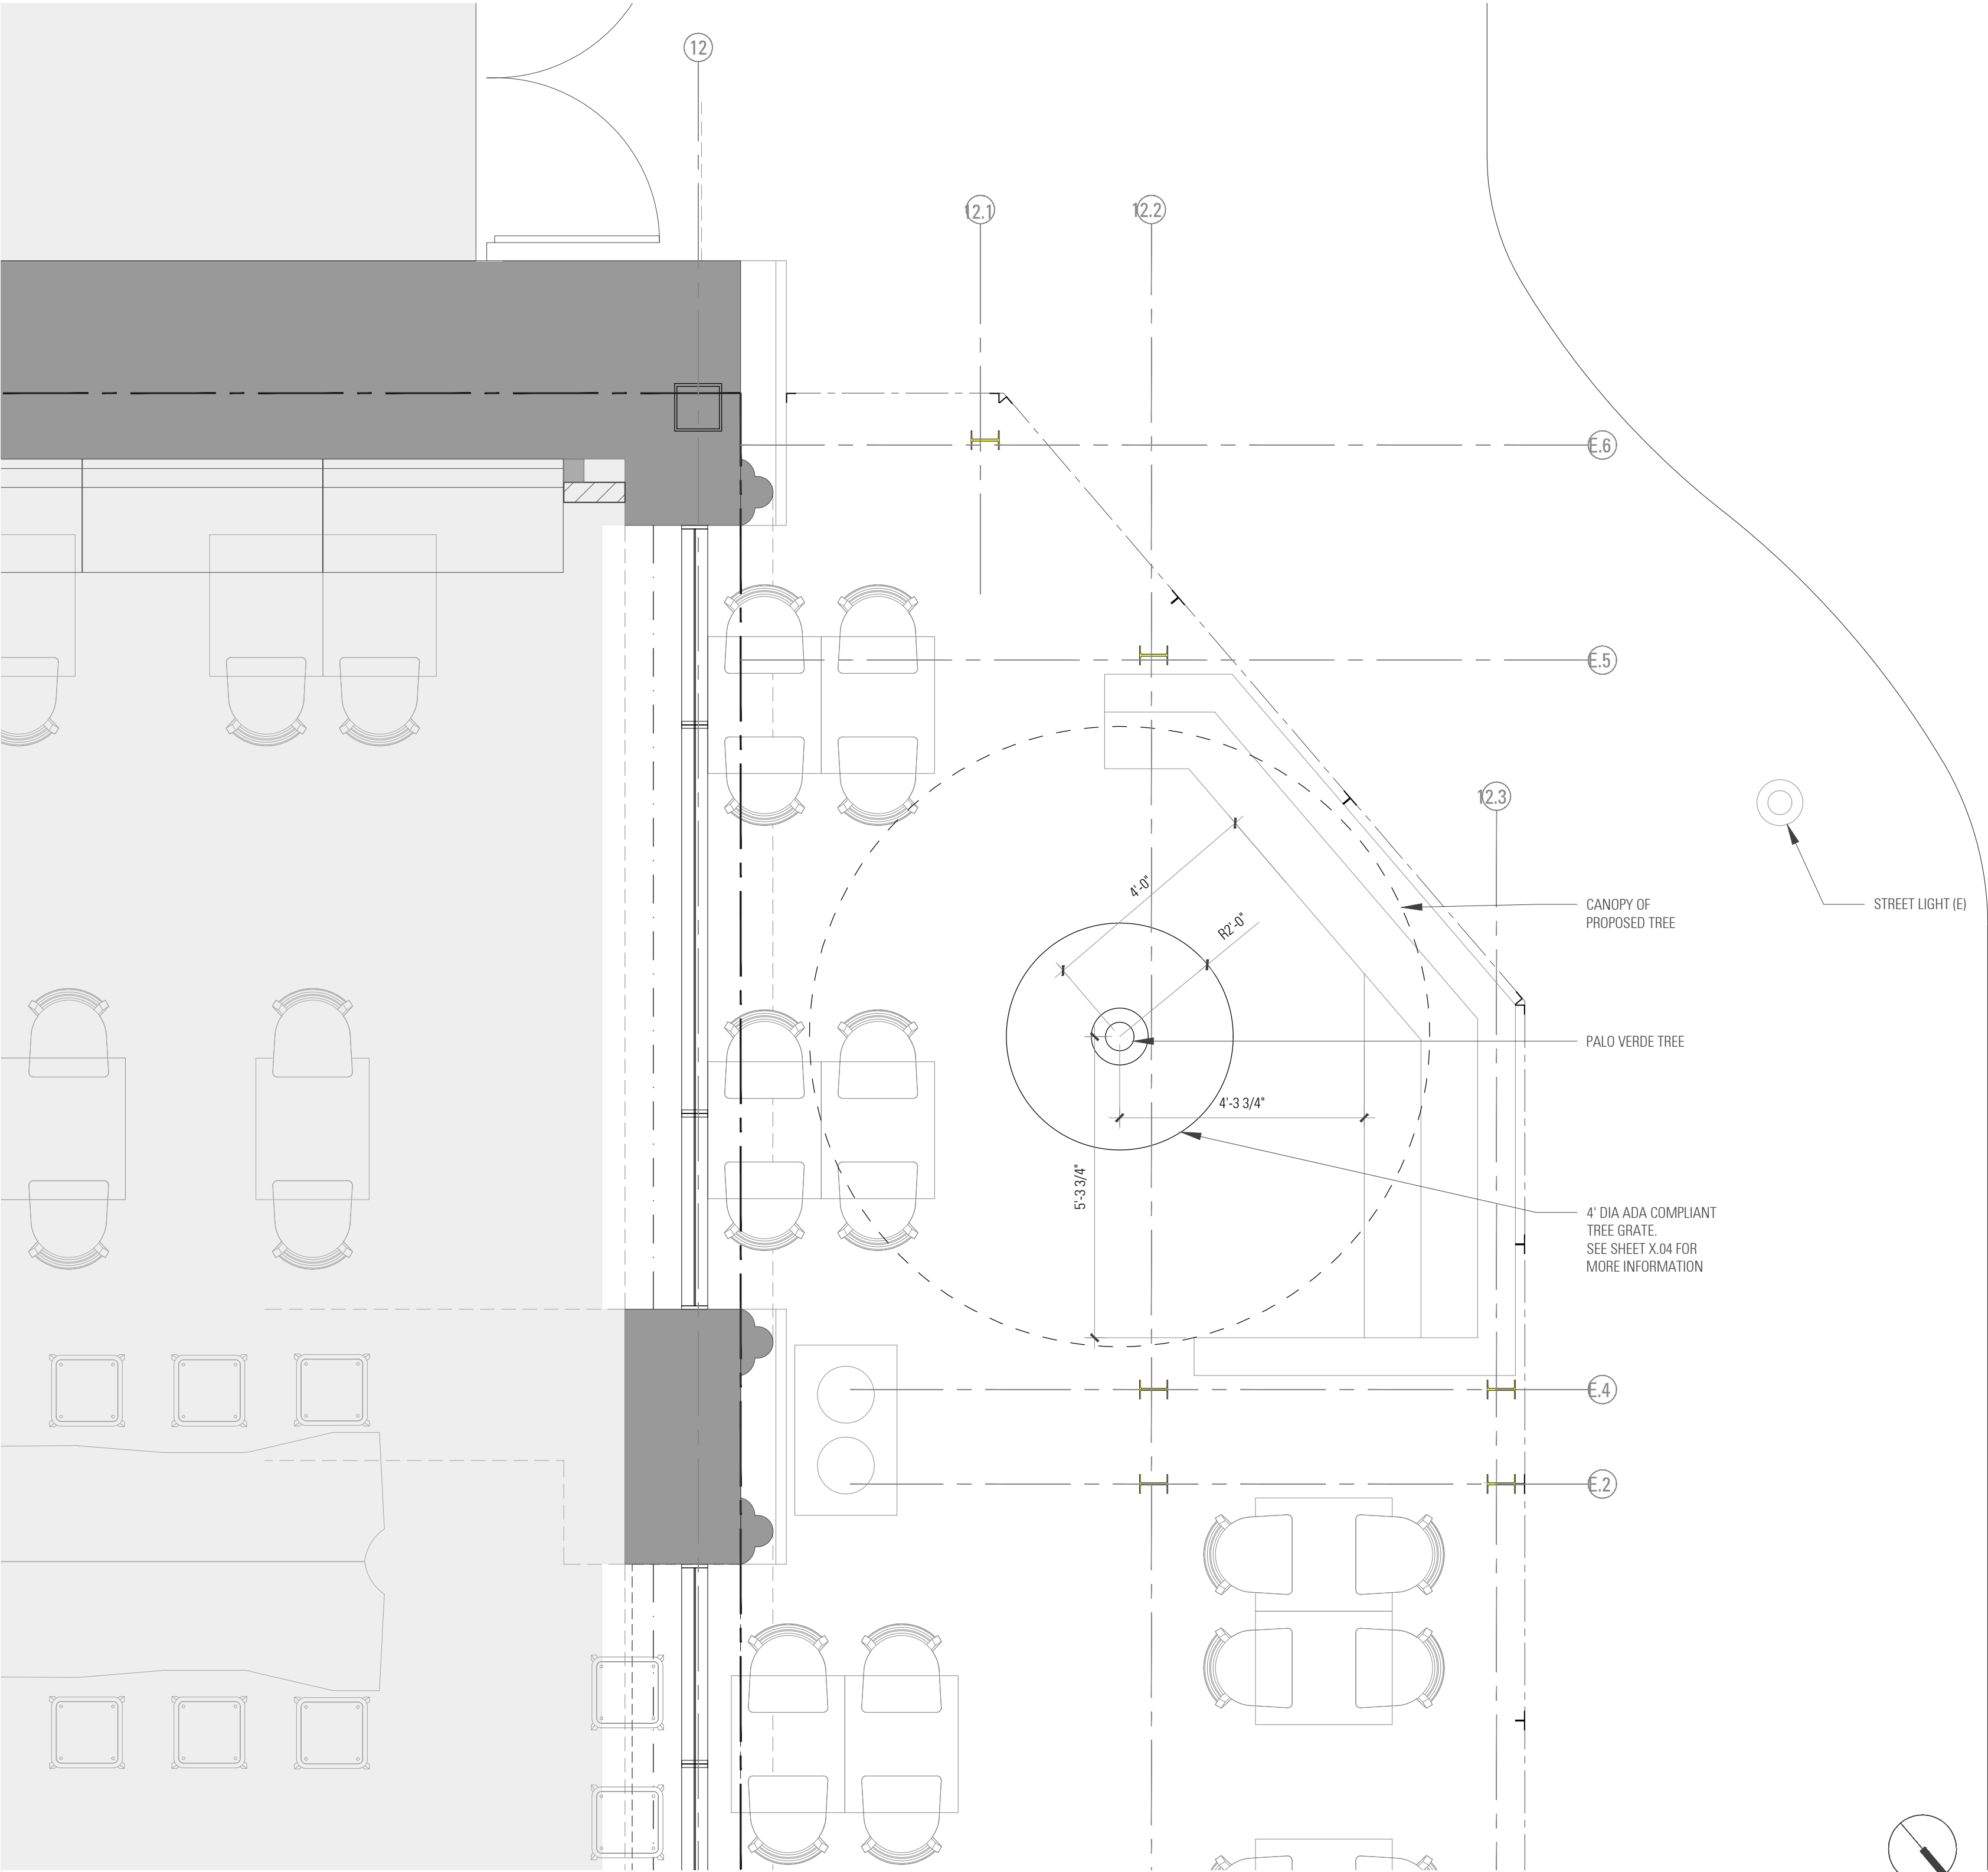

1 ENLARGED PLAN AT TREE WELL
1/2" = 1'-0"

ARCHITECT:

KATHRYN CULLEY-RAPATA, AIA
CA LICENSE NO. C-31564
CONTACT: KATE CULLEY-RAPATA
PH: 510-459-5138

STAMP & SEAL:

PROJECT CONSULTANT:

globeateliè
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SAN JOSE CA 95138

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CLIENT:

theMELT

THE MELT, STANFORD
180 EL CAMINO REAL, SUITE 705A, BLDG. E,
PALO ALTO, CALIFORNIA 94304

PROJECT:

PROJECT#: GA21-MLT004
DOCUMENT DATE: 07-05-22
DOCUMENT PHASE:

ARB SET

DATE: 07-05-22
ISSUE: PERMIT / UL REVIEW SET

DRAWN BY: NR

CHECKED BY: KCR

SHEET TITLE

**SPECIAL TREE
PROTECTION
INSTRUCTION SHEET**

SHEET NUMBER

T-2



1.1 OPEN FACE LETTERS W/ EXPOSED BULBS
Scale: 5/8"=1'-0" 20.2 SQ FT

COLOR SCHEDULE

 FAUX CORTEN


GENERAL NOTES

- 5" DEEP OPEN FACE CHANNEL LETTERS
- PAINTED FAUX CORTEN ON ALL SIDES
- AMBER LED EXPOSED BULBS

** EACH SIGN WILL REQUIRE IT'S OWN 110 VOLT 20 AMP DEDICATED CIRCUIT PROVIDED BY OTHERS WITHIN 6' OF THE SIGN AREA AND ON A TIMER AND/OR PHOTOCELL DEPENDING ON LOCAL SIGN REQUIREMENTS.

IF NO ELECTRICAL IS PRESENT AT TIME OF INSTALLATION, A WHIP WILL BE LEFT FOR OTHERS TO HOOK UP **

ALL COMPONENTS  LISTED

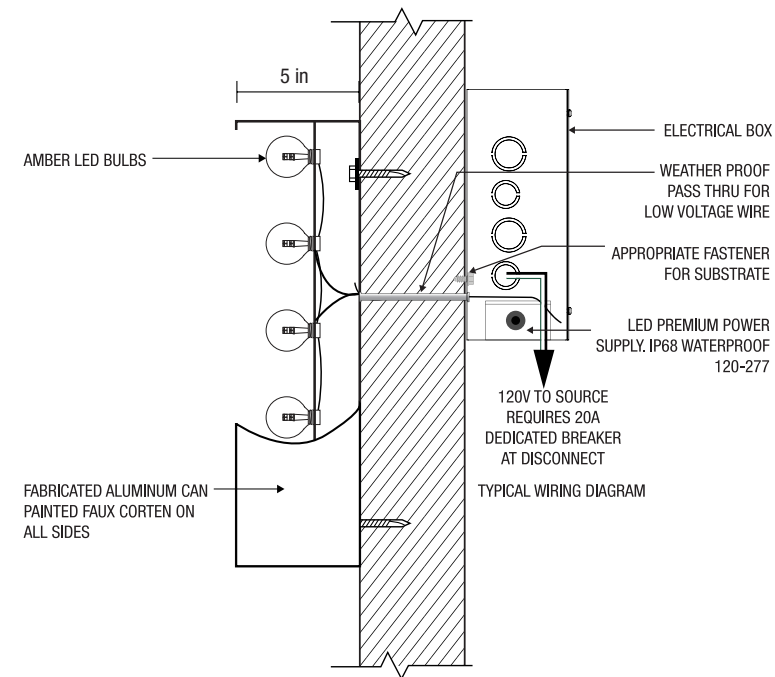

** ALL BOLTS AND SCREWS ARE STAINLESS STEEL **

1.2 PROPOSED MOUNTING DETAILS
Scale: NTS



1.3 PROPOSED FRONT ELEVATION
Scale: 1/8"=1'-0"



NIGHT SIMULATION



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PROJECT INFORMATION COMPANY & LOCATION

The Melt
180 El Camino Real
Suite 705
Palo Alto, CA 94304

OVERVIEW

Exterior Signs

DATE	PROJECT #
06/08/22	SDLP2538

DESIGNER

JEN

REVISIONS

APPROVAL

- ☐ APPROVED WITH NO CHANGES
☐ APPROVED WITH CHANGES AS NOTED
☐ REVISE AS NOTED AND RESUBMIT

Signature

Date

DESIGN

A03

SHEET

01 of 05

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Colors and designs are representations of the final product. Final signage colors and build will be based on specifications noted on final proofs and/or invoice.



2.1

ILLUMINATED LETTERS ON BACKERS (TBD)

Scale: 1/2"=1'-0" Total: 34 SQ FT

FIELD SURVEY REQUIRED

All signage will need to be field verified which could ultimately change final scope of work and pricing.

All proposed signs require corporate approval.



2.3

PROPOSED FRONT ELEVATION

Scale: NTS

COLOR SCHEDULE

- DARK GRAY (TBD)
- WHITE
- FAUX CORTEN

GENERAL NOTES

BACKERS:

- 3" DEEP ALUMINUM BACKER PAINTED DARK GRAY (TBD)

WORLD'S/BURGER:

- ALUMINUM ROUTED FACE WITH 1/2" WHITE ACRYLIC PUSH-THRU LETTERS
- UL APPROVED WHITE LED ILLUMINATION

MELTIEST:

- 3" DEEP OPEN FACE CHANNEL LETTERS
- ROUTED FACE W/ ACRYLIC PUSH-THRU RODS TO SIMULATE BULBS
- UL APPROVED AMBER LED ILLUMINATION

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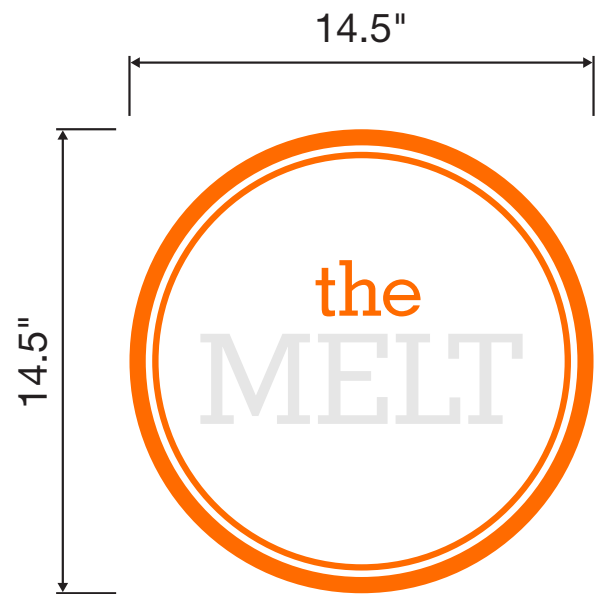
A03

SHEET

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



3.1 *BUTTON LOGO VINYL - QTY 2*
Scale: 2"=1'-0"

FIELD SURVEY REQUIRED

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COLOR SCHEDULE

-  3M KUMQUAT ORANGE 3630-74
-  3M WHITE

DETAILS
CONTOUR CUT VINYL APPLIED FIRST SURFACE.



3.2 *PROPOSED PLACEMENT*
Scale: NTS



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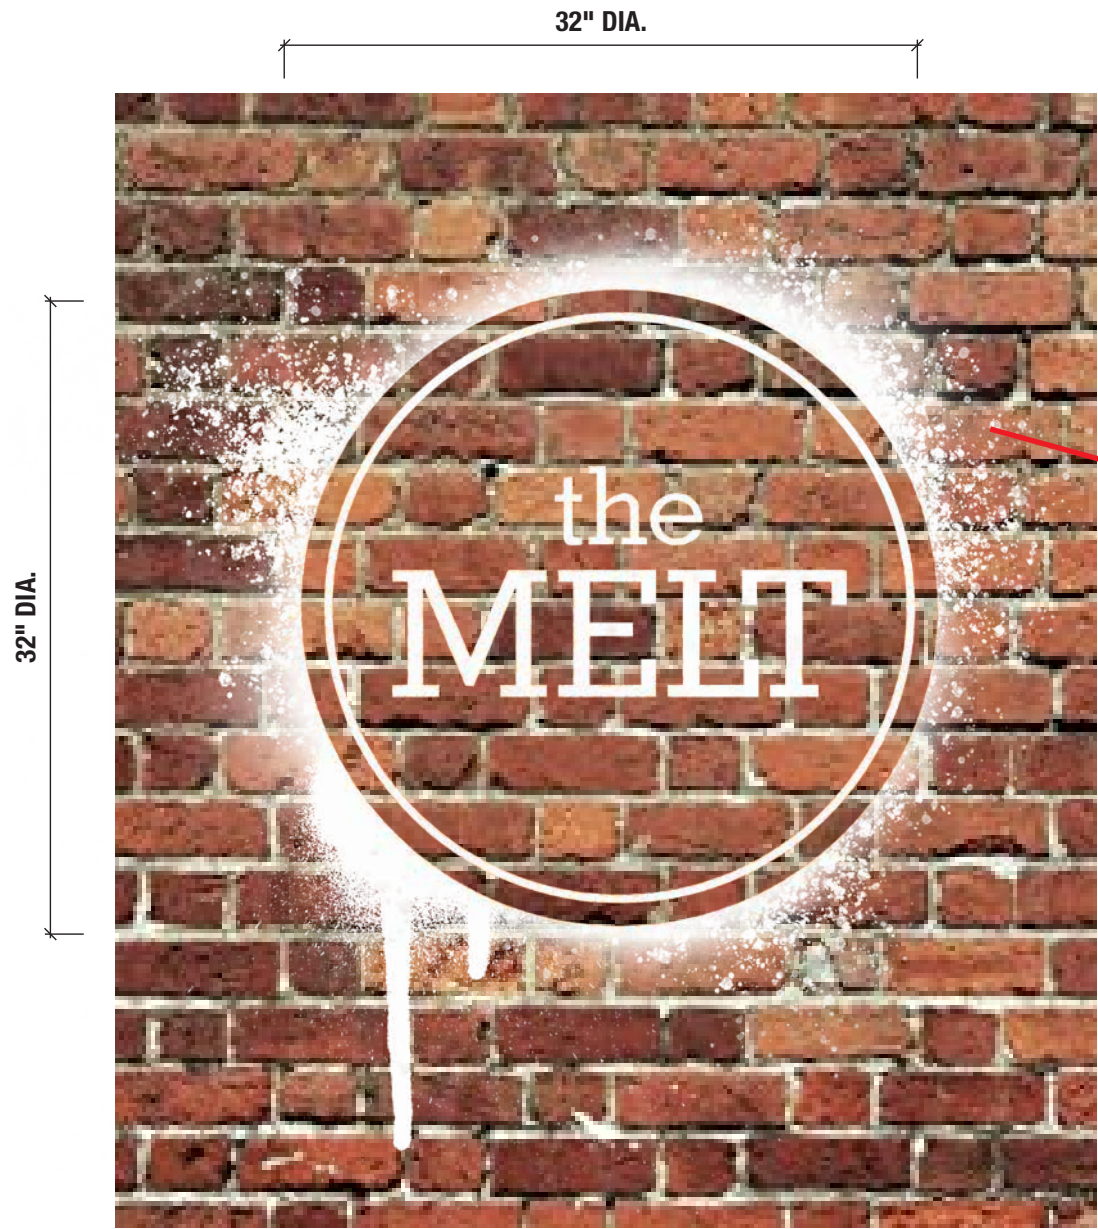
SHEET

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APPROX. SIZING



4.1 SPRAY PAINTED LOGO
Scale: 1-1/4"=1'-0"

PAINTED ON SITE AND TO BE DONE OTHERS



4.2 PROPOSED LOCATION
Scale: NTS



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5.1 **SITE MAP**
Scale: NTS



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