## HOMEKEY PALO ALTO

# SUPPORTIVE INTERIM HOUSING 1237 San Antonio Road, Palo Alto, California

## ARCHITECTURAL REVIEW BOARD SUBMITTAL APRIL 07, 2022

#### DRAWING INDEX

GENERAL

A0.01 TITLE SHEET

#### ARCHITECTURAL

A1.00 SITE CONTEXT PHOTOS A1.01 SITE PHOTOS A1.02 3D VIEWS

A1.03 SITE CONTEXT ELEVATIONS

A2.11 GROUND LEVEL PLAN & MODULE SCHEDULE

A2.21 SECOND LEVEL PLAN

SITE DEMOLITION PLAN

A2.31 ROOF PLAN

A3.01 SITE SECTIONS

A3.11 SITE ELEVATIONS A3.12 EXTERIOR MATERIALS

A4.11A SLEEPING MODULE SL-2-BA DETAILS SLEEPING MODULE SL-2-BA DETAILS

A4.12A SLEEPING MODULE SL-FAM DETAILS

A5.01 COMMUNITY BUILDING ENLARGED PLAN
A5.02 COMMUNITY BUILDING ELEVATIONS & SECTIONS

A5.11 DINING HALL ENLARGED PLAN

PARKING LAYOUT & DETAILS

TYPICAL MODULE DETAILS

A5.12 DINING HALL ELEVATIONS & SECTIONS

A8.21 FENCE DETAILS

STRUCTURAL

<u>LANDSCAPE</u>

LO.11 LANDSCAPE PLANS

SO.11 FOUNDATION PLAN

TREE PROTECTION

T-1 SPECIAL TREE PROTECTION

#### PROJECT DIRECTORY

OWNER
CITY OF PALO ALTO
250 HAMILTON AV
PALO ALTO, CA 94301

ARCHITECT & STRUCTURAL ENGINEER
Office of CHARLES F. BLOSZIES
THREE EMBARCADERO CENTER
PROMENADE LEVEL SUITE P2
SAN FRANCISCO, CA 94111
Contact: CHARLES BLOSZIES
415.834.9002

OWNER REPRESENTATIVE/DEVELOPER/OPERATOR LIFEMOVES
181 CONSTITUTION DRIVE
MENLO PARK, CA 94025
Contact: JOANNE PRICE

650.685.5880

415.432.8100

CIVIL ENGINEER
BKF ENGINEERS
150 CALIFORNIA STREET
SUITE 600
SAN FRANCISCO, CA 94111
Contact: MIKE O'CONNELL
415.660.6360

MEYERS+ ENGINEERS
98 BATTERY ST
SUITE 500
SAN FRANCISCO, CA 94111
Contact: BRENDAN KOLTS

#### PROJECT DATA

INDIVIDUALS & COUPLES SLEEPING UNITS (1 BEDROOM, 1 BATHROOM, NO KITCHEN)

FAMILY SLEEPING UNITS (6 BEDROOMS, 2 BATHROOMS, NO KITCHEN)

TOTAL

COMMON USABLE OPEN SPACE

17,150 SF

225 SF/UNIT



### 2 3D VIEW

#### SCOPE OF WORK

PROJECT CONSISTS OF SITE PREPARATION AND CONSTRUCTION OF A NEW FACILITY TO PROVIDE SUPPORT SERVICES AND TEMPORARY HOUSING FOR FORMERLY HOMELESS INDIVIDUALS. NEW FACILITY WILL BE AN ASSEMBLY OF MODULAR UNITS (1-2 STORIES) SUPPORTED BY A NEW FOUNDATION SYSTEM. THE AREA BETWEEN MODULAR UNITS WILL BE RAISED AND PAVED AS NEEDED TO PROVIDE AT-GRADE ACCESS TO THE MODULES.

SLEEPING MODULES (R-2 OCCUPANCY) WILL BE FACTORY-BUILT HOUSING CERTIFIED BY THE CALIFORNIA DEPARTMENT OF HOUSING AND COMMUNITY DEVELOPMENT (HCD). SUPPORT SERVICES MODULES (B OCCUPANCY) AND STORAGE MODULES (S-2 OCCUPANCY) WILL BE COMMERCIAL MODULAR UNITS, ALSO CERTIFIED BY HCD. PROJECT ALSO INCLUDES TWO SITE-BUILT STRUCTURES FOR ADDITIONAL COMMUNAL SPACE AND DINING FACILITIES (B AND A-2 OCCUPANCIES) AND SITE-BUILT ELEVATOR CONTROL ROOMS. MOST STRUCTURES (WHETHER MODULAR OR SITE-BUILT) WILL INCLUDE FIELD-INSTALLED COMPONENTS, SUCH AS SOLAR PANELS, LIGHITNG, AND CANOPIES.

#### **GENERAL NOTES**

- 1. ALL WORK MUST COMPLY WITH CODES SPECIFICALLY REFERENCED ON THE DRAWINGS AS WELL AS THE LATEST VERSIONS OF BUILDING CODES, LAWS, AND ORDINANCES APPLICABLE TO THE WORK SHOWN ON THE CONSTRUCTION DOCUMENTS.
- 2. HAZARDOUS MATERIALS INVESTIGATION, TESTING, AND ABATEMENT ARE NOT WITHIN THE ARCHITECT'S PURVIEW. NOTIFY THE OWNER IF HAZARDOUS MATERIALS ARE SUSPECTED OR ENCOUNTERED DURING THE COURSE OF CONSTRUCTION.
- 3. WORK SHOWN IS BASED ON OBSERVED CONDITIONS AND DRAWINGS BY OTHERS. NOTIFY THE ARCHITECT IF CONDITIONS ARE ENCOUNTERED THAT DIFFER FROM THOSE SHOWN.
- 4. VERIFY ALL DIMENSIONS OF EXISTING CONDITIONS PRIOR TO COMMENCEMENT OF THE WORK. NOTIFY THE ARCHITECT OF ANY DISCREPANCIES.
- 5. DIMENSIONS SHOWN DEPICT THE SCOPE OF NEW CONSTRUCTION. NOTIFY THE ARCHITECT IF ADDITIONAL DIMENSIONS ARE REQUIRED TO CONSTRUCT THE WORK. <u>DO NOT SCALE THE DRAWINGS.</u>
- 6. DETAILS SHOWN ON THE PLANS THAT REFER TO SPECIFIC LOCATIONS APPLY TO ALL SIMILAR
- CONDITIONS UNLESS OTHERWISE NOTED.

  7. REPAIR EXISTING CONSTRUCTION DAMAGED DURING THE COURSE OF THE WORK TO MATCH CONDITIONS
- PRIOR TO THE COMMENCEMENT OF NEW CONSTRUCTION.

  8. SUBSTITUTIONS MUST BE APPROVED BY THE ARCHITECT AND THE OWNER PRIOR TO PURCHASE,
- FABRICATION OR INSTALLATION.

9. SUBMIT SHOP DRAWINGS, PRODUCT SAMPLES, AND PRODUCT INFORMATION FOR REVIEW BY THE

- ARCHITECT AS STIPULATED IN THE PROJECT SPECIFICATIONS OR CONSTRUCTION CONTRACT.

  10. MAINTAIN THE JOBSITE IN A NEAT AND ORDERLY CONDITION. DISPOSE OF TRASH, WASTE, AND DEBRIS
- IN A SAFE AND LEGAL MANNER OFF-SITE.

  11. THE ARCHITECT IS NOT RESPONSIBLE FOR SITE SAFETY AS WELL AS MEANS AND METHODS FOR
- CONSTRUCTION. SITE OBSERVATIONS BY THE ARCHITECT ARE NOT INTENDED TO BE REVIEW OR APPROVAL OF JOBSITE CONDITIONS.

  12. PREPARE, CLEAN, INSTALL, APPLY, CONNECT, AND CONDITION ALL MANUFACTURED COMPONENTS,
- 13. PREPARE EXISTING OR NEW SUBSTRATES ADEQUATELY TO ENSURE THAT THE QUALITY OF FINISHES WILL MEET OR EXCEED ACCEPTED INDUSTRY STANDARDS.


MATERIALS AND EQUIPMENT ACCORDING TO MANUFACTURER'S RECOMMENDATIONS AND INSTRUCTIONS.

14. PROVIDE MISCELLANEOUS CLIPS, ANCHORS, FASTENERS AND INSTALLATION ACCESSORIES AS REQUIRED TO ATTACH AND SECURE MATERIALS AND COMPONENTS TO THE BUILDING STRUCTURE. PROVIDE WOOD OR METAL STRAP BLOCKING FOR ATTACHMENT OF ALL MILLWORK, HANDRAILS, AND MISCELLANEOUS NON-STRUCTURAL ITEMS.

#### MODULAR APPROVALS

- 1. PRE-FABRICATED MODULAR UNITS SHALL BE PROVIDED BY MANUFACTURERS WITH CERTIFICATIONS FOR VOLUMETRIC UNITS. CERTIFICATIONS SHALL BE APPROPRIATE FOR THE OCCUPANCY TYPE AS FOLLOWS:
  R-2 OCCUPANCY: FACTORY BUILT HOUSING, CERTIFIED BY THE CALIFORNIA DEPARTMENT OF HOUSING AND COMMUNITY DEVELOPMENT.
  B and S-1 OCCUPANCY: COMMERCIAL MODULAR UNITS, CERTIFIED BY THE CALIFORNIA DEPARTMENT OF HOUSING
- 2. DESIGNS SHALL BE PREPARED BY INDIVIDUALS LICENSED IN THE STATE OF CALIFORNIA AND SHALL BE SUBMITTED TO THE ARCHITECT AND OWNER FOR REVIEW AND APPROVAL.
- 3. APPROVAL DOCUMENTS FOR THE BUILDING PERMIT PREPARED BY THE SITE A/E TEAM WILL INCLUDE STANDARD DETAILS FOR DISABLED ACCESS TYPICALLY REQUIRED BY LOCAL BUILDING OFFICIALS. THESE DETAILS WILL BE PROVIDED AS REFERENCE DETAILS FOR THE MODULAR UNIT DESIGNS, HOWEVER, CODE COMPLIANCE WITHIN THE MODULES WILL REMAIN THE SOLE RESPONSIBILITY OF THE VENDORS.
- 4. THE SITE A/E TEAM WILL REVIEW THE VENDOR'S HCD APPROVAL DOCUMENTS, INCLUDING STRUCTURAL AND TITLE 24 CALCULATIONS. VENDORS SHALL NOT SUBMIT DOCUMENTS TO HCD PRIOR TO A/E TEAM AND COUNTY APPROVAL. ASSUME THE A/E TEAM REVIEW WILL BE COMPLETED IN ONE WEEK, AND THAT APPROVALS DO NOT SHIFT DESIGN RESPONSIBILITY TO THE A/E TEAM.
- 5. EACH MODULE DELIVERED TO THE JOB SITE SHALL HAVE A LABEL VERIFYING THE CONSTRUCTION OF THE MODULE. LABEL SHALL CONTAIN THE MANUFACTURER'S IDENTIFICATION, THE MODEL NUMBER, A SERIAL NUMBER OR OTHER DEFINITIVE IDENTIFICATION OF EACH UNIQUE ASSEMBLY, AND THE APPROVED AGENCY'S IDENTIFICATION.

#### SYMBOL I

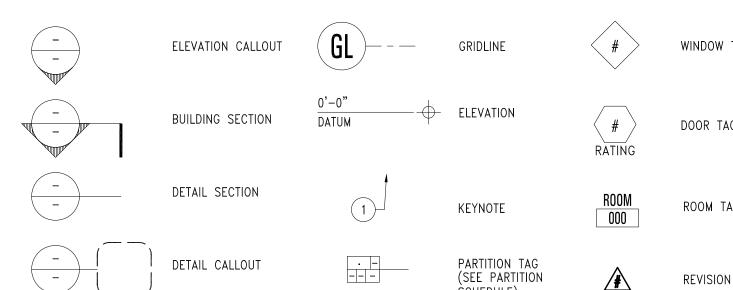

#### PLANNING INFORMATION

APN: 116-01-013

ADDRESS: 1237 SAN ANTONIO ROAD

ZONING: PF (D)

CURRENT USE:

PROPOSED USE:

CONSTRUCTION STORAGE, CONSTRUCTION WASTE SORTING (GREENWASTE)

HOMELESS SERVICES AND TEMPORARY HOUSING, CONSTRUCTION WASTE SORTING (GREENWASTE)

PARKING:

NOTE: SUPPORTIVE INTERIM HOUSING IS NOT INCLUDED AMONG THE USES SCHEDULED IN PALO ALTO PLANNING CODE REQUIREMENTS FOR OFF-STREET PARKING, LOADING, AND BICYCLE PARKING.

QUANTITIES PROVIDED ARE BASED ON PRECEDENT PROJECTS AND INFORMATION PROVIDED BY THE FACILITY OPERATOR.

TOTAL PARKING STALLS

ACCESSIBLE VAN STALLS

2

ACCESSIBLE VAN STALLS
TOTAL ACCESSIBLE STALLS
ELECTRIC VEHICLE CHARGING STATIONS
LOADING SPACES
BICYCLE PARKING SPACES
64

#### **BUILDING CODE INFORMATION**

WORK SHALL COMPLY WITH THE PROVISIONS OF APPLICABLE CODES AND ORDINANCES GOVERNING WORK IN THE STATE OF CALIFORNIA. THE DESIGN FOR THE PROPOSED WORK IS BASED ON THE FOLLOWING CODES:

2019 CALIFORNIA BUILDING CODE (CBC), PART 2, TITLE 24, C.C.R.

CIVIL ENGINEERING, MECHANICAL, ELECTRICAL, PLUMBING, AND FIRE PROTECTION WILL BE PROVIDED BY THE OWNER'S ENGINEERING CONSULTANTS AS DEFERRED SUBMITTALS. DESIGNS WILL BE BASED ON THE FOLLOWING CODES:

- 2019 CALIFORNIA ELECTRICAL CODE, PART 3, TITLE 24, C.C.R. 2019 CALIFORNIA MECHANICAL CODE, PART 4, TITLE 24, C.C.R.
- 2019 CALIFORNIA MECHANICAL CODE, PART 4, TITLE 24, C.C.R.
  2019 CALIFORNIA PLUMBING CODE, PART 5, TITLE 24, C.C.R.
- 2019 CALIFORNIA ENERGY CODE, PART 6, TITLE 24, C.C.R. 2019 CALIFORNIA FIRE CODE, PART 9, TITLE 24, C.C.R.
- 2016 NFPA 13 (FIRE SPRINKLERS) 2016 NFPA 72 (FIRE ALARM)

CONSTRUCTION TYPE: TYPE V-B

OCCUPANCY:

PRESENT OCCUPANCY: S-2
PROPOSED OCCUPANCIES: R-2, B, S-2, A-2

PROJECT AREA: 18,625 SF (COMBINED BUILDING FOOTPRINT)

30,185 SF (GROSS FLOOR AREA) 59,609 SF (HOMEKEY LEASED AREA)

114,410 SF (TOTAL PARCEL AREA)

SLEEPING UNITS: 2 STORIES 23

BUILDING HEIGHT:

SLEEPING UNITS:

COMMUNITY BUILDING & DINING HALL:

MODULAR SUPPORT BUILDINGS:

1 STORY 12'

ELEVATORS:


2 STORIES 23'

1 STORY 12'


FIRE SPRINKLERS:

AUTOMATIC SPRINKLER SYSTEM WILL BE PROVIDED IN ALL BUILDINGS (NFPA 13)

1237 SAN ANTONIO ROAD

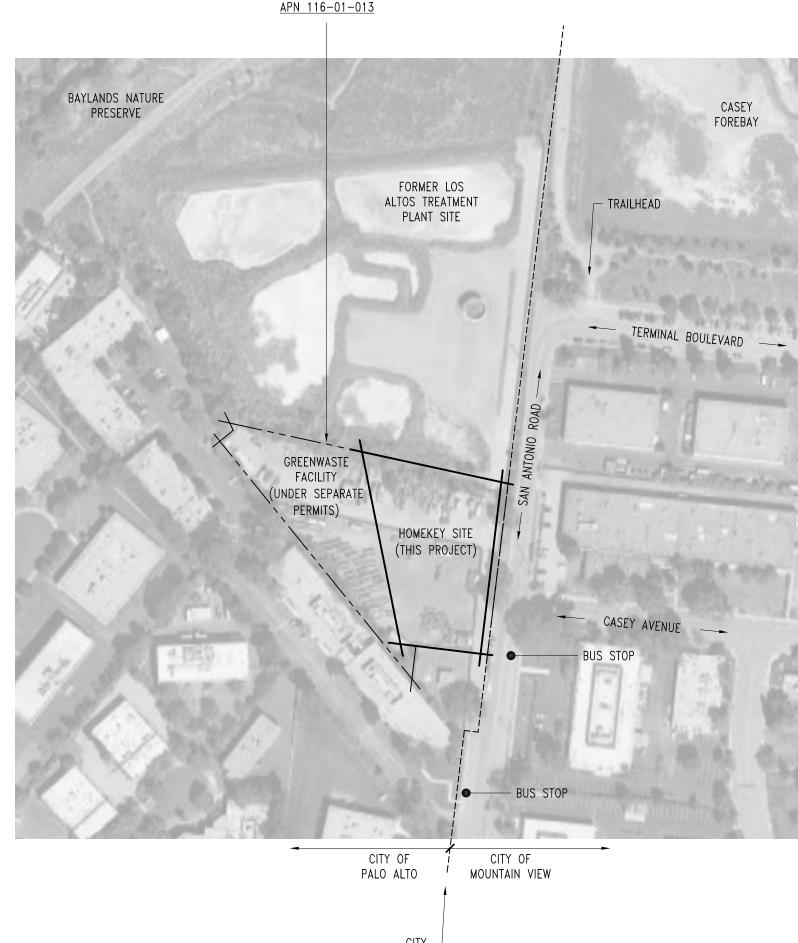

PLOT PLAN
1:2000

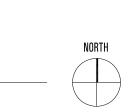

21016.00


THE OFFICE OF

CHARLES F.

BLOSZIES FAIA

ARCHITECTURE I STRUCTURES

Three Embarcadero Center Promenade Level, Suite P2 San Francisco, CA 94111 www.archengine.com 415.834.9002

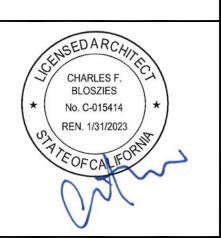

HOMEKEY Palo Alto
Supportive Interim Housing

1237 San Antonio Road Palo Alto, California

Graphic and written material appearing on this sheet constitutes original and unpublished work of the Architect. Copyright of this material is owned by the Architect and protected by the 1990 Architectural Works Copyright Act. Unauthorized duplication of this material, without written prior consent of the Architect, is prohibited.

File Name: 21016-A0.01 Drawn By: Checked By C  Issues 2  Number Date Description	
Number Date Description	
1 04.04.22 100% SCHEMATIC DESIGN	
2 04.07.22 ARCH REVIEW BOARD SUBMITTAL	


Revisions

Number Date Description

TITLE SHEET

Date: APRIL 07, 2022

A0.0

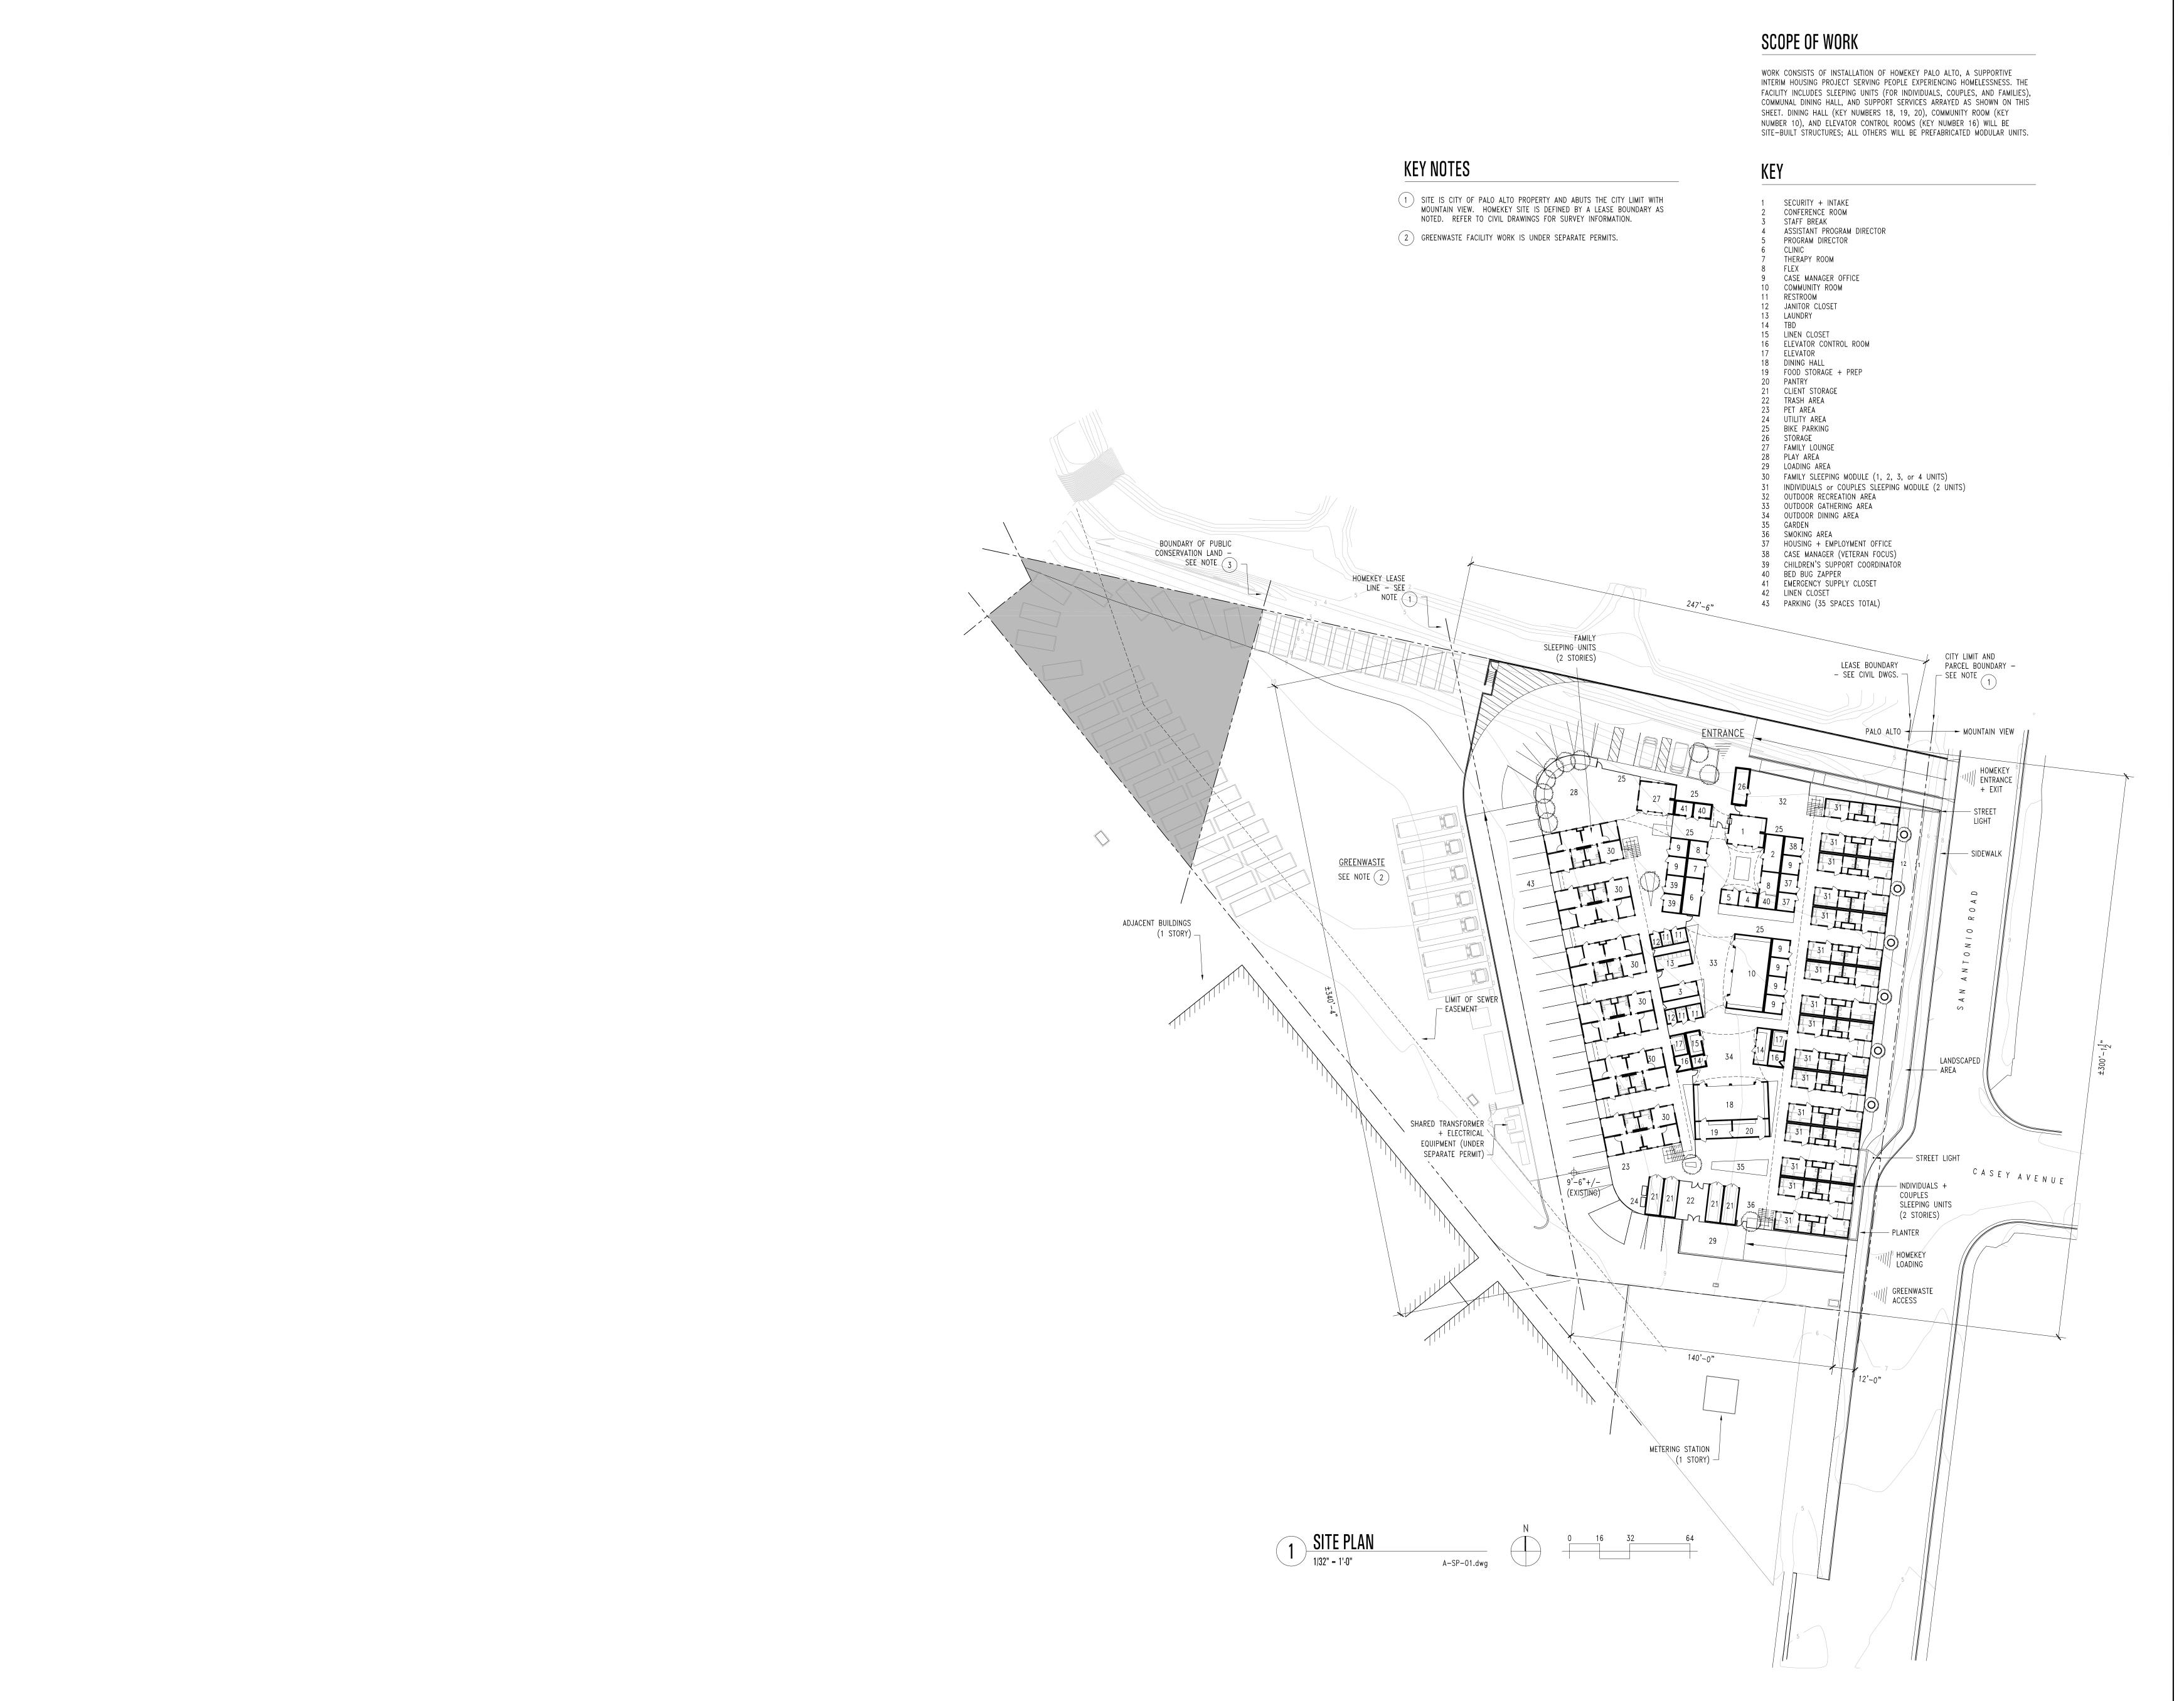

Graphic and written material appearing on this sheet constitutes original and unpublished work of the Architect. Copyright of this material is owned by the Architect and protected by the 1990 Architectural Works Copyright Act. Unauthorized duplication of this material, without written prior consent of the Architect, is prohibited.

21016.00

ARCHITECTURE | STRUCTURES

415.834.9002

CHARLES F.

**BLOSZIES** 

No. C-015414

REN. 1/31/2023

HOMEKEY Palo Alto

Supportive Interim Housing

1237 San Antonio Road

Palo Alto, California

Three Embarcadero Center

Promenade Level, Suite P2 San Francisco, CA 94111 www.archengine.com

THE OFFICE OF

Revisions


SITE PLAN

e: APRIL 07, 2022

AO.11

#### **KEY NOTES**


- 1 REFER TO SURVEY BY BKF ENGINEERS FOR EXACT LOCATION OF THE BOUNDARY LINE BETWEEN GREENWASTE AND HOMEKEY SITES.
- 2 EXISTING GREENWASTE PG&E SERVICE WILL BE TERMINATED ONCE NEW PALO ALTO UTILITY SERVICE HAS BEEN INSTALLED AND CONNECTED TO GREENWASTE EQUIPMENT, MOST LIKELY AFTER THE HOMEKEY SITE HAS COMPLETED ROUGH GRADING. PROTECT EQUIPMENT DURING CONSTRUCTION.
- 3 RELOCATION OF EXISTING GREENWASTE FACILITIES AND INSTALLATION OF NEW EQUIPMENT WILL BE COMPLETED UNDER A SEPARATE PERMIT.
- 4 CLEAR ALL VEGETATION AND DEBRIS EXCEPT AS NOTED TO PREPARE HOMEKEY SITE FOR FILL AND GRADING. REMOVAL OF TREES LARGER THAN 4" IN DIAMETER (SHOWN ON PLAN BELOW) IS SUBJECT TO CITY REVIEW AND SHALL NOT OCCUR WITHOUT NECESSARY APPROVAL FROM LOCAL AGENCIES.

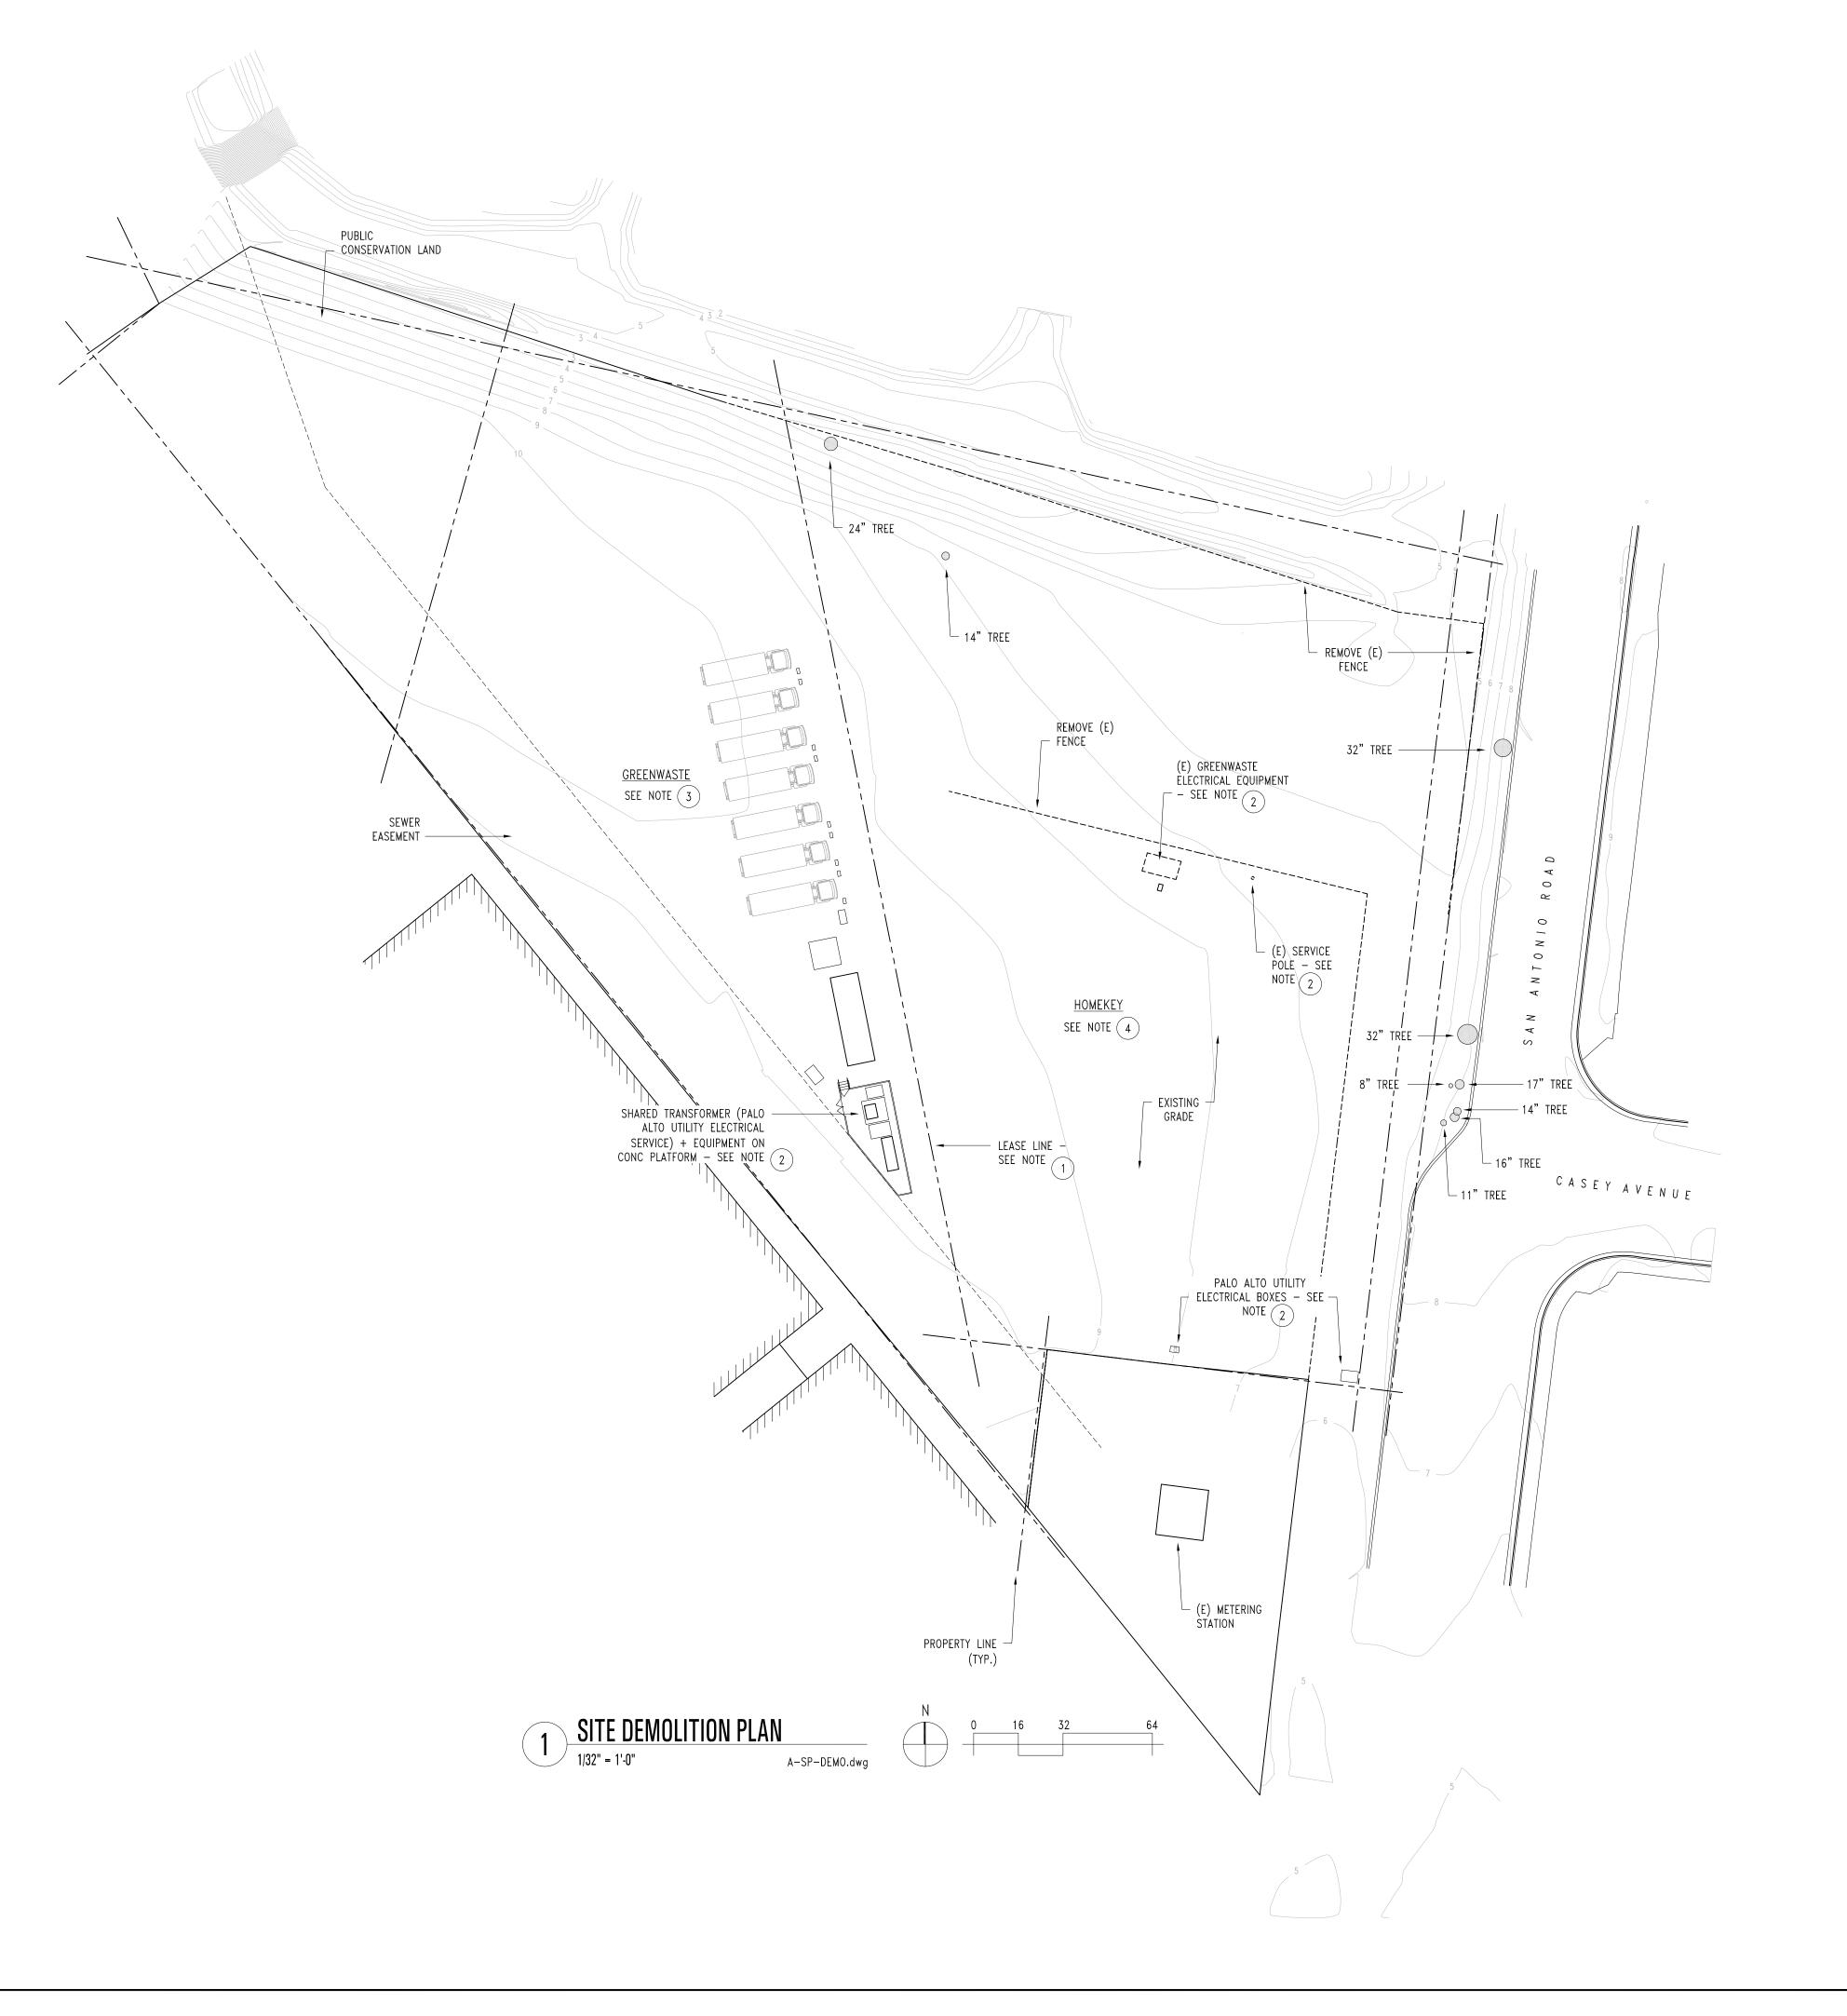

21016.00

THE OFFICE OF

Three Embarcadero Center Promenade Level, Suite P2 San Francisco, CA 94111 www.archengine.com 415.834.9002

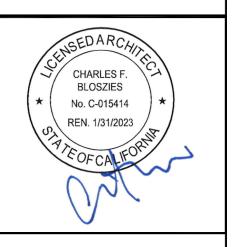


HOMEKEY Palo Alto Supportive Interim Housing

1237 San Antonio Road Palo Alto, California


original materia Archite	and un al is owr ctural W	publisl ned by orks C	material appearing on hed work of the Archite the Architect and pro opyright Act. Unauthor ten prior consent of the A	ct. Copyright of this tected by the 1990 ized duplication of this
File Namo 21016-	-	dwg	Drawn By: MW	Checked By: CB
lss	ues	2		
Number	Date		Description	
1	04.04	1.22	100% SCHEMATIC DE	SIGN
2	04.07	7.22	ARCH REVIEW BOARD	SUBMITTAL
Re	visions		$\triangle$	
Number	Date		Description	

SITE DEMOLITION PLAN


APRIL 07, 2022

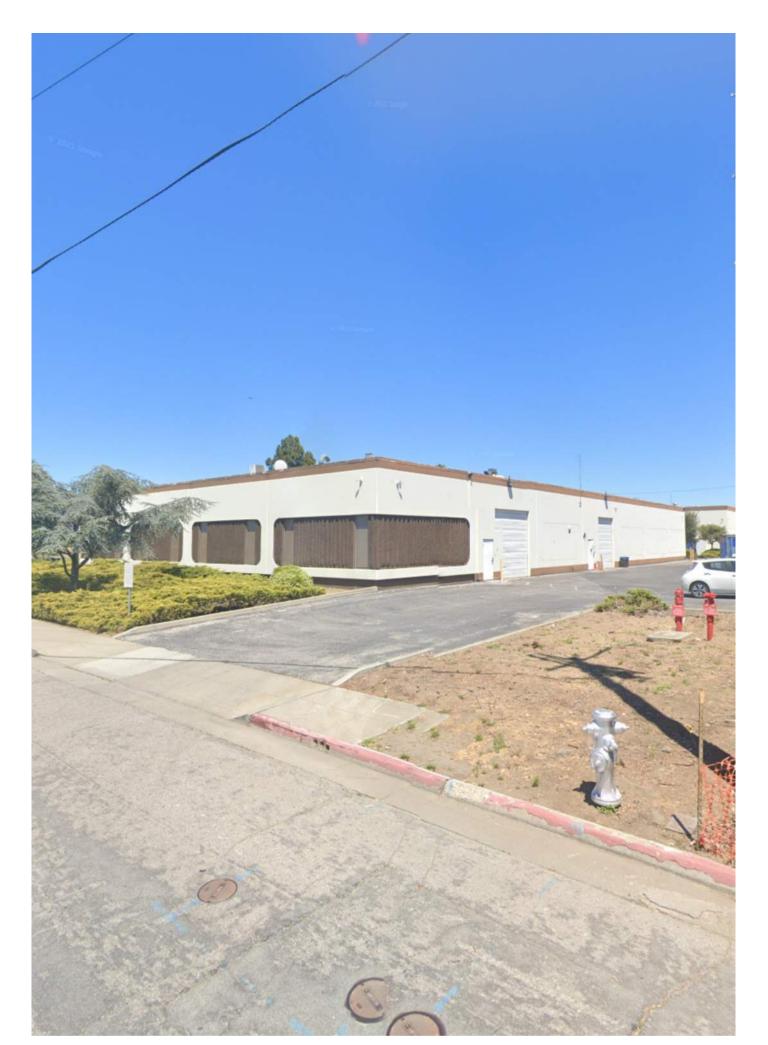

1: 1201 SAN ANTONIO RD, MOUNTAIN VIEW, CA 94043

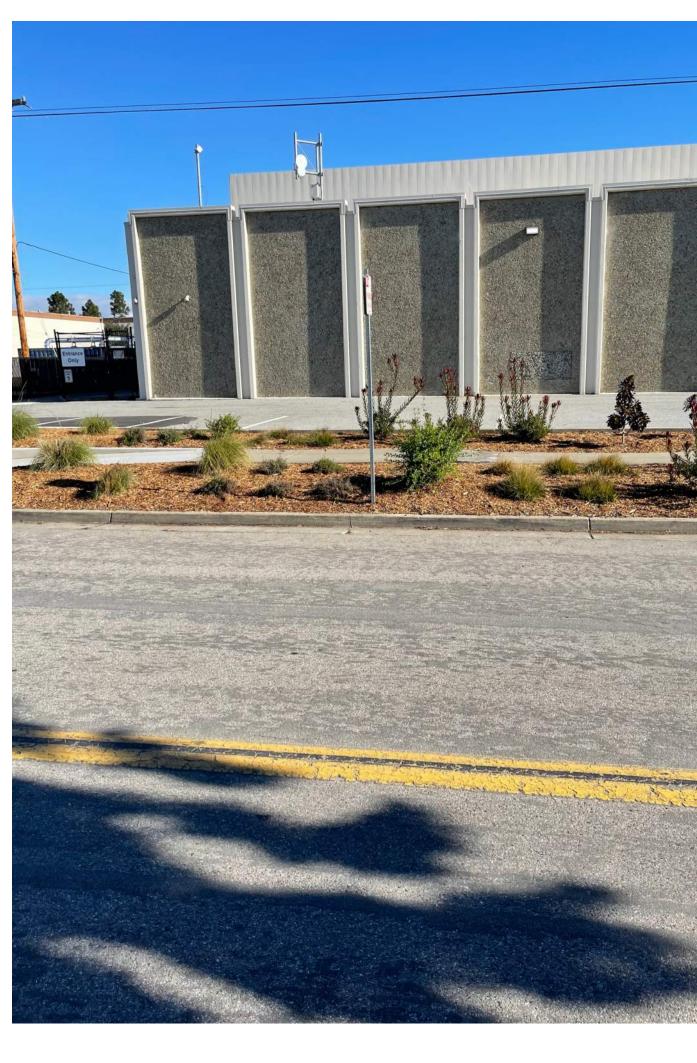

2: 2690 CASEY AVE, MOUNTAIN VIEW, CA 94043

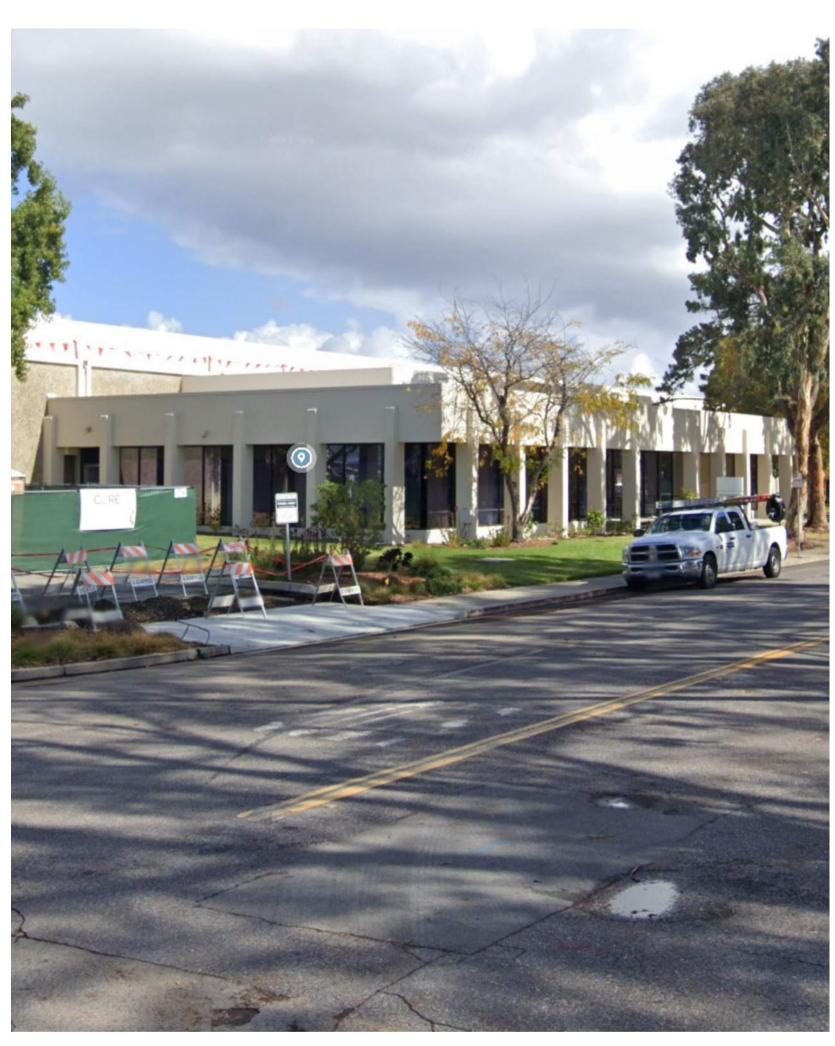

3: 2690 CASEY AVE, MOUNTAIN VIEW, CA 94043



4: 1161 SAN ANTONIO RD, MOUNTAIN VIEW, CA 94043


1237 SAN ANTONIO ROAD APN 116-01-013



5: 1129 SAN ANTONIO RD, PALO ALTO, CA 94303



6: 1157 SAN ANTONIO RD, MOUNTAIN VIEW, CA 94043

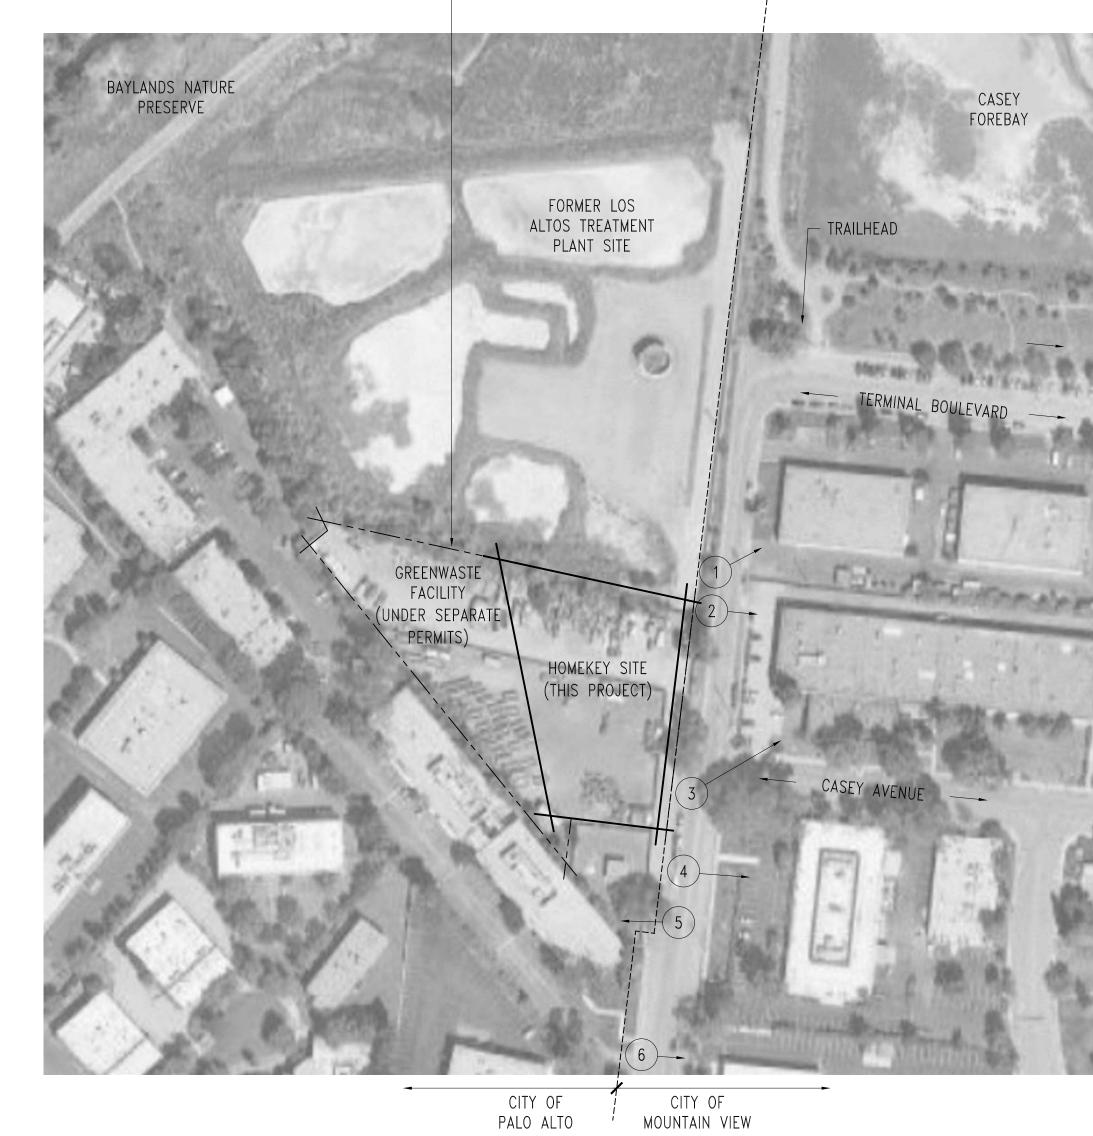

CITY OF PALO ALTO

CITY BOUNDARY —

21016.00

THE OFFICE OF

CHARLES F.

BLOSZIES FAIA
LTD

ARCHITECTURE STRUCTURES

Three Embarcadero Center Promenade Level, Suite P2 San Francisco, CA 94111 www.archengine.com 415.834.9002



HOMEKEY Palo Alto Supportive Interim Housing

1237 San Antonio Road Palo Alto, California


Graphic and written material appearing on this sheet constitutes original and unpublished work of the Architect. Copyright of this material is owned by the Architect and protected by the 1990 Architectural Works Copyright Act. Unauthorized duplication of this material, without written prior consent of the Architect, is prohibited.


lss	ues	2	
Number	Date		Description
2	04.07	7.22	ARCH REVIEW BOARD SUBMITTAL
Re	visions	5 _	
Number	Date		Description


SITE CONTEXT PHOTOS

APRIL 07, 2022


A1.00

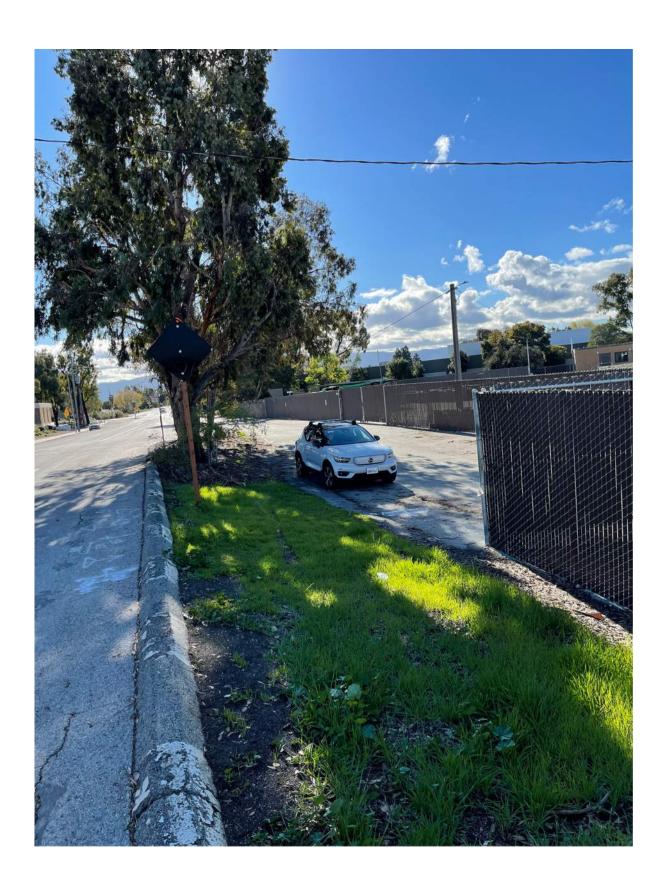


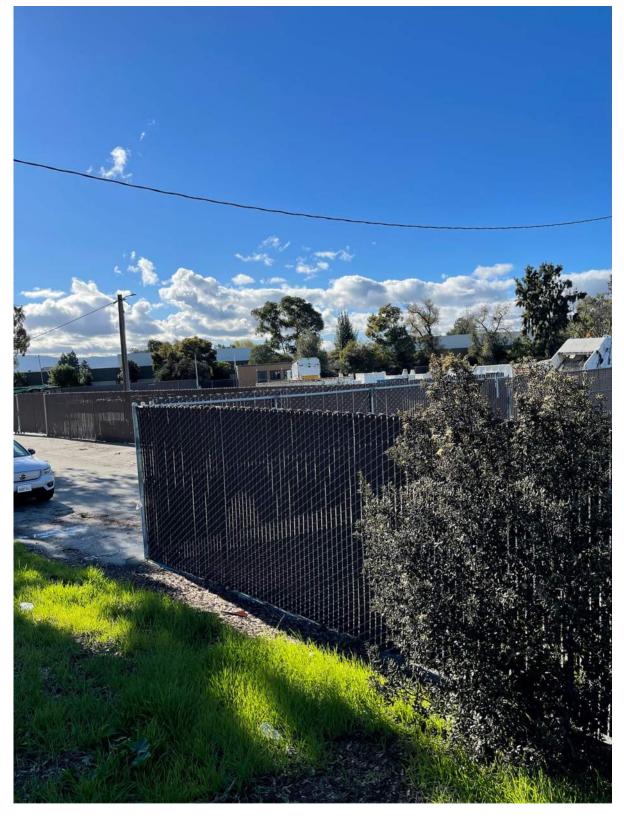


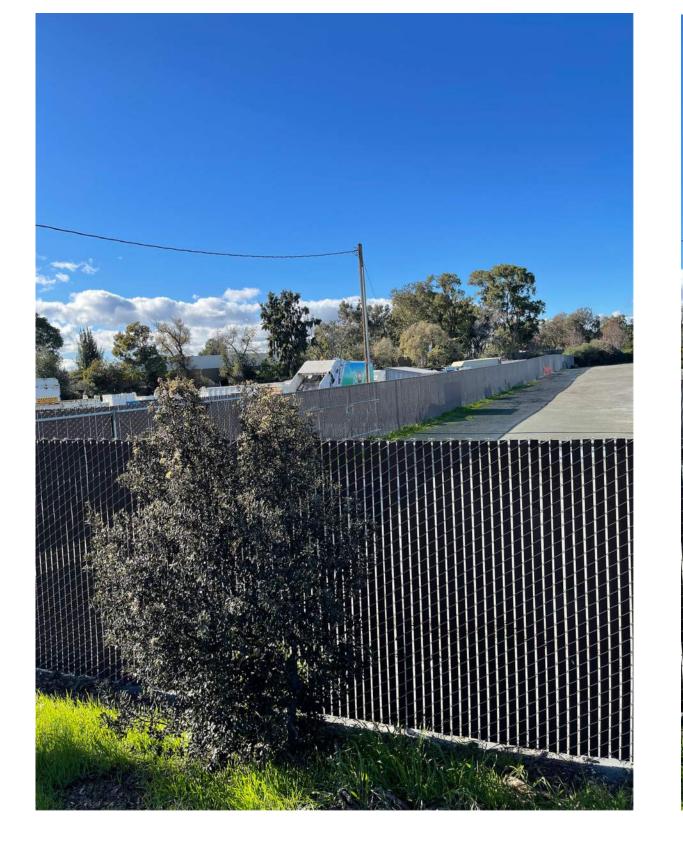



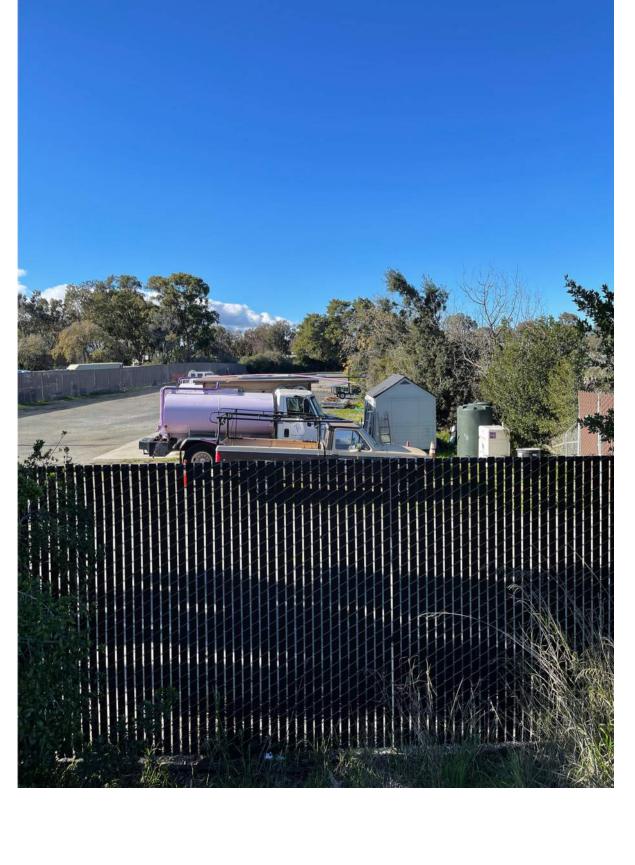

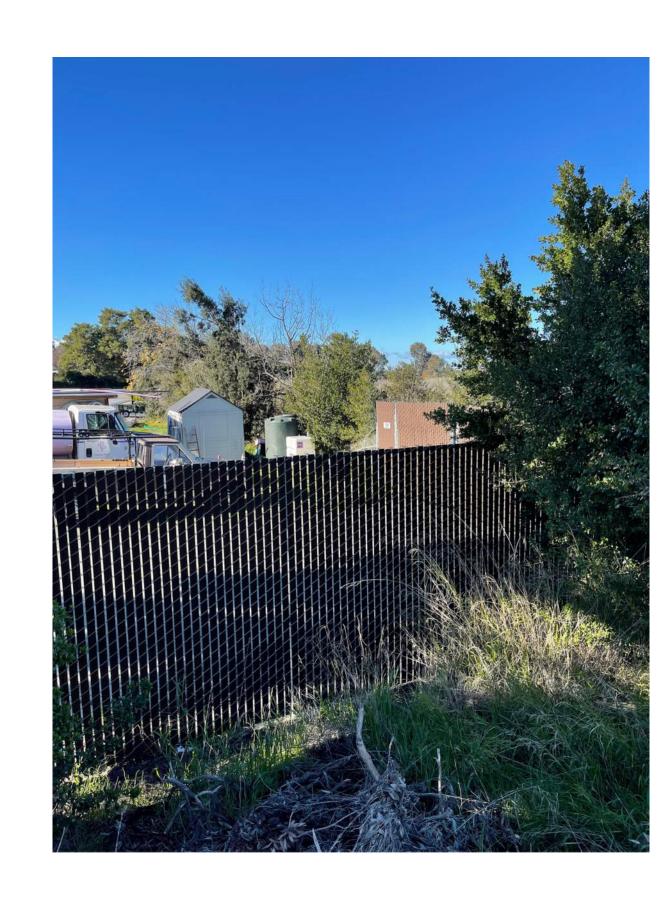

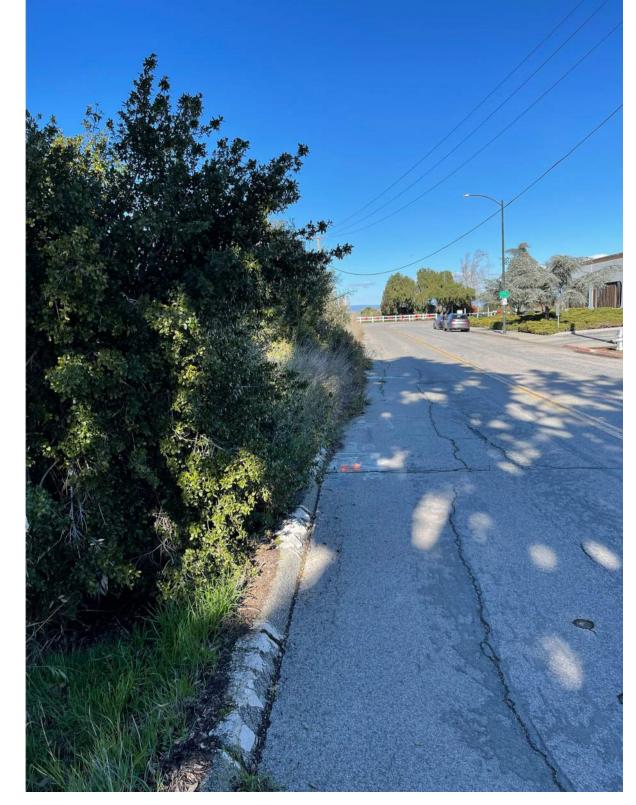














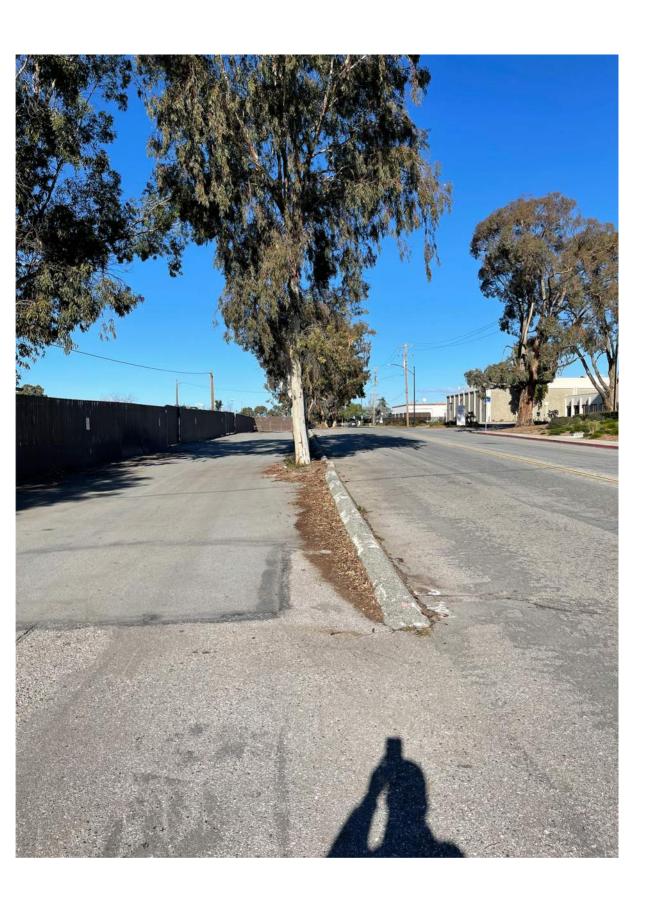

21016.00

THE OFFICE OF

CHARLES F.

BLOSZIES FAIA
LTD

ARCHITECTURE STRUCTURES

Three Embarcadero Center Promenade Level, Suite P2 San Francisco, CA 94111 www.archengine.com 415.834.9002



HOMEKEY Palo Alto Supportive Interim Housing


1237 San Antonio Road Palo Alto, California

Graphic and written material appearing on this sheet constitutes original and unpublished work of the Architect. Copyright of this material is owned by the Architect and protected by the 1990 Architectural Works Copyright Act. Unauthorized duplication of this material, without written prior consent of the Architect, is prohibited.


2 04.07.22 ARCH REVIEW BOARD SUBMITTAL

SITE PHOTOS


APRIL 07, 2022

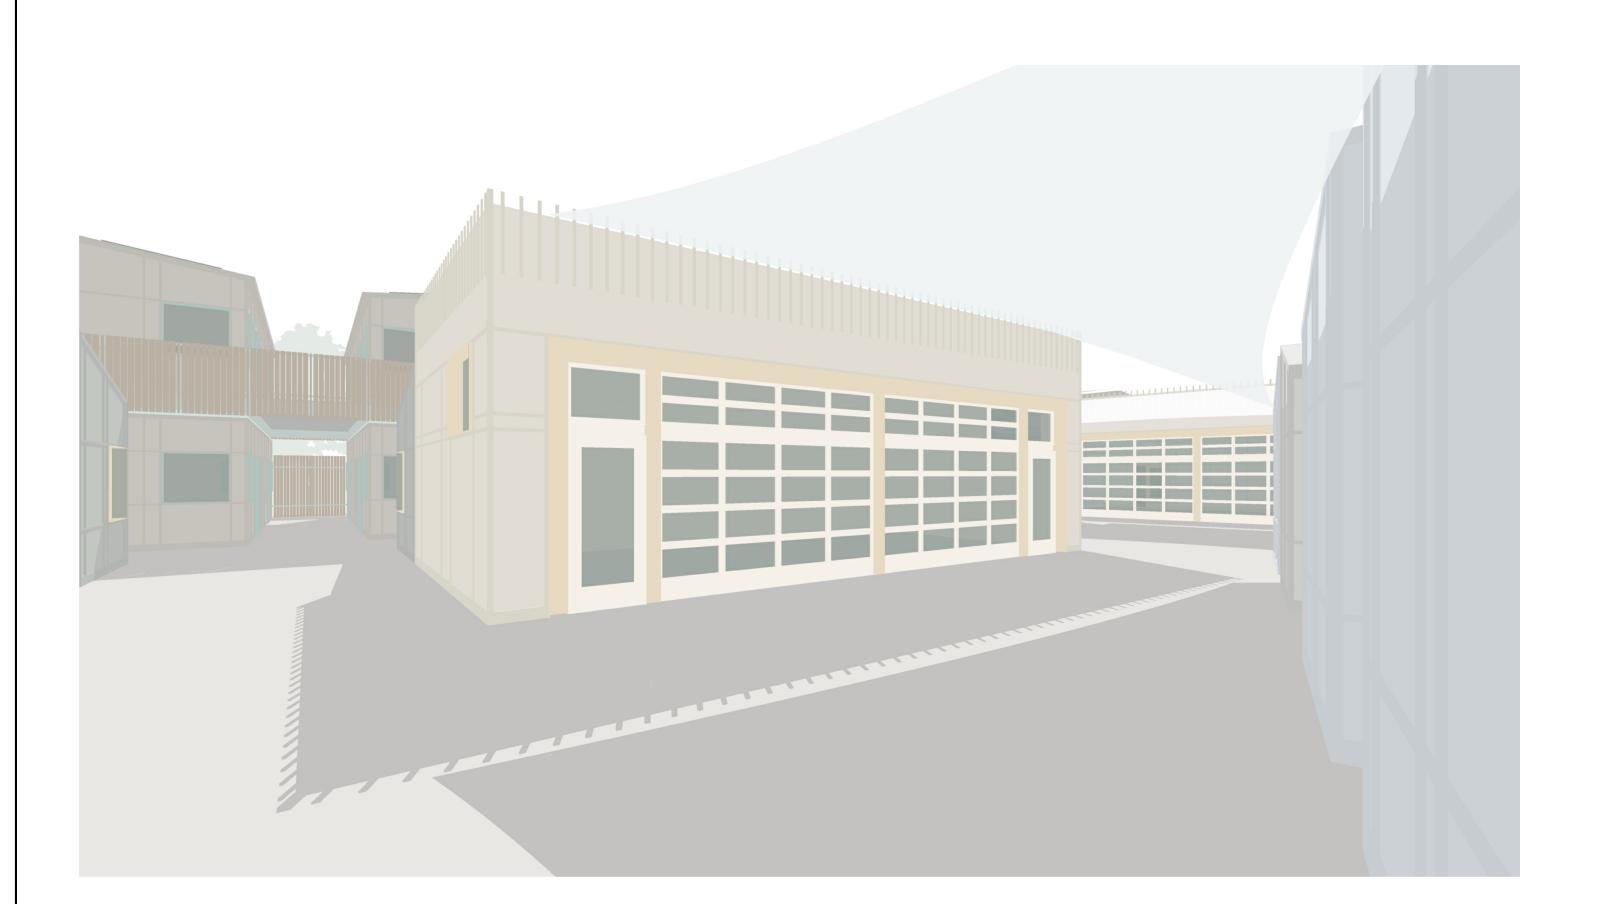

4 INTERIOR COURTYARD VIEW

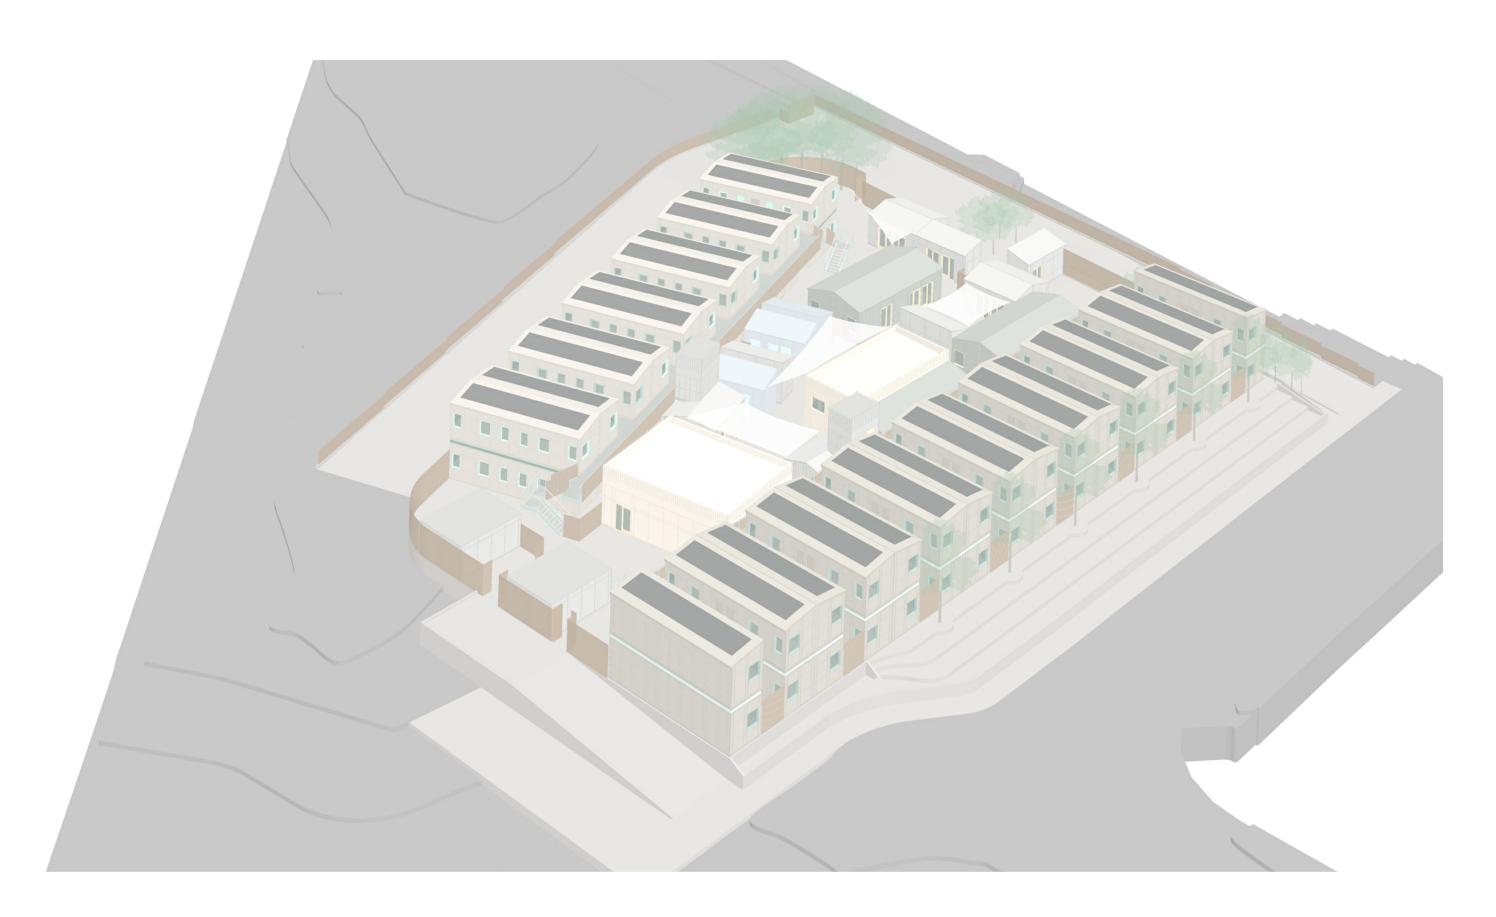

2 AERIAL VIEW

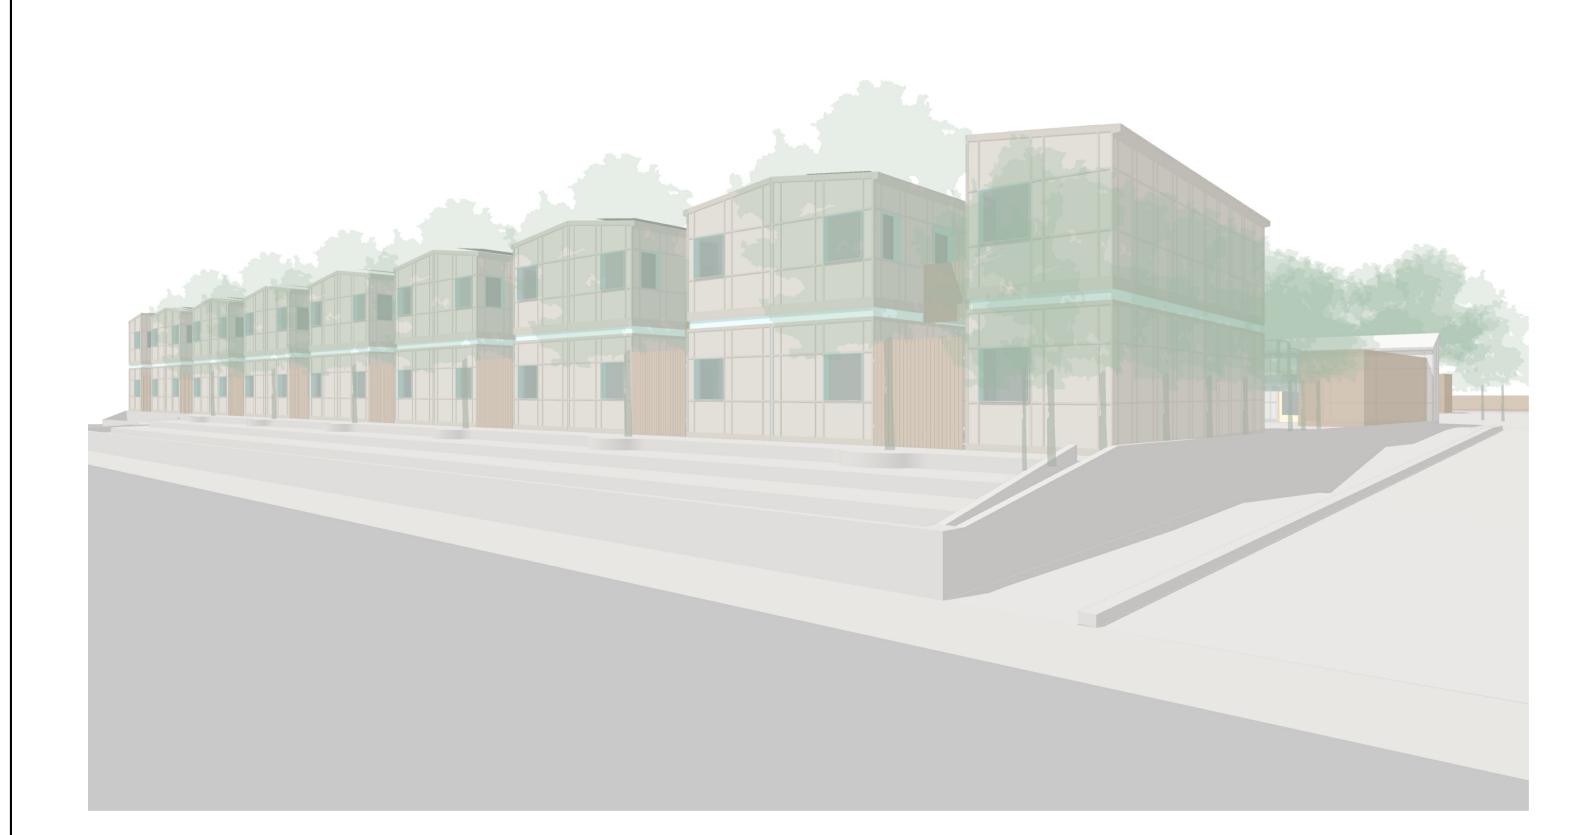

3 SAN ANTONIO ROAD VIEW



1 AERIAL VIEW

Project Number 21016.00


THE OFFICE OF

CHARLES F.

BLOSZIES FAIA
LTD

ARCHITECTURE | STRUCTURES

Three Embarcadero Center Promenade Level, Suite P2 San Francisco, CA 94111 www.archengine.com 415.834.9002

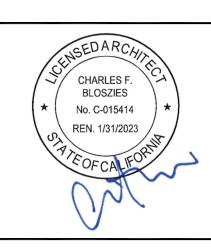

HOMEKEY Palo Alto
Supportive Interim Housing

1237 San Antonio Road Palo Alto, California

Graphic and written material appearing on this sheet constitutes original and unpublished work of the Architect. Copyright of this material is owned by the Architect and protected by the 1990 Architectural Works Copyright Act. Unauthorized duplication of this material, without written prior consent of the Architect, is prohibited.

Archit	ectural Work	s Copyright Act. Una	nd protected by the 1 authorized duplication of f the Architect, is prohib
File Nan 21016	ne: —A1.02.dw	Drawn By:	Checked By: CB
ls	sues [	2	
Number	Date	Description	
2	04.07.2	ARCH REVIEW B	OARD SUBMITTAL
I		$\wedge$	

Number Date Description

3D VIEWS

Date: APRIL 07, 2022

۸1 በ2

2 ENLARGED STREET ELEVATION
VIEW FROM SAN ANTONIO ROAD PROPOSED SITE CONTEXT ELEVATION
VIEW FROM SAN ANTONIO ROAD

21016.00


THE OFFICE OF

CHARLES F.

BLOSZIES FAIA
LTD

ARCHITECTURE | STRUCTURES

Three Embarcadero Center Promenade Level, Suite P2 San Francisco, CA 94111 www.archengine.com 415.834.9002

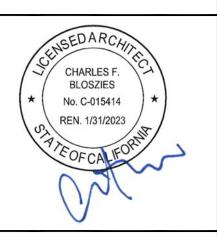

HOMEKEY Palo Alto Supportive Interim Housing

1237 San Antonio Road Palo Alto, California

Graphic and written material appearing on this sheet constitutes original and unpublished work of the Architect. Copyright of this material is owned by the Architect and protected by the 1990 Architectural Works Copyright Act. Unauthorized duplication of this material, without written prior consent of the Architect, is prohibited.

File Name: Drawn By: Checked By: 21016-A1.03.dwg MLP CB Issues 2 Number Date Description 04.04.22 100% SCHEMATIC DESIGN 04.07.22 ARCH REVIEW BOARD SUBMITTAL

Revisions Number Date Description

SITE CONTEXT ELEVATIONS

APRIL 07, 2022

A1.03



PREFABRICATED MODULE SCHEDULE

TOILETS

LAUNDRY

ELEVATOR

SLEEPING MODULE

w/ BATHROOM

STAFF RESTROOMS +

LAUNDRY ROOM

JANITOR

INTAKE + SECURITY

CONFERENCE

20' OFFICE MODULE

40' OFFICE

SPT-6

SPT-8

CLINIC + THERAPY ROOM + FLEX

STAFF BREAK

USE TBD

BEDBUG ZAPPER + EMERGENCY SUPPLY CLOSET

FAMILY LOUNGE 1

ROOM + IT CLOSET + FLEX

SL-FAM-W FAMILY SLEEPING 1
MODULE ("WET"

Project Number

21016.00


THE OFFICE OF

CHARLES F.

BLOSZIES FAIA

ARCHITECTURE | STRUCTURES

Three Embarcadero Center Promenade Level, Suite P2 San Francisco, CA 94111 www.archengine.com 415.834.9002

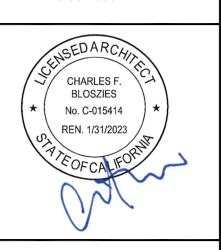

HOMEKEY Palo Alto
Supportive Interim Housing

1237 San Antonio Road Palo Alto, California

Graphic and written material appearing on this sheet constitutes original and unpublished work of the Architect. Copyright of this material is owned by the Architect and protected by the 1990 Architectural Works Copyright Act. Unauthorized duplication of this material, without written prior consent of the Architect, is prohibited.


File Name		Drawn By:	Checked By:
21016-	A2.11.dwg	MW	СВ
lss	ues 2		
Number	Date	Description	
1	04.04.22	100% SCHEMATIC DE	SIGN
2	04.07.22	ARCH REVIEW BOARD	SUBMITTAL
Ro	visions /	$\overline{\wedge}$	

GROUND LEVEL PLAN

APRIL 07, 2022

A2.11

- 1. REFER TO SHEET A2.31 FOR ROOF PLAN AND NOTES.
- DECK WILL BE BUILT ON SITE OR PREFABRICATED AS PANELS TO BE FIELD-INSTALLED. DECK WILL BE SUPPORTED BY STRUCTURE ATTACHED TO PREFABRICATED MODULES PROVIDED BY MODULE VENDOR. SEE SHEET S2.22 FOR FRAMING PLANS.

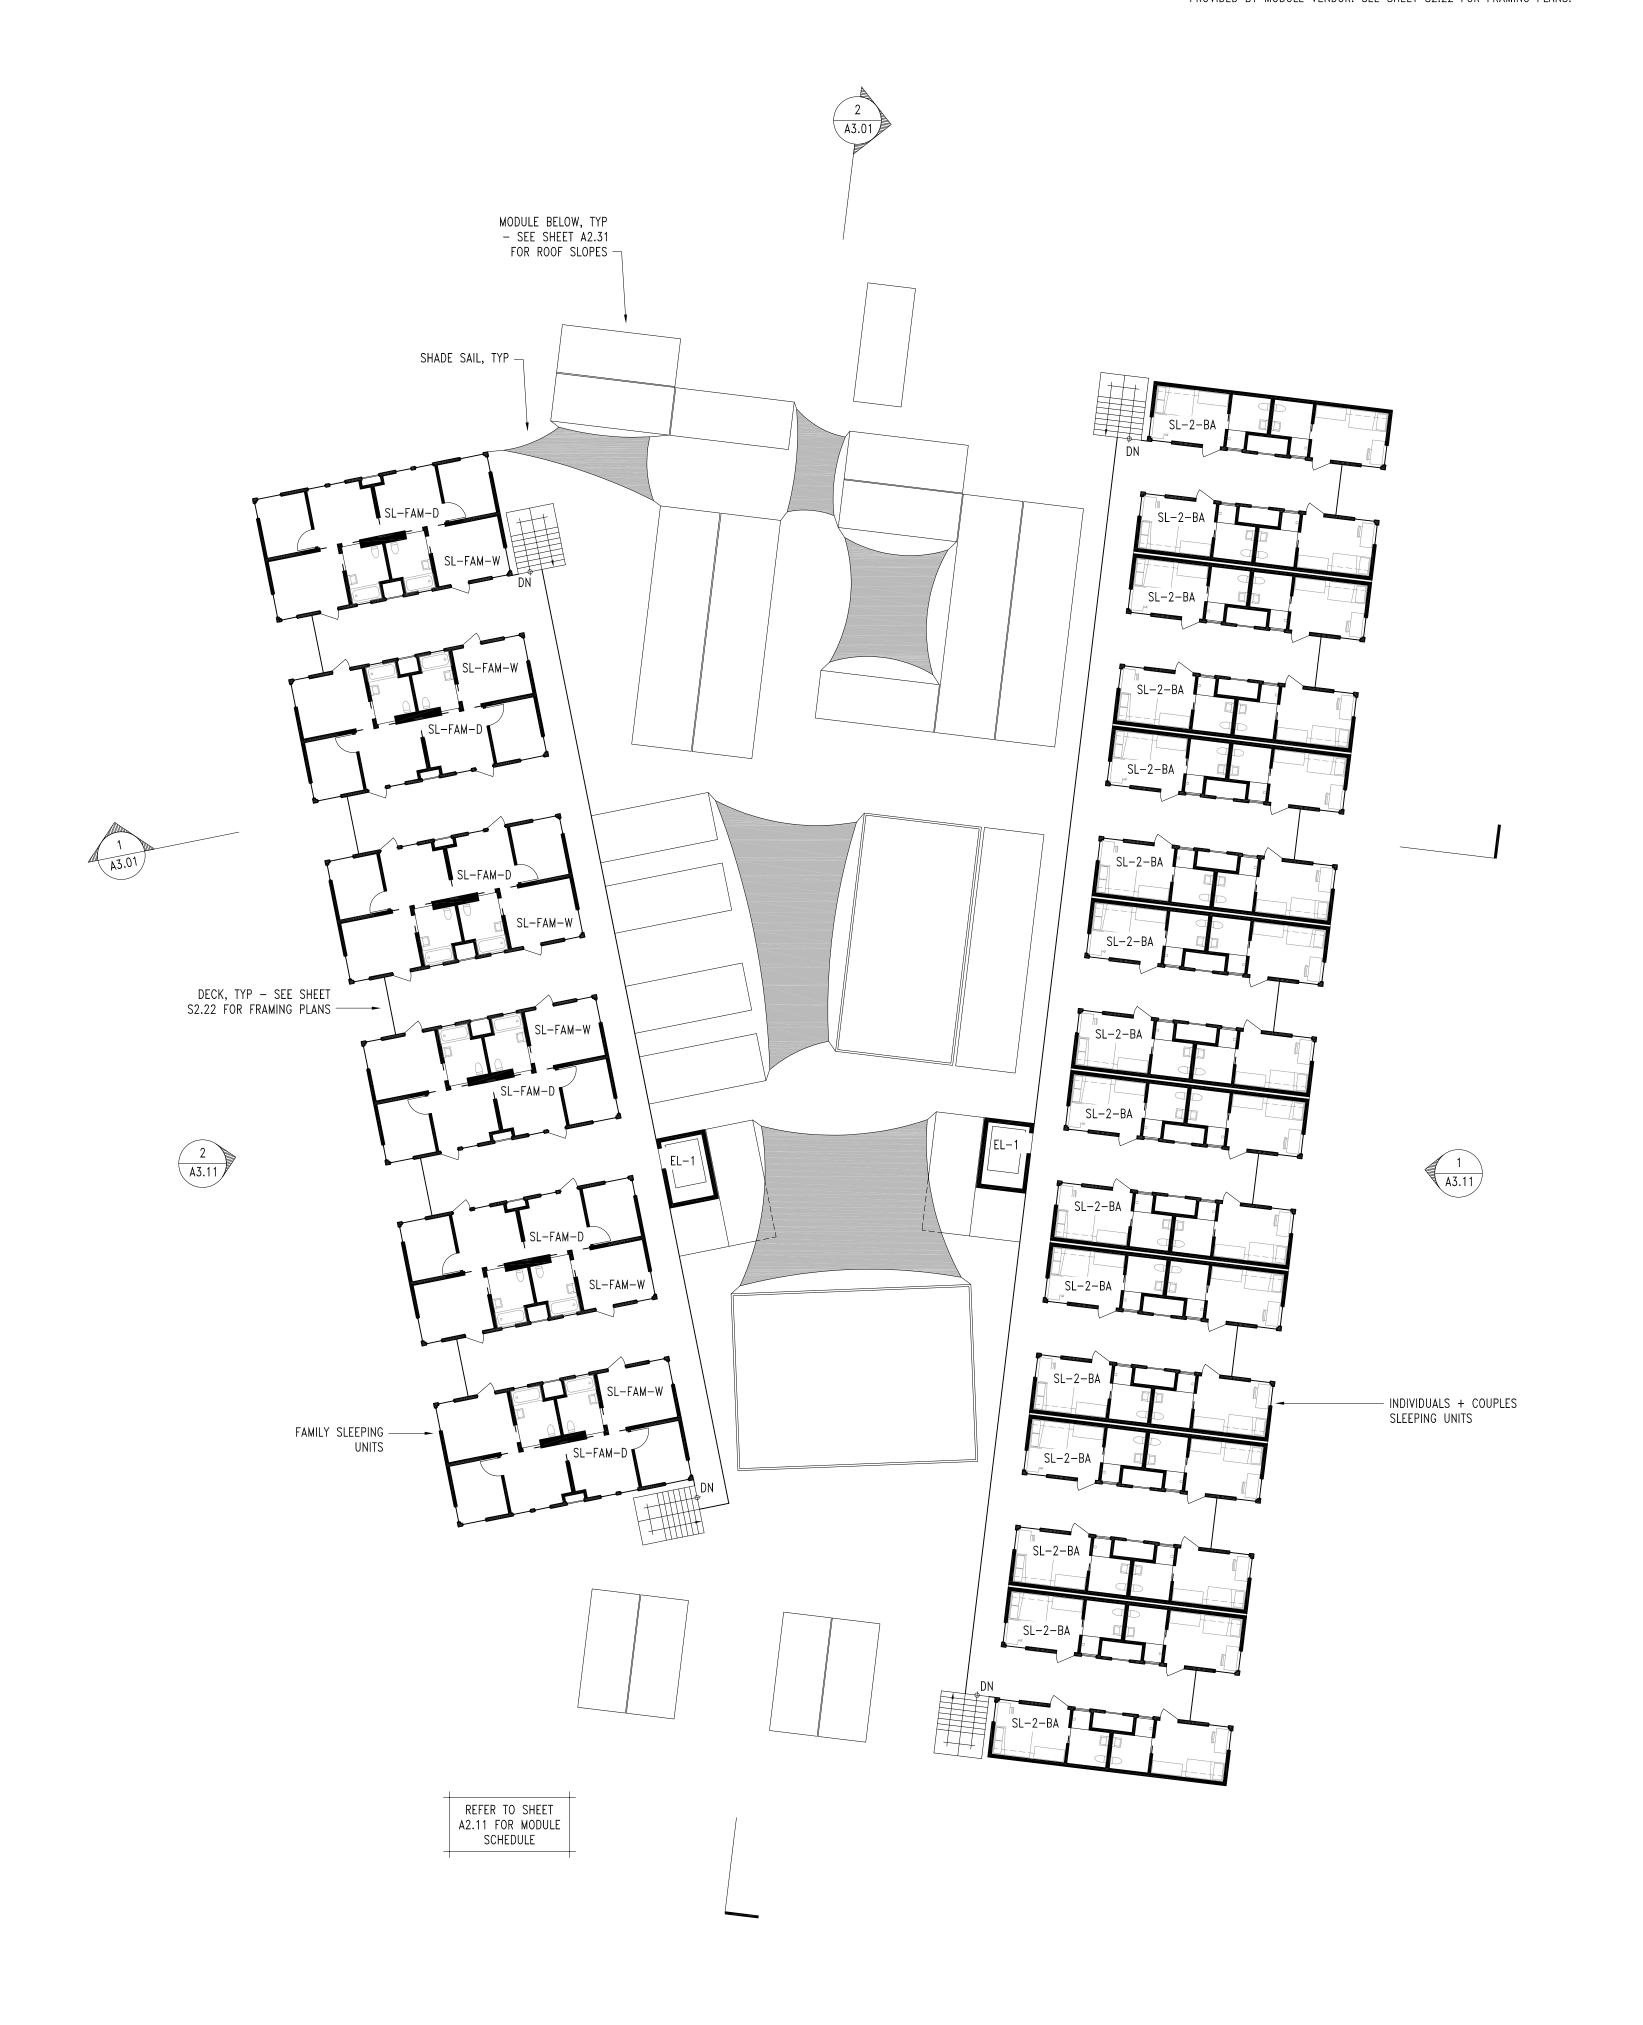

SECOND FLOOR PLAN

1/16" = 1'-0"

A-FP-02.dwg

Project Number

21016.00


THE OFFICE OF

CHARLES F.

BLOSZIES FAIA

ARCHITECTURE | STRUCTURES

Three Embarcadero Center Promenade Level, Suite P2 San Francisco, CA 94111 www.archengine.com 415.834.9002

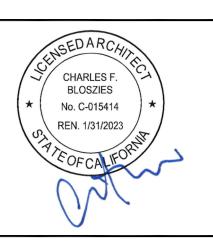

HOMEKEY Palo Alto
Supportive Interim Housing

1237 San Antonio Road Palo Alto, California

Graphic and written material appearing on this sheet constitutes original and unpublished work of the Architect. Copyright of this material is owned by the Architect and protected by the 1990 Architectural Works Copyright Act. Unauthorized duplication of this material, without written prior consent of the Architect, is prohibited.

File Name 21016-	e: -A2.21.dwg	Drawn By: MW	Checked By: CB
lss	ues 2		
Number	Date	Description	
1	04.04.22	100% SCHEMATIC DE	SIGN
2	04.07.22	ARCH REVIEW BOARD	SUBMITTAL
Re	visions _		
Number	Date	Description	

SECOND LEVEL PLAN

APRIL 07, 2022


A2.21

# **GENERAL NOTES** GUTTERS AND DOWNSPOUTS SHALL BE INSTALLED IN THE FIELD AFTER DELIVERY AND PLACEMENT OF PREFABRICATED MODULES. 2. COORDINATE DRAINAGE WITH SITE STORMWATER DESIGN - SEE CIVIL DRAWINGS. 3. ROOF SLOPES: SLEEPING UNITS OTHER MODULES EXCEPT ST-1 3/12 ELEVATOR CONTROL RM COMMUNITY BUILDING DINING HALL ST-1 STORAGE MODULES 1.5/12 3/12 SEE A5.01 SEE A5.01 ST-1 STORAGE MODULES NONE (EXISTING SHIPPING CONTAINER ROOF) SHADE SAIL BELOW, TYP $\neg$ ROOF OF MODULE BELOW, TYP PHOTOVOLTAIC ARRAY, TYP — FAMILY SLEEPING UNITS (2 STORIES) — -SL SL INDIVIDUALS + COUPLES SLEEPING UNITS (2 STORIES) DECK, TYP - SEE SHEET S2.22 FOR FRAMING PLANS ---2 A3.11 1 ROOF PLAN 1/16" = 1'-0" A-FP-R.dwg

21016.00

THE OFFICE OF

Three Embarcadero Center Promenade Level, Suite P2 San Francisco, CA 94111 www.archengine.com 415.834.9002

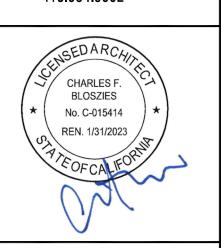

HOMEKEY Palo Alto Supportive Interim Housing

1237 San Antonio Road Palo Alto, California

original materia Archite	and un I is owr ctural W	publisl ed by orks C	material appearing on hed work of the Archite the Architect and pro opyright Act. Unauthori ten prior consent of the A	ct. Copyright of this tected by the 1990 zed duplication of this	
File Name: 21016-A2.31.dwg			Drawn By: MW	Checked By: CB	
lss	ues	2			
Number	Date		Description		
1	04.04	1.22	100% SCHEMATIC DE	SIGN	
2	04.07	.22	ARCH REVIEW BOARD SUBMITTAL		
Rev	visions	5 _			
Number	Date		Description		
				_	

ROOF PLAN

Date: APRIL 07, 2022



t Number **21016.00** 


THE OFFICE OF

CHARLES F.

BLOSZIES FAIA
LTD

ARCHITECTURE | STRUCTURES

Three Embarcadero Center Promenade Level, Suite P2 San Francisco, CA 94111 www.archengine.com 415.834.9002

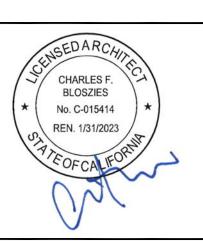

HOMEKEY Palo Alto
Supportive Interim Housing

1237 San Antonio Road Palo Alto, California

Graphic and written material appearing on this sheet constitutes original and unpublished work of the Architect. Copyright of this material is owned by the Architect and protected by the 1990 Architectural Works Copyright Act. Unauthorized duplication of this material, without written prior consent of the Architect, is prohibited.

File Name 21016-	e: -A3.01.dwg	Drawn By: AA	Checked By: CB
Iss	ues 2		
Number	Date	Description	
1	04.04.22	100% SCHEMATIC	DESIGN
2	04.07.22	ARCH REVIEW BOAI	RD SUBMITTAL
		^	
	visions _		
Number	Date	Description	

SITE SECTIONS

APRIL 07, 2022

43.01







A-EE-SITE.dwg

21016.00

THE OFFICE OF

CHARLES F.

BLOSZIES FAIA
LTD

ARCHITECTURE | STRUCTURES

Three Embarcadero Center Promenade Level, Suite P2 San Francisco, CA 94111 www.archengine.com 415.834.9002



HOMEKEY Palo Alto Supportive Interim Housing

1237 San Antonio Road Palo Alto, California

original materia Archite	and unpublisl Il is owned by ctural Works C	hed work of the Archite the Architect and pro opyright Act. Unauthor	ct. Copyright of thi tected by the 199 ized duplication of thi
		Drawn By: AA	Checked By: CB
lss	ues 2		
Number	Date	Description	
1	04.04.22	100% SCHEMATIC DE	SIGN
2	04.07.22	ARCH REVIEW BOARD	SUBMITTAL
Re	visions _		
Number	Date	Description	
	original materia Archite materia Archite materia  File Name 21016-  ISS  Number  1 2	original and unpublis material is owned by Architectural Works C material, without write  File Name: 21016—A3.11.dwg  Issues 2  Number Date 1 04.04.22 2 04.07.22	Issues 2  Number Date Description  1 04.04.22 100% SCHEMATIC DESCRIPTION 2 04.07.22 ARCH REVIEW BOARD  Revisions

SITE ELEVATIONS

\* APRIL 07, 2022

Project Number

21016.00


THE OFFICE OF

CHARLES

BLOSZIES

ARCHITECTURE I STRUCTU

Three Embarcadero Center Promenade Level, Suite P2 San Francisco, CA 94111 www.archengine.com 415.834.9002

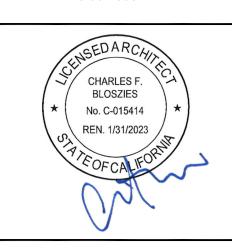

HOMEKEY Palo Alto
Supportive Interim Housing

1237 San Antonio Road Palo Alto, California

Graphic and written material appearing on this sheet constitutes original and unpublished work of the Architect. Copyright of this material is owned by the Architect and protected by the 1990 Architectural Works Copyright Act. Unauthorized duplication of this material, without written prior consent of the Architect, is prohibited.

File Name	):	Drawn By:	Checked By:
21016-	A3.12.dwg	MLP	СВ
lss	ues 2		
Number	Date	Description	
1	04.04.22	100% SCHEMATIC DES	SIGN
2	04.07.22	ARCH REVIEW BOARD	SUBMITTAL

Revisions

Number Date Description

mber Date Description

EXTERIOR MATERIALS

APRIL 07, 2022


A3.12

5 CROSS SECTION THRU BATHROOM

A-DT-SL-2-BA.dwg

- 1. THIS SHEET IS NOT A CONSTRUCTION DOCUMENT. IT IS INTENDED TO CONVEY THE OWNER'S PROGRAMMATIC REQUIREMENTS FOR USE BY THE DESIGNERS OF THE MODULAR UNITS SHOWN ON THE OVERALL SITE PLANS.
- 2. SLEEPING MODULES SHALL BE CERTIFIED BY THE CALIFORNIA DEPARTMENT OF HOUSING AND COMMUNITY DEVELOPMENT (HCD) AS "FACTORY-BUILT" HOUSING UNITS.
- 3. ALL MECHANICAL COMPONENTS WILL BE PROVIDED IN MODULE DELIVERED BY MANUFACTURER.
- A. EACH SLEEPING UNIT WILL BE EQUIPPED WITH THE EPHOCA HPAC 2.0 UNIT WITH INTEGRATED FAN COIL UNIT MOUNTED TO THE WALL SUCH THAT THE EXTERIOR VENT PIPE HOLE CONFIGURATION SHOWN IN THE ELEVATIONS CAN BE ACHIEVED. SEE 4.11B.
- B. EACH SLEEPING UNIT WILL BE EQUIPPED WITH THE PANASONIC INTELLI-BALANCE 100 FV-10VE2 ERV, MOUNTED IN THE BATHROOM CEILING SUCH THAT THE INTERIOR/EXTERIOR EXHAUST/SUPPLY GRILLE CONFIGURATIONS SHOWN IN THE ELEVATIONS CAN BE ACHIEVED.
- 4. ELECTRICAL PANEL WILL BE INCLUDED IN MODULE DELIVERED BY MANUFACTURER AND CONNECTED TO SITE ELECTRICAL SERVICE BY THE GENERAL CONTRACTOR. CONDUIT PATHWAYS AND JUNCTION BOXES FOR SITE LIGHTING, SECURITY CAMERAS, AND PV PANEL HOOKUPS WILL BE INCLUDED AS SHOWN ON DRAWINGS ON THIS
- 5. OUTLETS SHOWN ON THIS SHEET REFLECT PROJECT PROGRAMMATIC REQUIREMENTS ONLY. PROVIDE ADDITIONAL CONVENIENCE POWER OUTLETS AS REQUIRED BY
- 6. PLUMBING FIXTURES, WATER HEATER, AND ASSOCIATED PLUMBING LINES WILL BE INCLUDED IN MODULE DELIVERED BY MANUFACTURER AND CONNECTED TO SITE PLUMBING LINES.
- A. EACH BATHROOM WILL BE EQUIPPED WITH AN ACORN R2100 BLOWOUT TOILET W/ ENVIRO-GLAZE FINISH IN SNOW WHITE EG-10/ 1.28GPF FLUSH VALVE.
- B. EACH BATHROOM WILL BE EQUIPPED WITH AN AO SMITH DEL-6S-2.5 WATER HEATER OR EQUAL IN THE MECHANICAL CHASE AS SHOWN.

- 7. SPRINKLERS WILL BE INCLUDED IN MODULE DELIVERED BY MANUFACTURER AND CONNECTED TO FIRE WATER SERVICE PIPING CONSTRUCTED PRIOR TO INSTALLATION. 8. FIRE ALARM SYSTEM WILL BE INSTALLED ON SITE. MODULE MANUFACTURER WILL PROVIDE PATHWAYS FOR DEVICES, INCLUDING LOW VOLTAGE CONNECTIONS AS DESIGNED BY SITE FIRE ALARM DESIGNER.
- 9. PROVIDE FINISHES AS INDICATED ON INTERIOR ELEVATIONS AND FINISH PLANS ON THIS SHEET.
- 10. PROVIDE PAINTED METAL (ALUM OR STEEL) DOORS AND FRAMES (P-A) WITH ELECTRONIC MORTISE LOCK (SCHLAGE CO-100 OR EQUAL). LOCKSET SHALL BE OFFICE FUNCTION WITH KEYPAD AND KEYED EMERGENCY OVERRIDE. PROVIDE ACCESSIBLE LEVER HANDLE (SCHLAGE 'RHODES' OR EQUAL).
- 11. PROVIDE INTEGRATED MOUNTING INFRASTRUCTURE FOR FIELD-INSTALLED PHOTOVOLTAIC PANELS. MOUNTING SPECIFICATIONS FOR SPECIFIC PV SYSTEM USED WILL BE PROVIDED BY THE PROJECT DESIGN TEAM.
- 12. WIRELESS ACCESS POINTS WILL BE INSTALLED AT EACH MODULE. MANUFACTURER WILL PROVIDE PATHWAYS FOR CABLING WITHIN MODULES. DEVICES AND CABLING WILL BE PROVIDED BY OWNER'S I.T. AND SECURITY VENDORS.

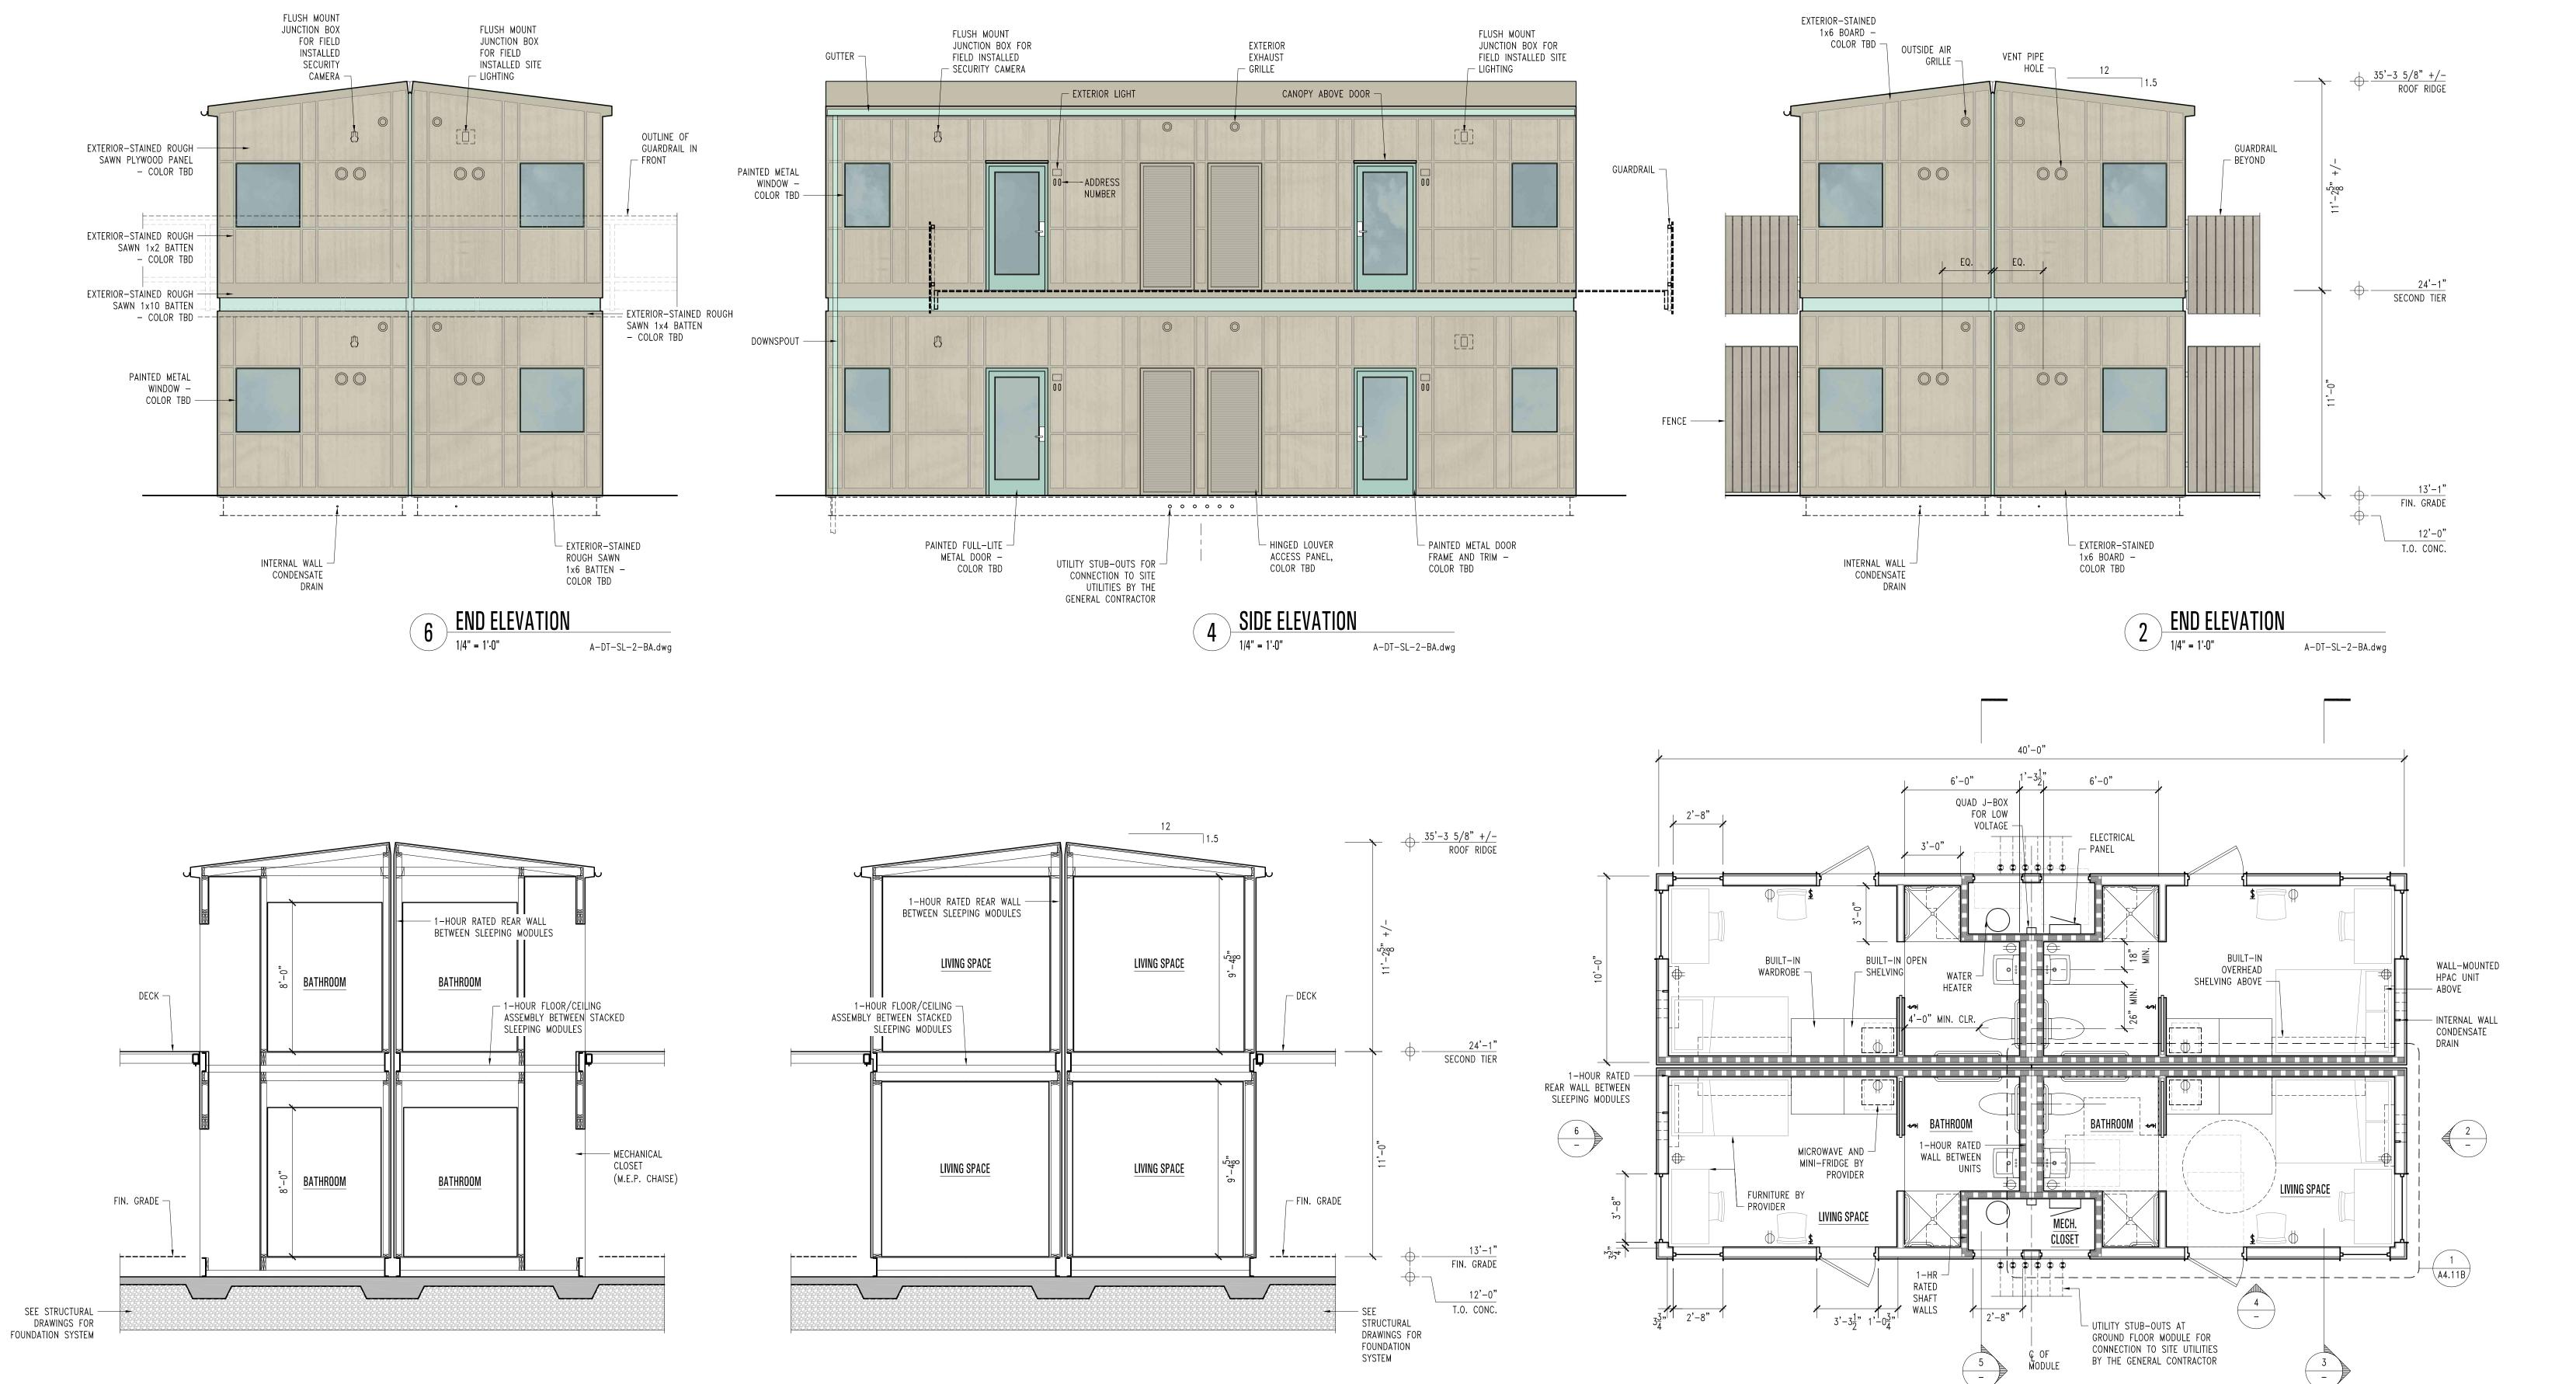


CROSS SECTION THRU BEDROOM

A-DT-SL-2-BA.dwg

21016.00

THE OFFICE OF

Three Embarcadero Center Promenade Level, Suite P2 San Francisco, CA 94111 www.archengine.com 415.834.9002

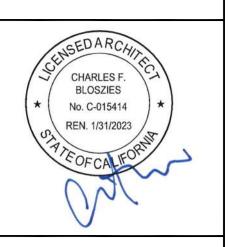

HOMEKEY Palo Alto Supportive Interim Housing

1237 San Antonio Road

Graphic and written material appearing on this sheet constitutes original and unpublished work of the Architect. Copyright of this material is owned by the Architect and protected by the 1990 Architectural Works Copyright Act. Unauthorized duplication of this material, without written prior consent of the Architect, is prohibited.

File Name 21016—	e: A4.11A.dwg	Drawn By: MLP	Checked By:
lss	ues 2		
Number	Date	Description	
1	04.04.22	100% SCHEMATIC DE	SIGN
2	04.07.22	ARCH REVIEW BOARD	SUBMITTAL

Revisions

Number Date Description

APRIL 07, 2022

A4.11A

A-DT-SL-2-BA.dwg


- 1. THIS SHEET IS NOT A CONSTRUCTION DOCUMENT. IT IS INTENDED TO CONVEY THE OWNER'S PROGRAMMATIC REQUIREMENTS FOR USE BY THE DESIGNERS OF THE MODULAR UNITS SHOWN ON THE OVERALL SITE PLANS.
- 2. SLEEPING MODULES SHALL BE CERTIFIED BY THE CALIFORNIA DEPARTMENT OF HOUSING AND COMMUNITY DEVELOPMENT (HCD) AS "FACTORY-BUILT" HOUSING

CHARLES F. BLOSZIES FAIA Three Embarcadero Center

THE OFFICE OF


21016.00

Promenade Level, Suite P2 San Francisco, CA 94111 www.archengine.com 415.834.9002

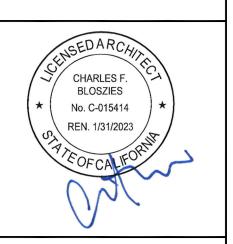


HOMEKEY Palo Alto Supportive Interim Housing


1237 San Antonio Road Palo Alto, California

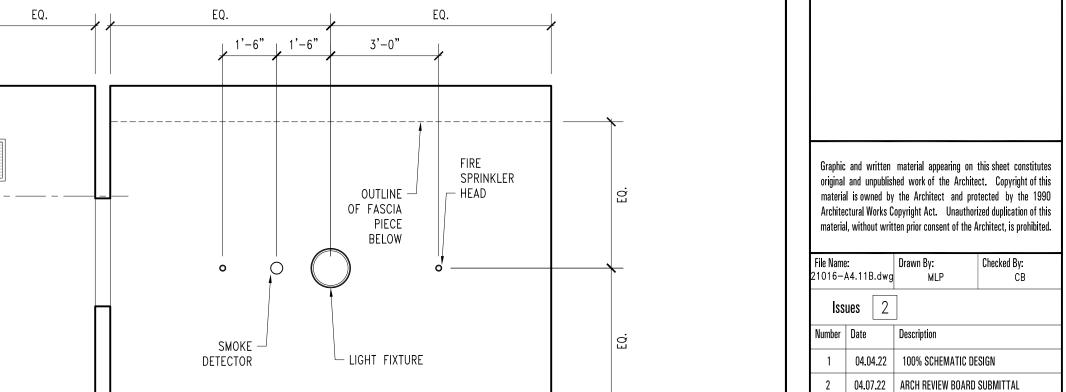




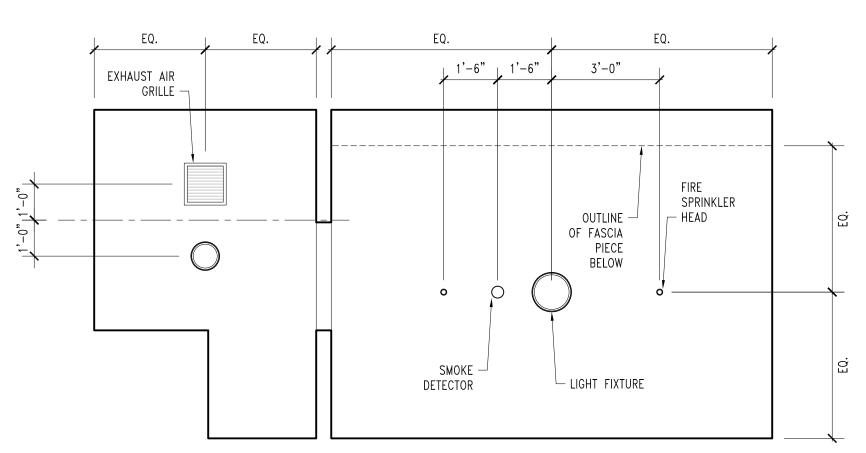



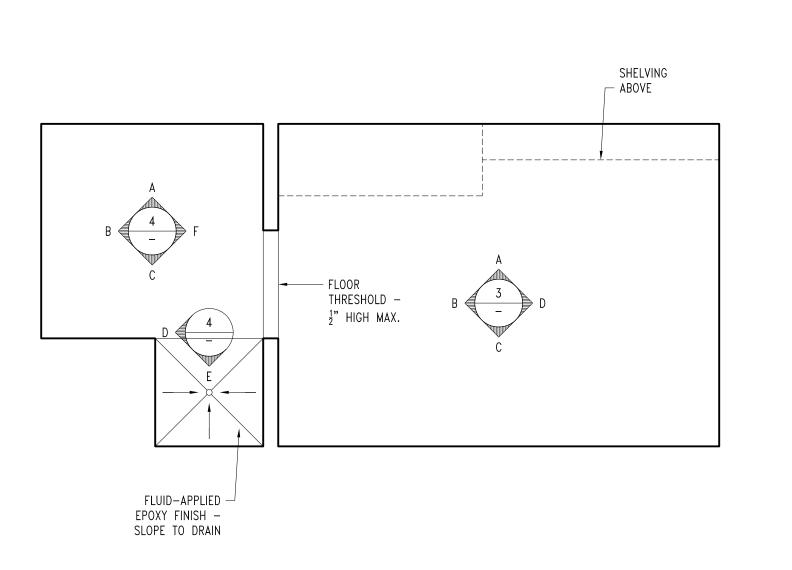

1 FINISH PLAN
3/16" = 1'-0" A-DT-SL-2-BA.dwg

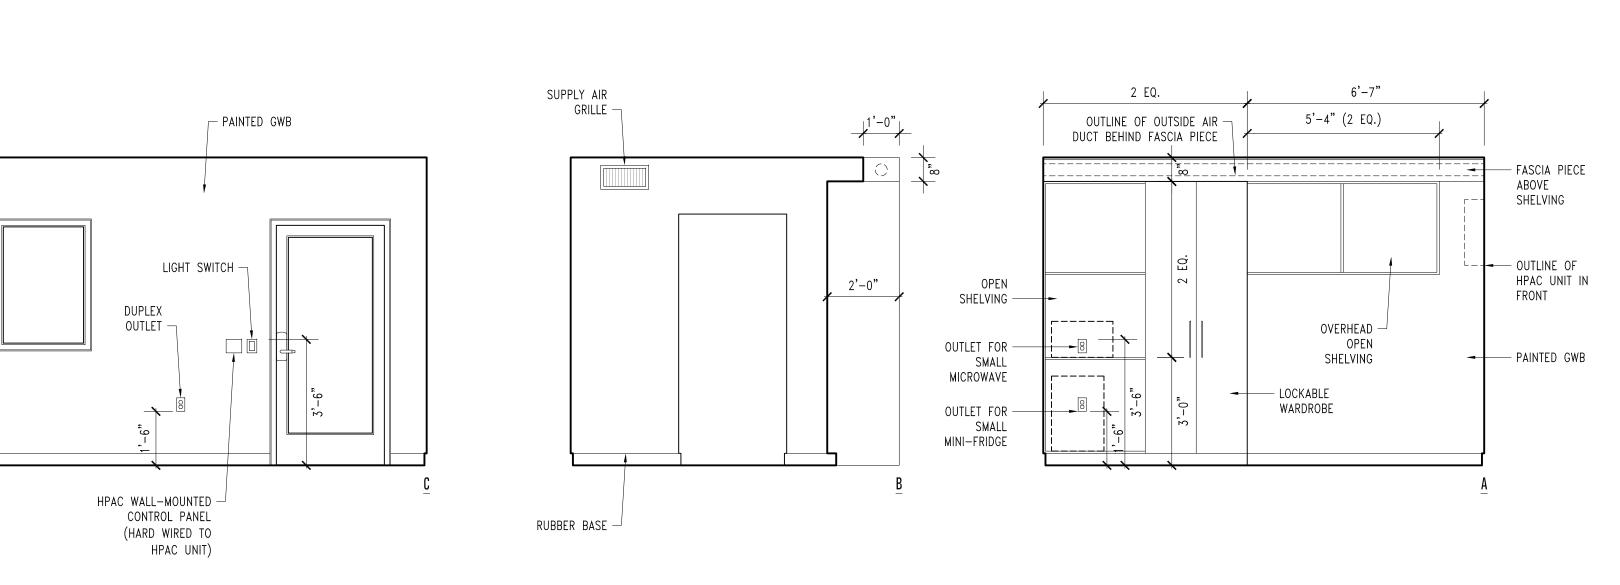

— DUPLEX OUTLET

SHOWER CURTAIN + ROD

EPOXY WALL COATING

FRP PANEL  $\neg$ 

RUBBER BASE —

LIGHT SWITCH —

WALL-MOUNTED - HPAC UNIT

RUBBER BASE

OUTLINE OF OVERHEAD OPEN SHELVING IN FRONT —

EPOXY WALL COATING

EPOXY WALL COATING —

3 LIVING SPACE INTERIOR ELEVATIONS
3/16" = 1'-0" A-DT-SL-2-BA.dwg

TOILET
PAPER
DISPENSER


4 BATHROOM INTERIOR ELEVATIONS
3/16" = 1'-0" A-DT-SL-2-BA.dwg

└ RUBBER BASE

A4.11B

SLEEPING MODULE SL-2-BA INTERIOR DETAILS

APRIL 07, 2022

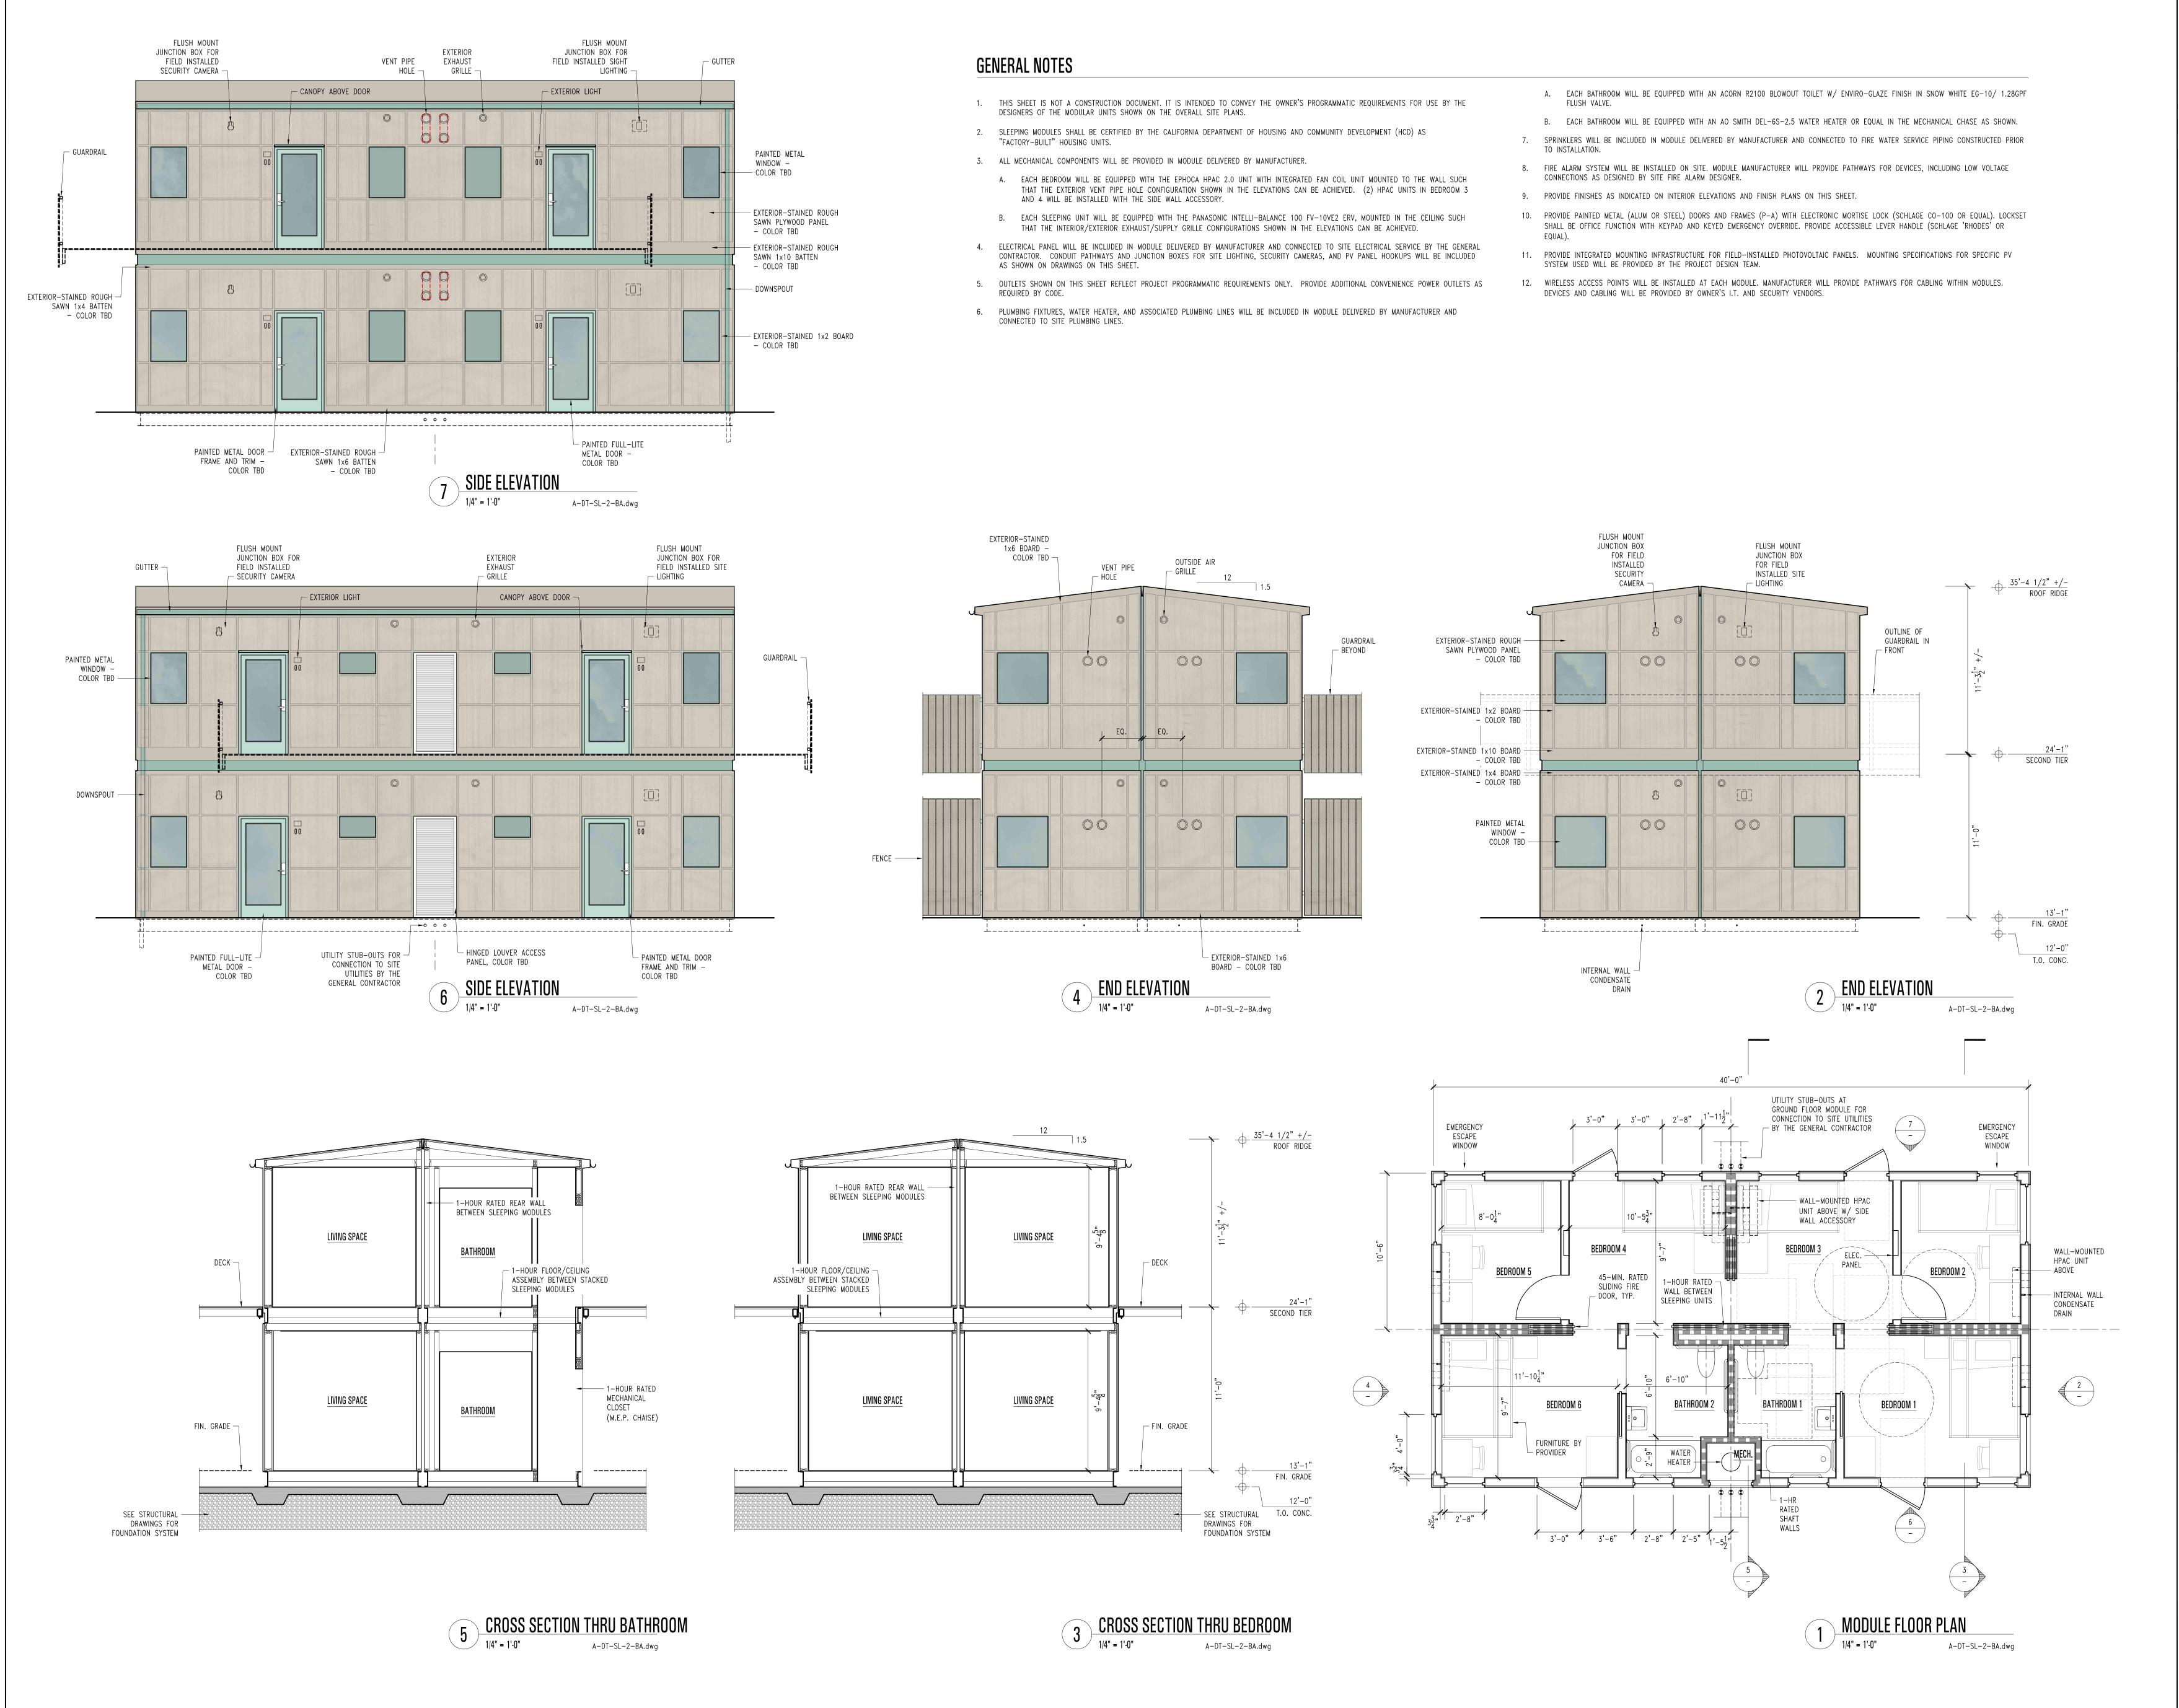

Project Number 21016.00

THE OFFICE OF

CHARLES F.

BLOSZIES FAIA

ARCHITECTURE STRUCTURES

Three Embarcadero Center Promenade Level, Suite P2 San Francisco, CA 94111 www.archengine.com 415.834.9002



HOMEKEY Palo Alto
Supportive Interim Housing

1237 San Antonio Road Palo Alto, California


Graphic and written material appearing on this sheet constitutes original and unpublished work of the Architect. Copyright of this material is owned by the Architect and protected by the 1990 Architectural Works Copyright Act. Unauthorized duplication of this material without written prior consent of the Architect is prohibited.


File Name 21016—	e: A4.12A.dwg	Drawn By: MLP	Checked By: CB
Issues 2			
Number	Date	Description	
1	04.04.22	100% SCHEMATIC DE	SIGN
2	04.07.22	ARCH REVIEW BOARD	SUBMITTAL

SLEEPING MODULI SL-FAM EXTERIOR DETAILS


Date: APRIL 07, 2022

A4.12A

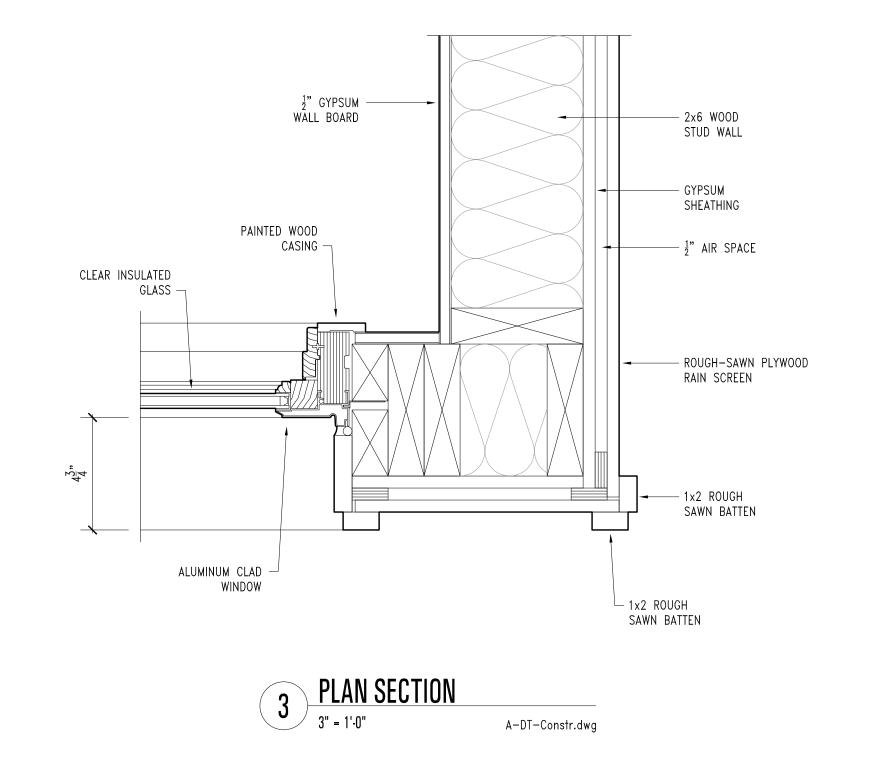

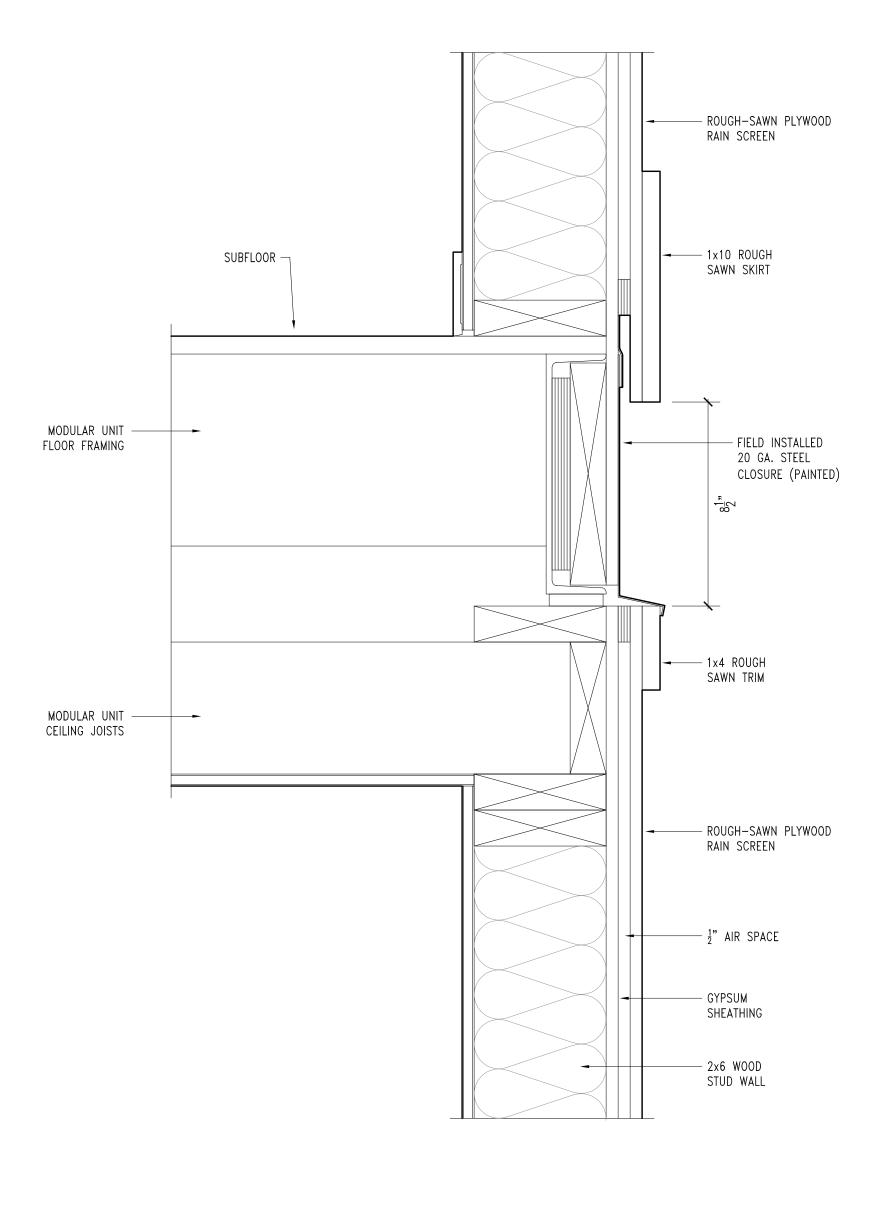



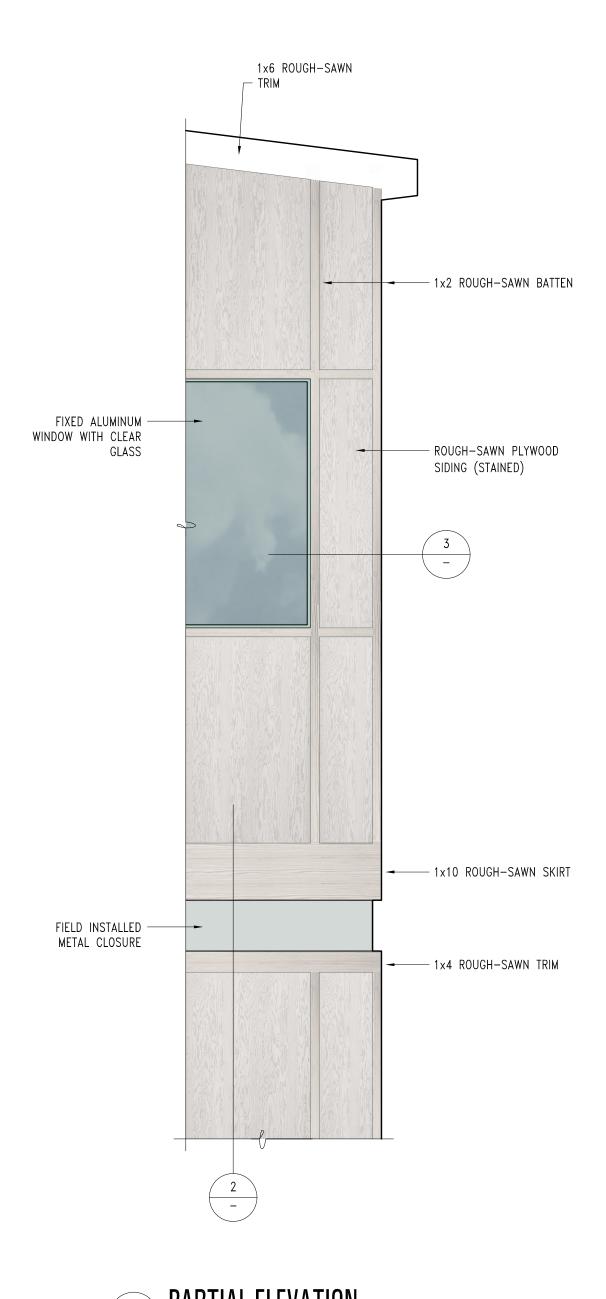

PARTIAL ELEVATION

3/4" = 1'-0"

A-DT-Constr.dwg

Project Number 21016.00


THE OFFICE OF

CHARLES F.

BLOSZIES FAIA
LTD

ARCHITECTURE | STRUCTURES

Three Embarcadero Center Promenade Level, Suite P2 San Francisco, CA 94111 www.archengine.com 415.834.9002

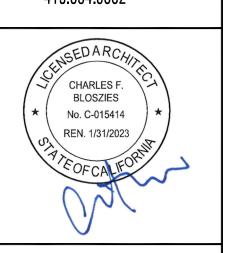

HOMEKEY Palo Alto
Supportive Interim Housing

1237 San Antonio Road Palo Alto, California

Graphic and written material appearing on this sheet constitutes original and unpublished work of the Architect. Copyright of this material is owned by the Architect and protected by the 1990 Architectural Works Copyright Act. Unauthorized duplication of this material, without written prior consent of the Architect, is prohibited.

TYPICAL MODULE

APRIL 07, 2022

Δ4 91


- REFER TO STRUCTURAL DRAWINGS FOR STRUCTURE MEMBER SIZES AND CONNECTIONS, ROOF AND WALL FRAMING DETAILS, SHEARWALL LOCATIONS, AND OTHER CONSTRUCTION DETAILS.
- 2. DIMENSIONS FOR PARTITIONS ARE TO FACE OF STUD, TYP. 'CLEAR' DIMENSIONS ARE TO FACE OF FINISH.
- 3. PROVIDE PAINTED FINISH AT EXPOSED STEEL FRAMES
- 4. POWER AND DATA OUTLETS SHOWN REFLECT SHELTER OPERATOR'S PROGRAMMATIC REQUIREMENTS. PROVIDE ANY ADDITIONAL CONVENIENCE OUTLETS REQUIRED BY CODE.


#### SYMBOL KEY


- DUPLEX OUTLET
- DUPLEX COTLET


  DUPLEX COTLET
- RECESSED FLOOR OUTLET (QUAD)
- ightharpoonup Data (INCL. NUMBER OF LINES)
- POE CAMERA BY TENANT. PROVIDE JBOX AND CONDUIT PATHWAY

  WIRELESS ACCESS POINT BY TENANT. PROVIDE JBOX AND CONDUIT PATHWAY

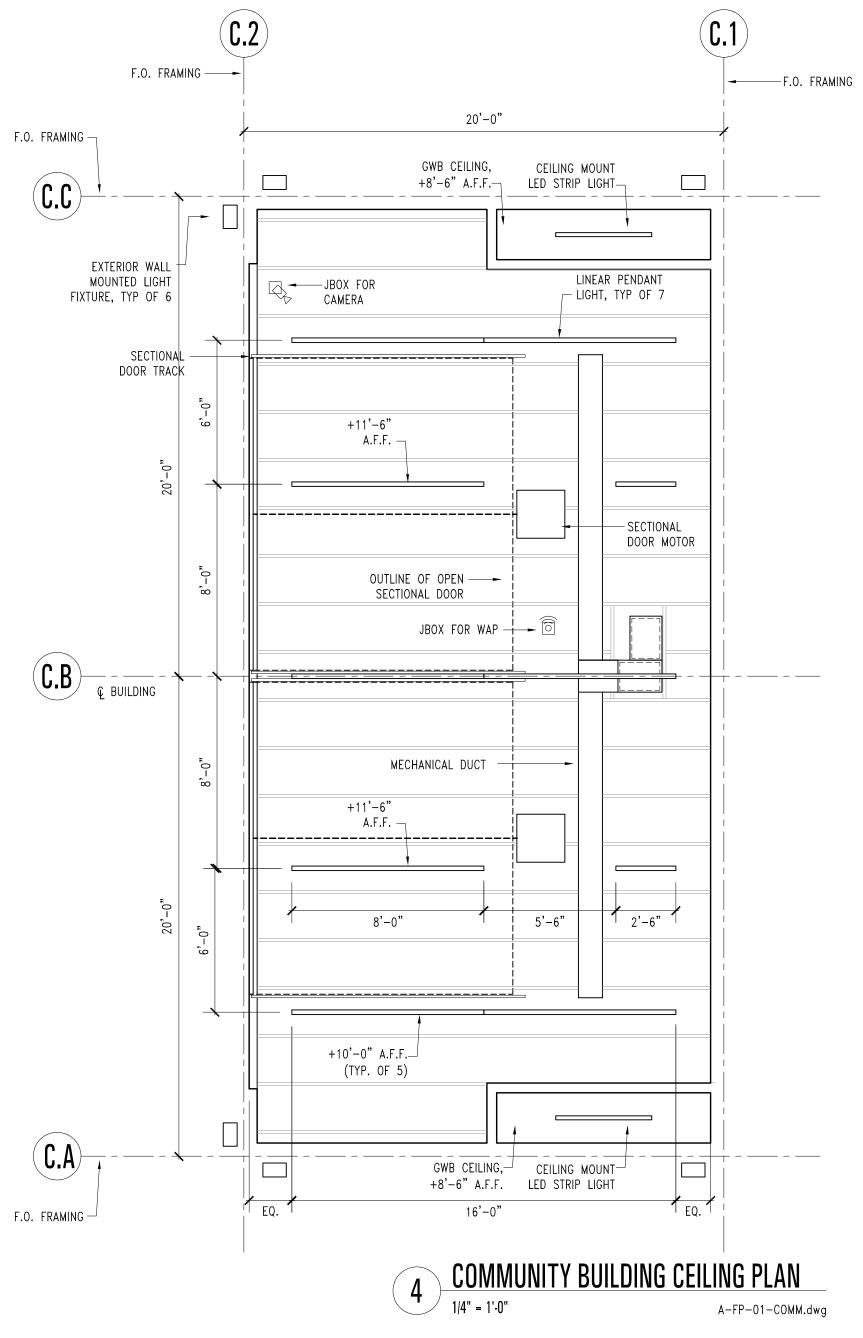

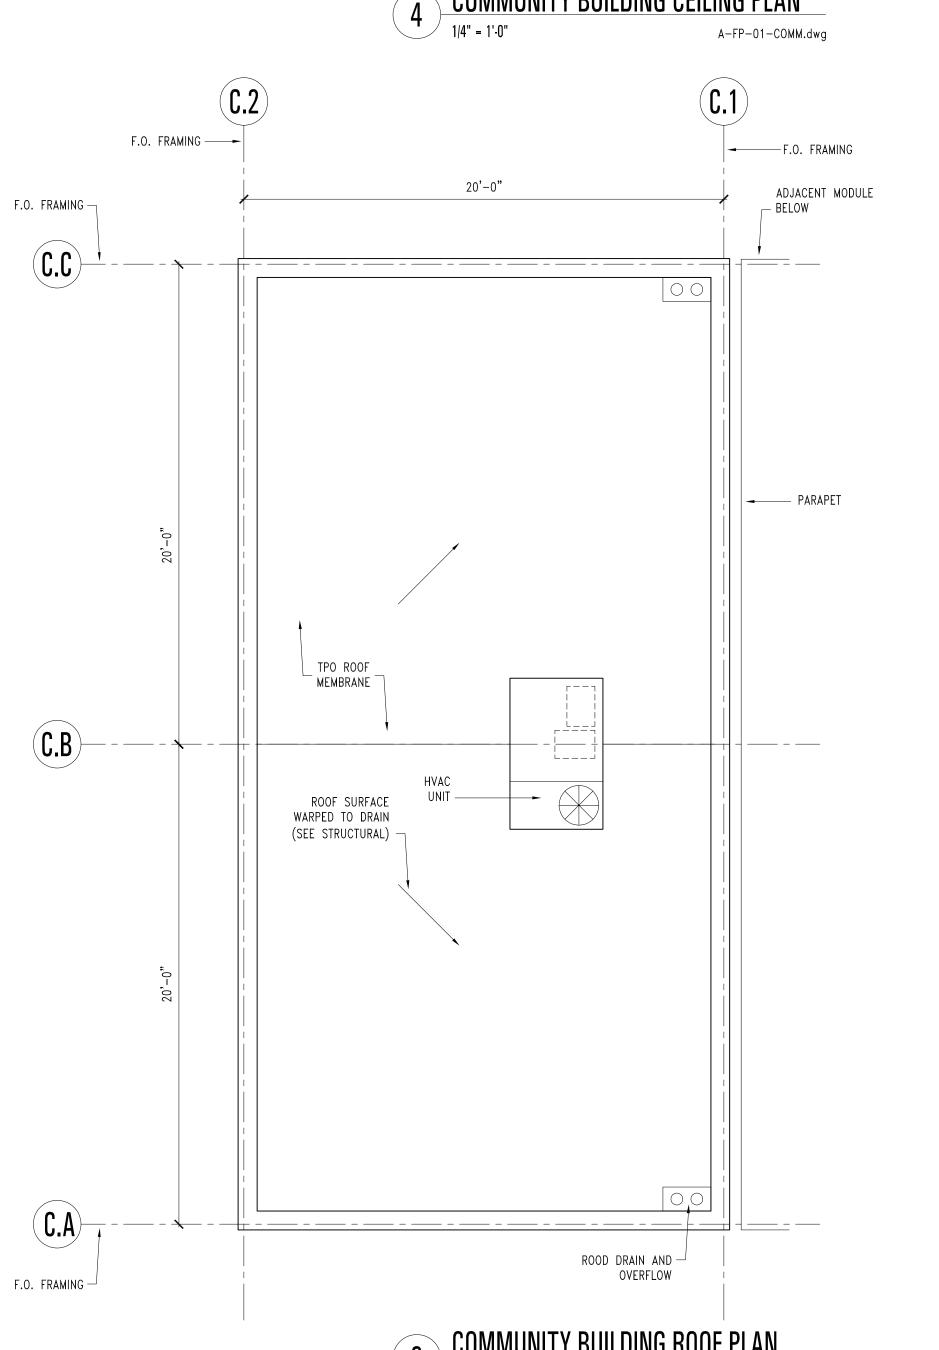

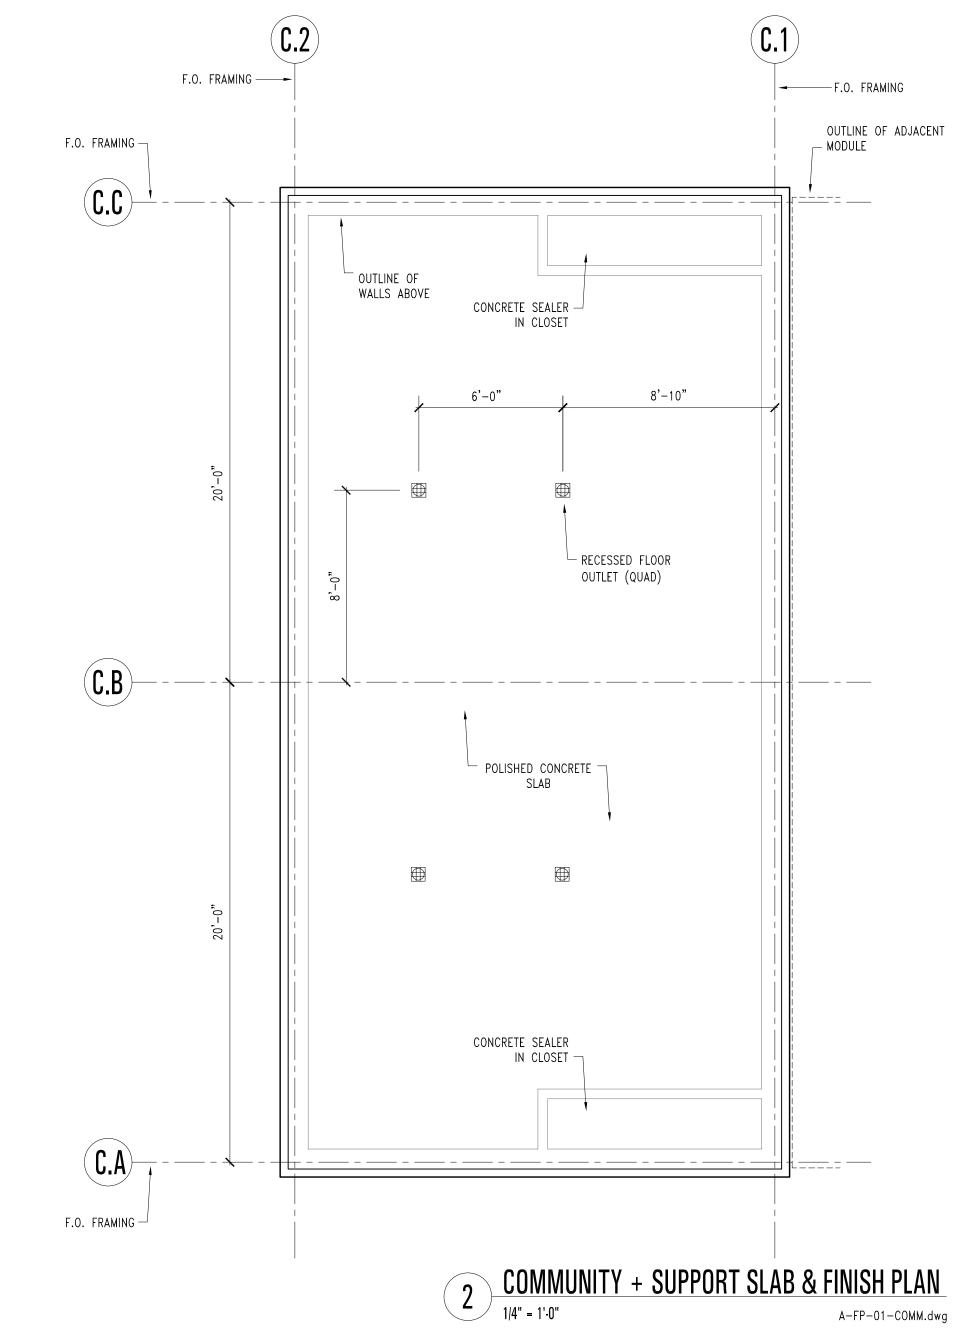

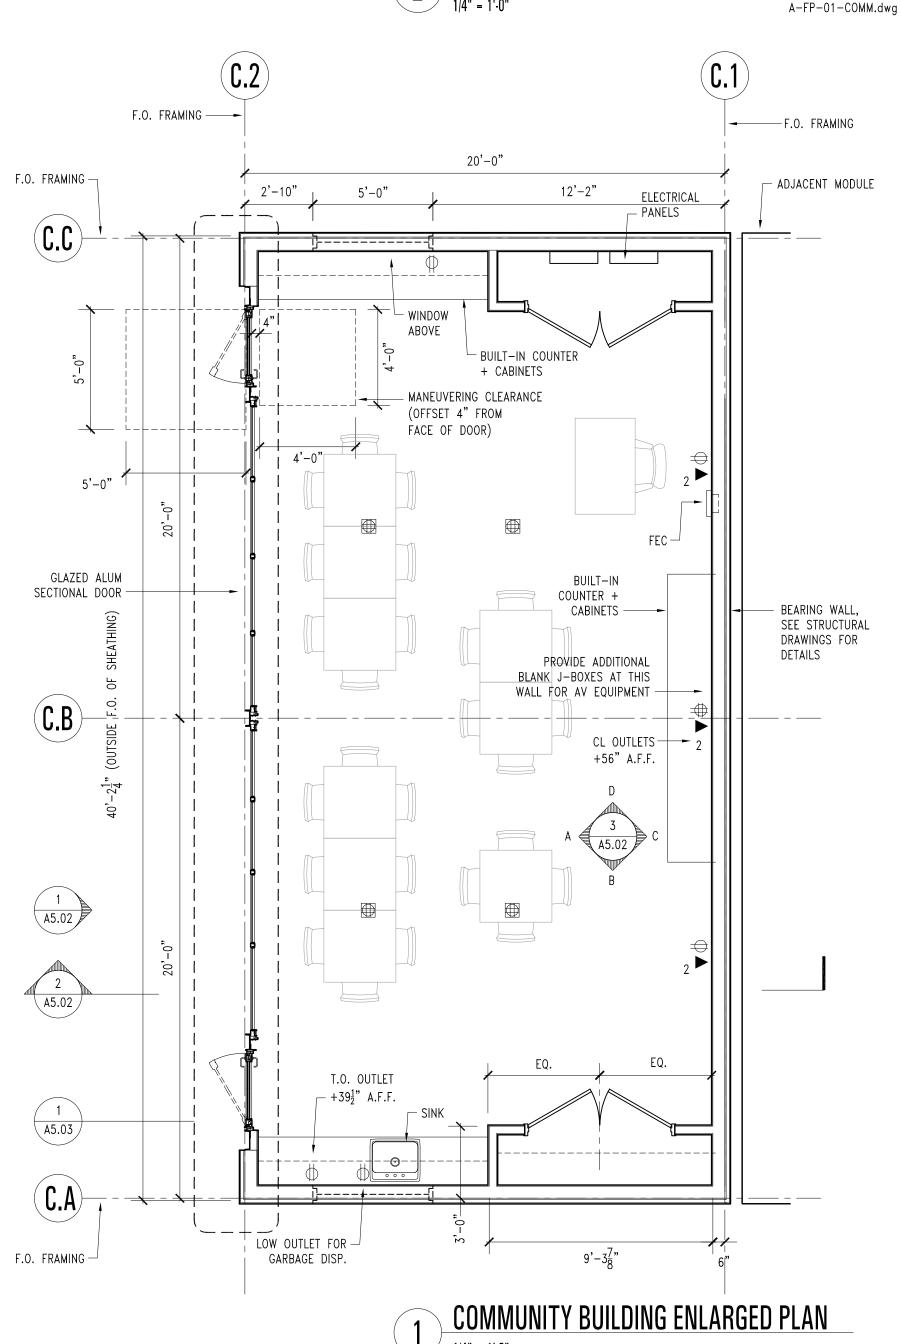

Project Number **21016.00** 


THE OFFICE OF

CHARLES F

BLOSZIES FAI

ARCHITECTURE I STRUCTURE

Three Embarcadero Center Promenade Level, Suite P2 San Francisco, CA 94111 www.archengine.com 415.834.9002

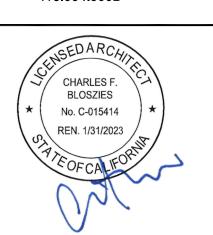

HOMEKEY Palo Alto
Supportive Interim Housing

1237 San Antonio Road Palo Alto, California

Graphic and written material appearing on this sheet constitutes original and unpublished work of the Architect. Copyright of this material is owned by the Architect and protected by the 1990 Architectural Works Copyright Act. Unauthorized duplication of this material, without written prior consent of the Architect, is prohibited.

File Name:

Drawn By:

Checked By:

21016—A5.01.dwg

MW

CB

Number Date Description

1 04.04.22 100% SCHEMATIC DESIGN

2 04.07.22 ARCH REVIEW BOARD SUBMITTAL


Revisions

Number Date Description

COMMUNITY BUILDING ENLARGED PLANS

Date: APRIL 07, 2022

A5.01

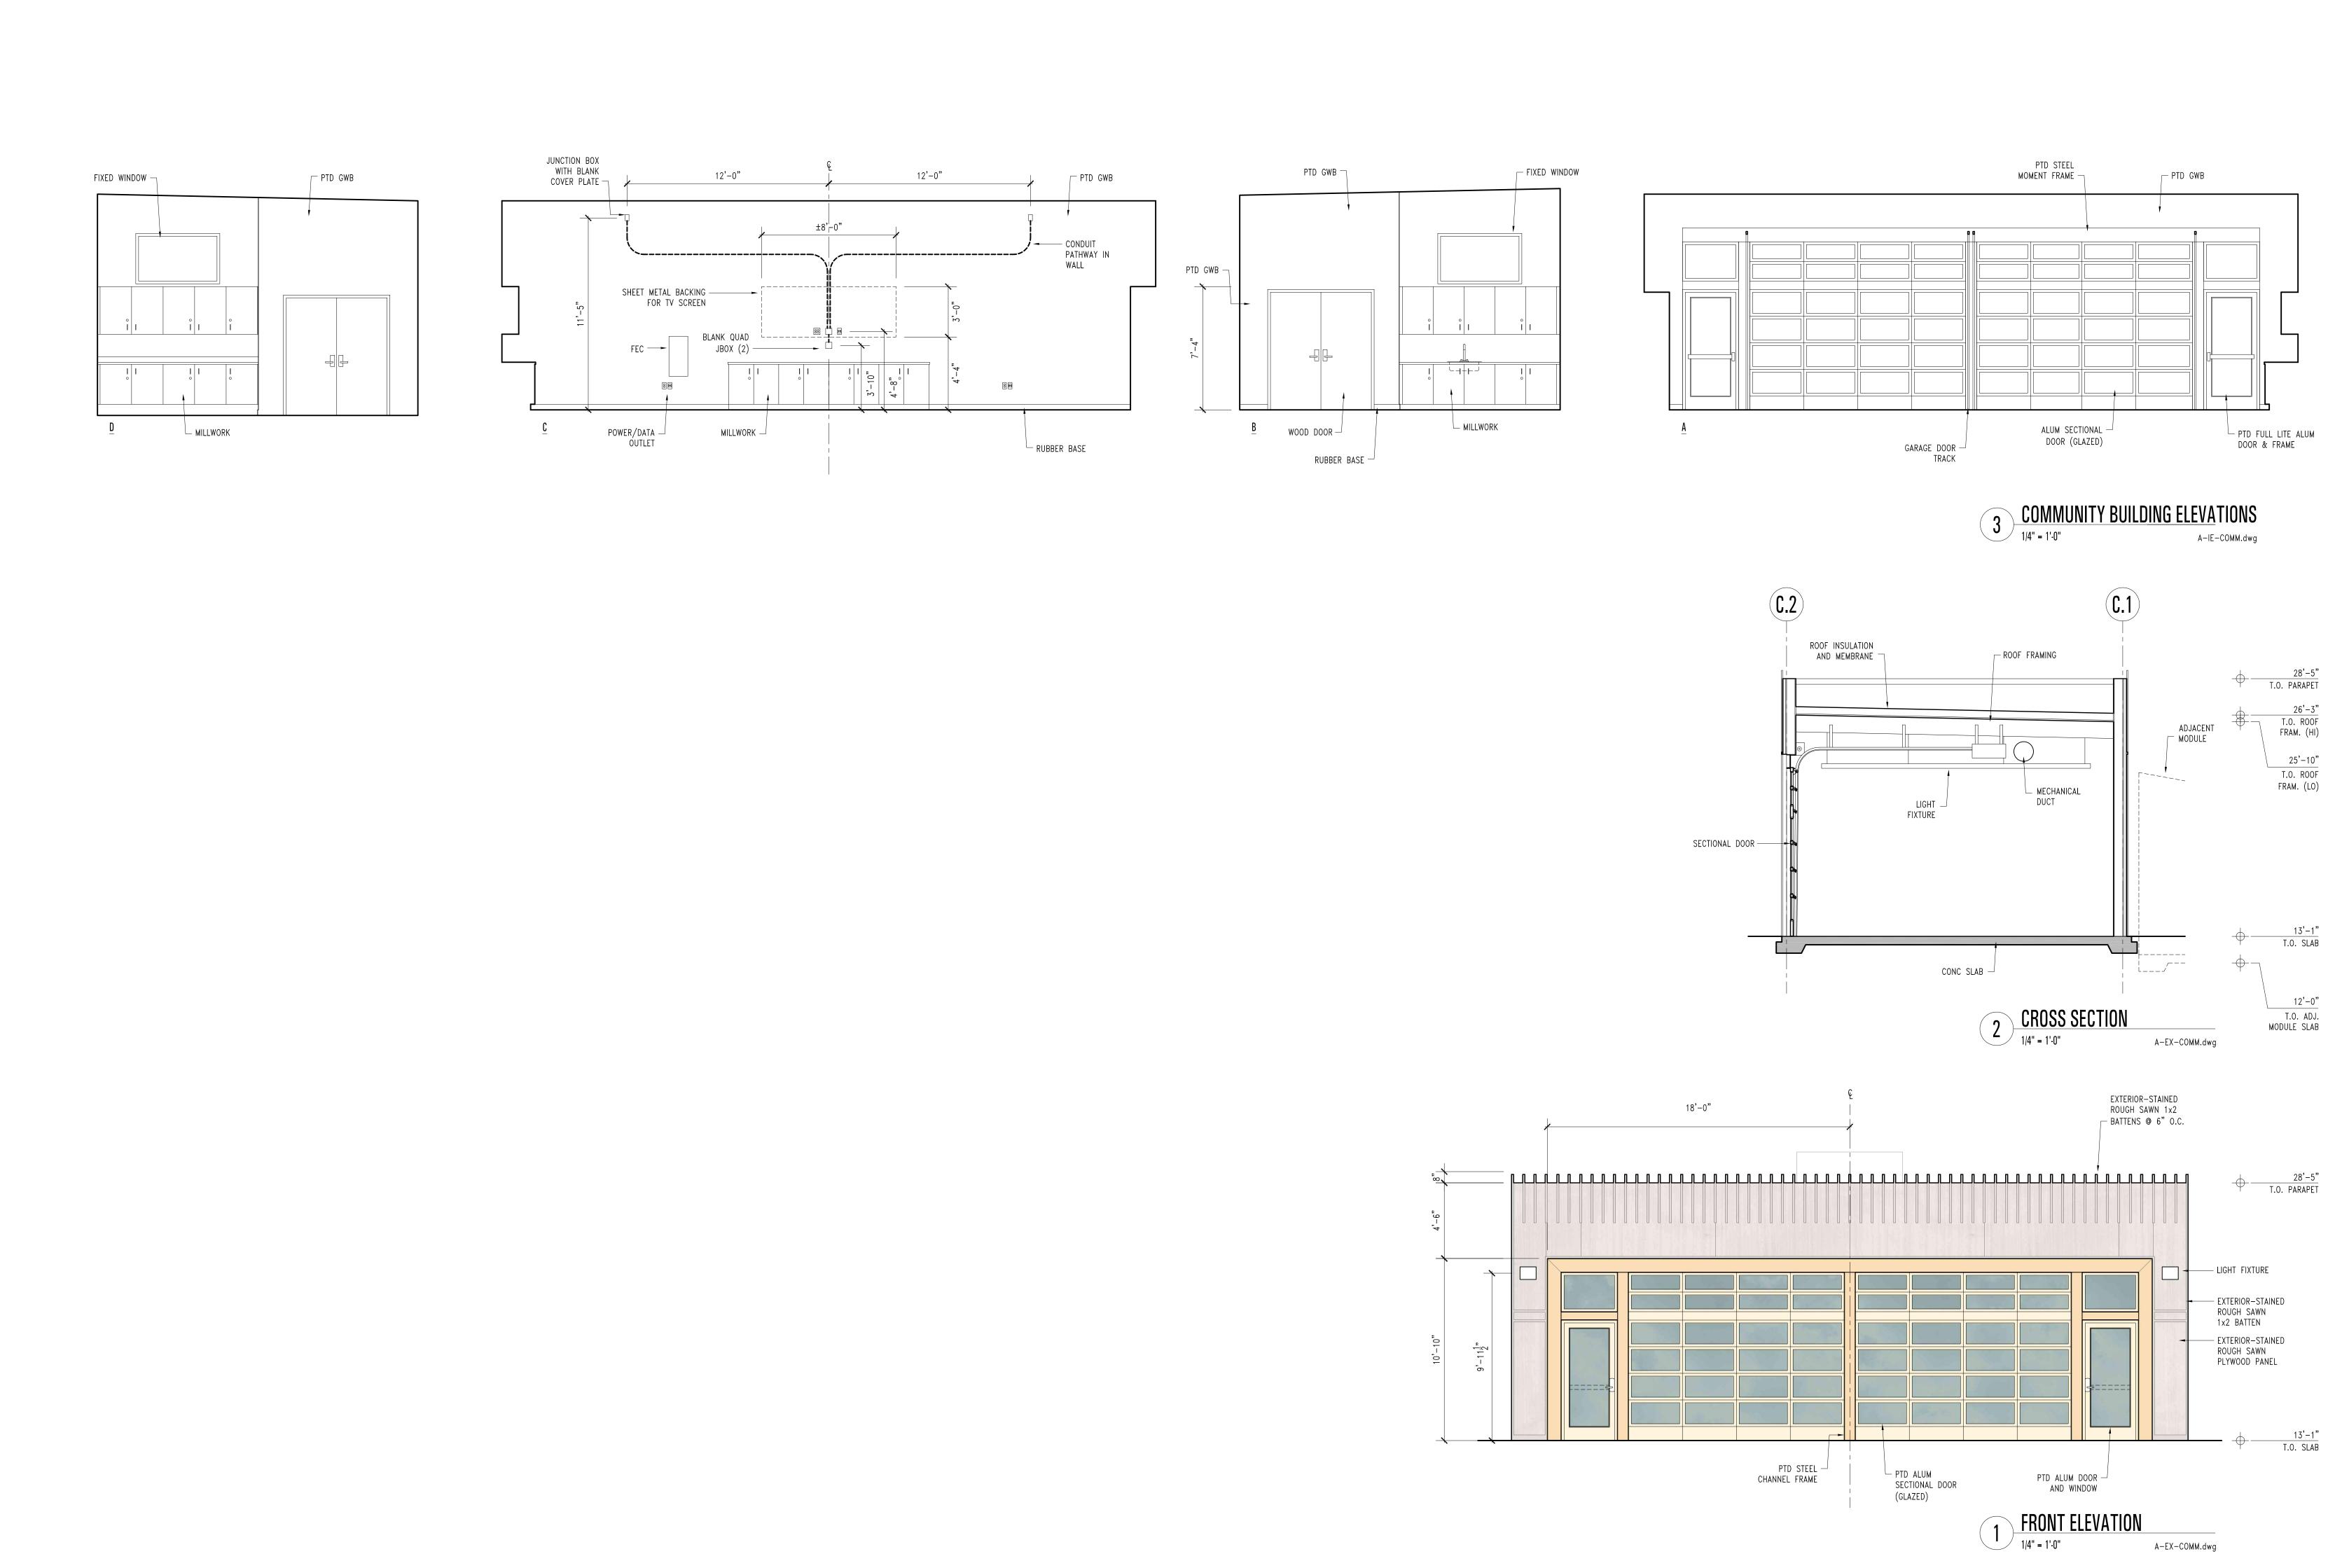

oject Number

21016.00

THE OFFICE OF


CHARLES F.

BLOSZIES FAIA

LTD

ARCHITECTURE | STRUCTURES

Three Embarcadero Center Promenade Level, Suite P2 San Francisco, CA 94111 www.archengine.com 415.834.9002

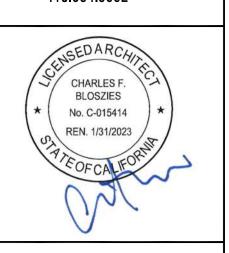

HOMEKEY Palo Alto
Supportive Interim Housing

1237 San Antonio Road Palo Alto, California

Graphic and written material appearing on this sheet constitutes original and unpublished work of the Architect. Copyright of this material is owned by the Architect and protected by the 1990 Architectural Works Copyright Act. Unauthorized duplication of this material, without written prior consent of the Architect, is prohibited.

materia	I, WITHOU	ut Writ	ten prior consent of the A	rchitect, is prohibited.	
File Name 21016—		.dwg	Drawn By: MW	Checked By: CB	
lss	ues	2			
Number	Date		Description		
1	04.04	4.22	100% SCHEMATIC DE	SIGN	
2	04.07	7.22	ARCH REVIEW BOARD	RCH REVIEW BOARD SUBMITTAL	
	visions	3 _			
Number	Date		Description		

COMMUNITY
BUILDING
ELEVATIONS &


Date: APRIL 07, 2022

A5.02

- 1. REFER TO STRUCTURAL DRAWINGS FOR STRUCTURE MEMBER SIZES AND CONNECTIONS, ROOF AND WALL FRAMING DETAILS, SHEARWALL LOCATIONS, AND OTHER CONSTRUCTION DETAILS.
- 2. DIMENSIONS FOR PARTITIONS ARE TO FACE OF STUD, TYP. 'CLEAR' DIMENSIONS ARE TO FACE OF FINISH.
- 3. PROVIDE PAINTED FINISH AT EXPOSED STEEL FRAMES
- 4. POWER AND DATA OUTLETS SHOWN REFLECT SHELTER OPERATOR'S PROGRAMMATIC REQUIREMENTS. PROVIDE ANY ADDITIONAL CONVENIENCE OUTLETS REQUIRED BY CODE.

#### SYMBOL KEY

- \_\_\_\_\_
- ⇒ DUPLEX OUTLET⇒ QUAD OUTLET
- → 2 DATA (INCL. NUMBER OF LINES)
- WIRELESS ACCESS POINT BY TENANT. PROVIDE JBOX AND CONDUIT PATHWAY

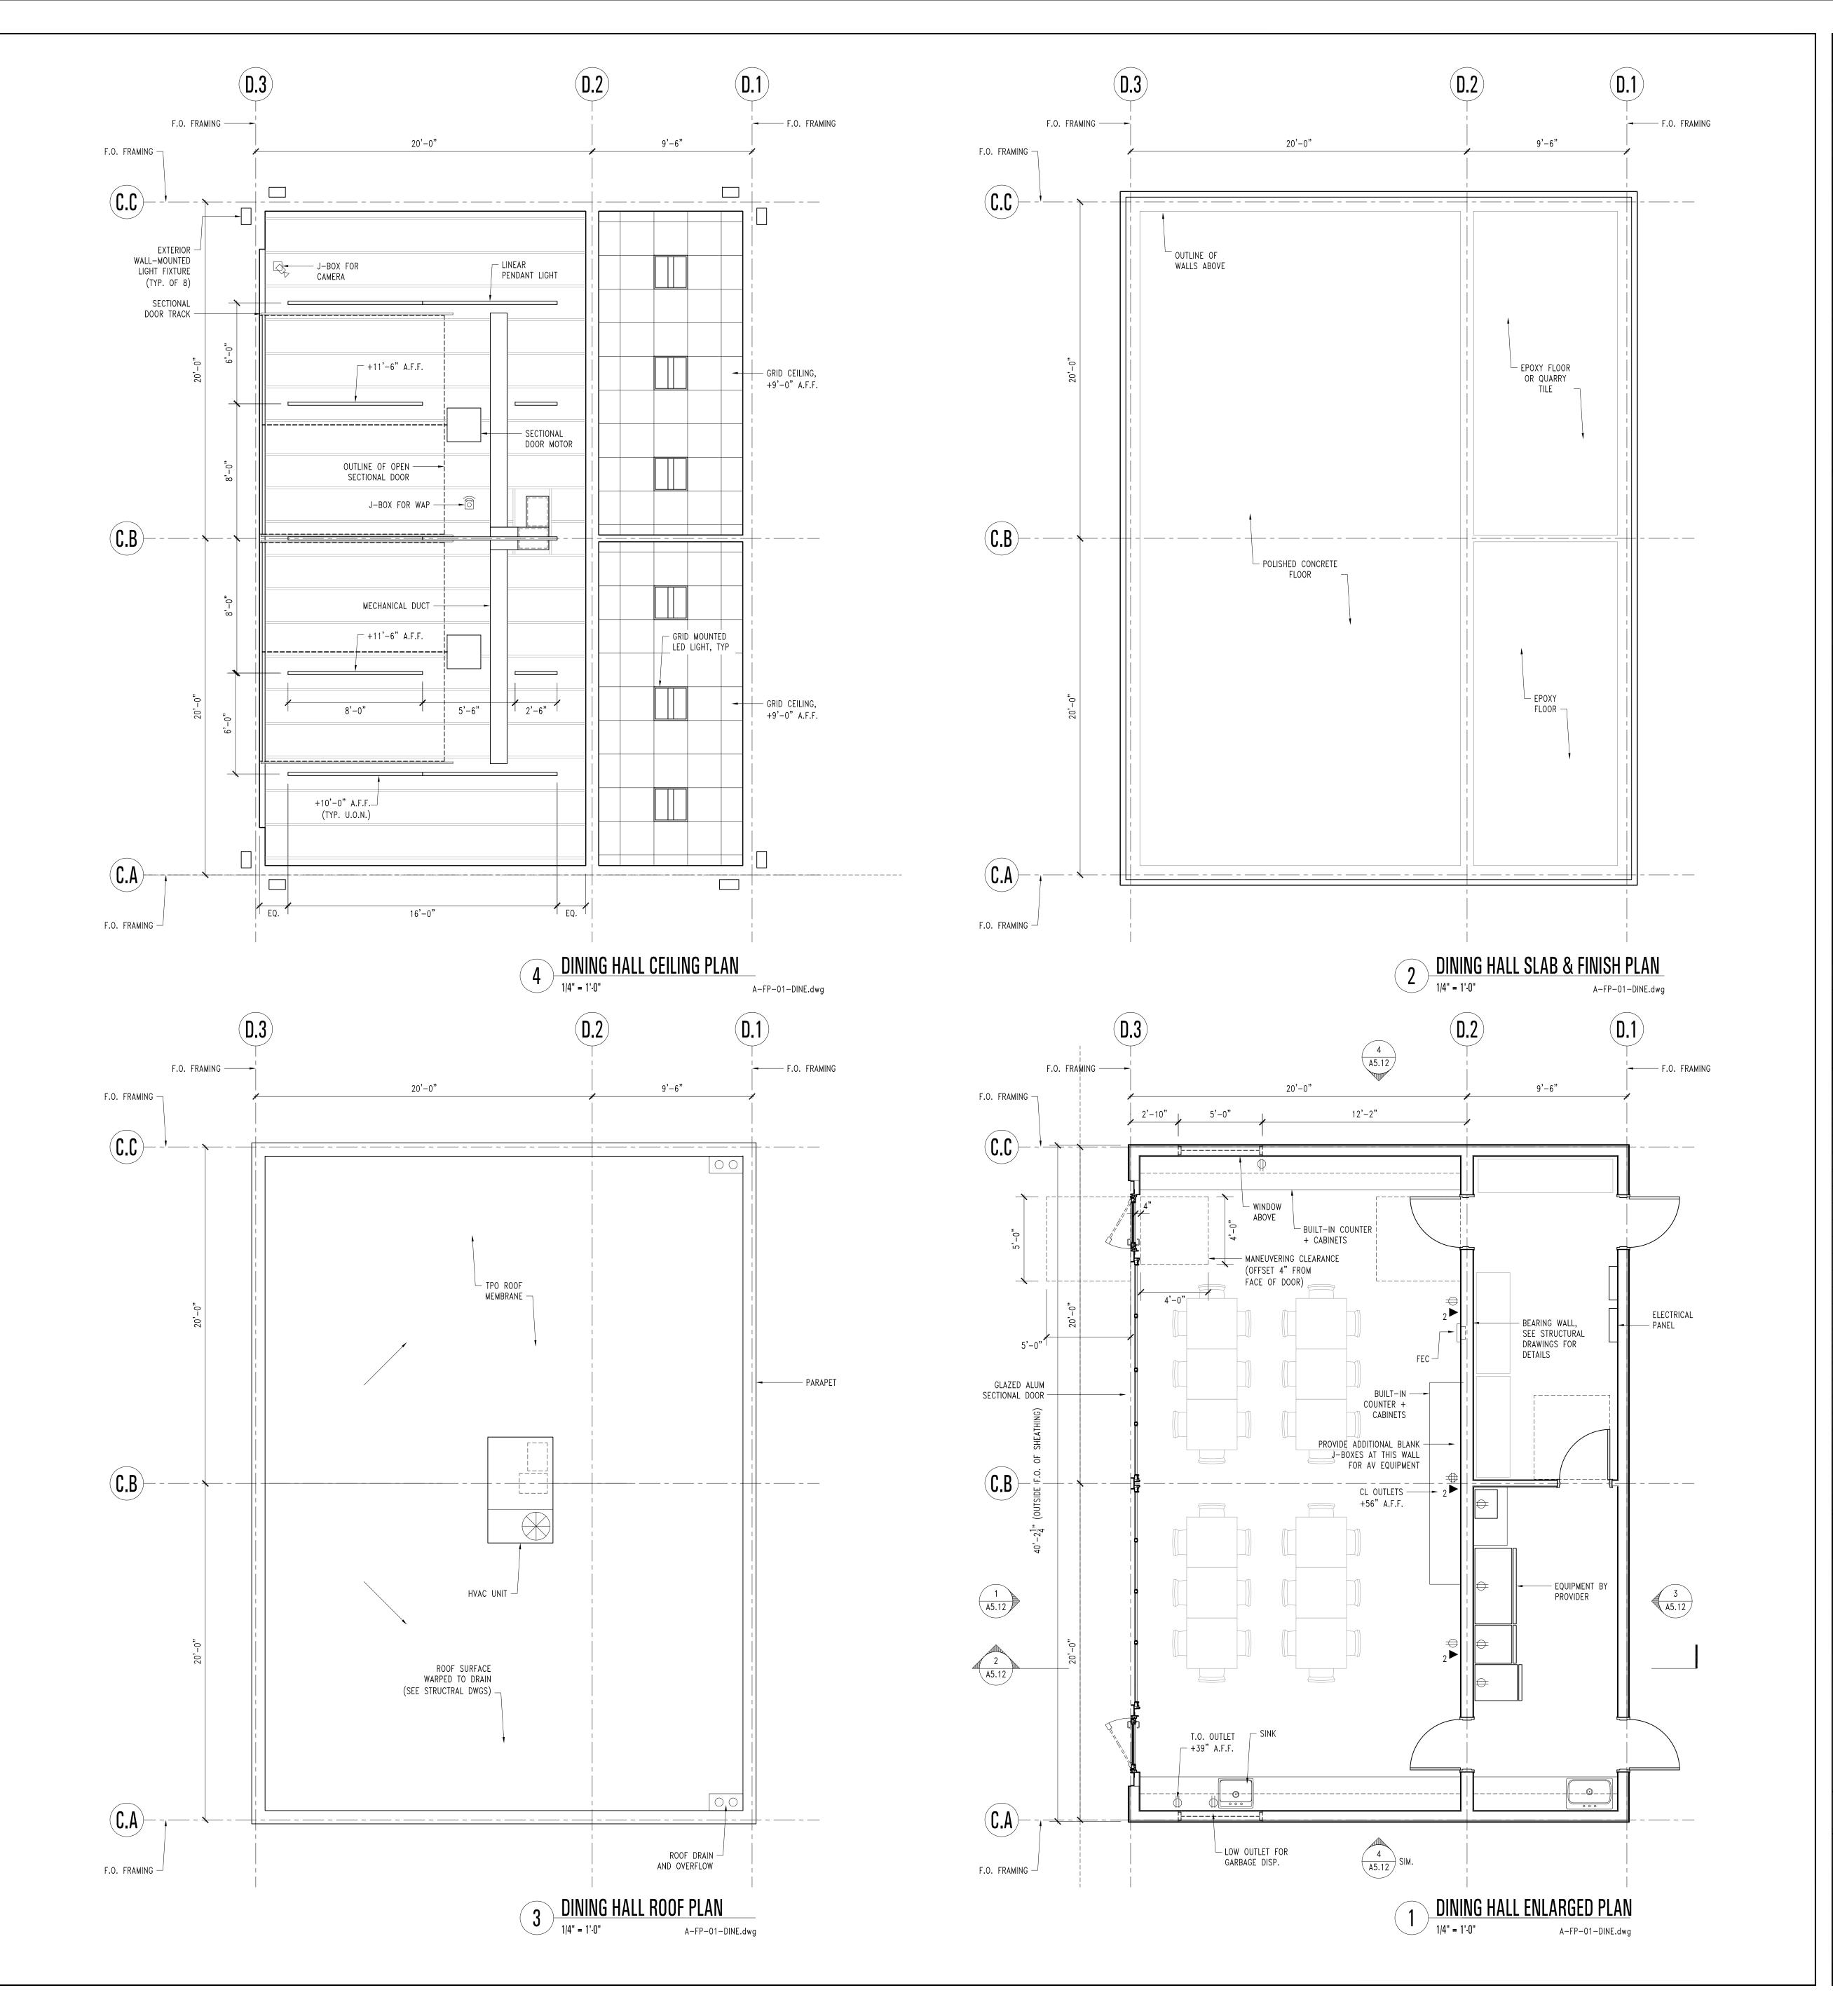

Project Number 21016.00


THE OFFICE OF

CHARLES F.

BLOSZIES FAIA

Three Embarcadero Center Promenade Level, Suite P2 San Francisco, CA 94111 www.archengine.com 415.834.9002

ARCHITECTURE | STRUCTURES

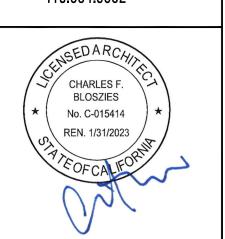

HOMEKEY Palo Alto
Supportive Interim Housing

1237 San Antonio Road Palo Alto, California

Graphic and written material appearing on this sheet constitutes original and unpublished work of the Architect. Copyright of this material is owned by the Architect and protected by the 1990 Architectural Works Copyright Act. Unauthorized duplication of this material, without written prior consent of the Architect, is prohibited.

| Size | Checked By: | Checked

DINING HALL ENLARGED PLANS

\*\* APRIL 07, 2022

Δ5 11

EXTERIOR—STAINED ROUGH SAWN 1x2 PARAPET BEYOND BATTENS @ 8" O.C. INSULATION AND ┌─ ROOF FRAMING MEMBRANE  $\neg$ 26'-3"
T.O. ROOF
FRAM. (HI) — LIGHT FIXTURE FIXED PTD METAL WINDOW — FRAM. (LO) — EXTERIOR-STAINED └ MECHANICAL ROUGH SAWN 1x2 BATTEN LIGHT FIXTURE — GRID CEILING ─ — EXTERIOR—STAINED ROUGH SAWN PLYWOOD PANEL SECTIONAL DOOR — 13'-1" T.O. SLAB CONC SLAB -T.O. ADJ.
MODULE SLAB 2 CROSS SECTION

1/4" = 1'.0" A-EX-DINE.dwg A-EX-DINE.dwg EXTERIOR-STAINED
ROUGH SAWN 1x2
BATTENS @ 8" O.C. EXTERIOR-STAINED ROUGH SAWN 1x2 BATTENS 18'-0" —— LIGHT FIXTURE — LIGHT FIXTURE — EXTERIOR-STAINED — EXTERIOR-STAINED ROUGH SAWN 1x2 BATTEN 1x2 BATTEN — EXTERIOR-STAINED ROUGH SAWN PLYWOOD PANEL — EXTERIOR—STAINED ROUGH SAWN PLYWOOD PANEL 13'-1" T.O. SLAB PTD STEEL — CHANNEL FRAME PTD ALUM
SECTIONAL DOOR
(GLAZED) PTD FULL-LITE — METAL DOOR PTD ALUM DOOR — AND WINDOW 3 BACK ELEVATION

1/4" = 1'-0" A-EX-DINE.dwg A-EX-DINE.dwg

21016.00


THE OFFICE OF

CHARLES F.

BLOSZIES FAIA
LTD

ARCHITECTURE | STRUCTURES

Three Embarcadero Center Promenade Level, Suite P2 San Francisco, CA 94111 www.archengine.com 415.834.9002

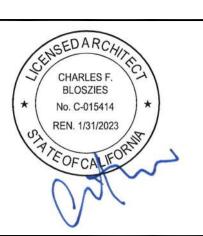

HOMEKEY Palo Alto
Supportive Interim Housing

1237 San Antonio Road Palo Alto, California

Graphic and written material appearing on this sheet constitutes original and unpublished work of the Architect. Copyright of this material is owned by the Architect and protected by the 1990 Architectural Works Copyright Act. Unauthorized duplication of this material, without written prior consent of the Architect, is prohibited.

File Name: 21016—A5.12.dwg Drawn By: Checked By: CB

Issues 2

Number Date Description

1 04.04.22 100% SCHEMATIC DESIGN


2 04.07.22 ARCH REVIEW BOARD SUBMITTAL


Revisions Number Date Description


DINING HALL EXTERIOR ELEVATIONS &

Date: APRIL 07, 2022

A5.12

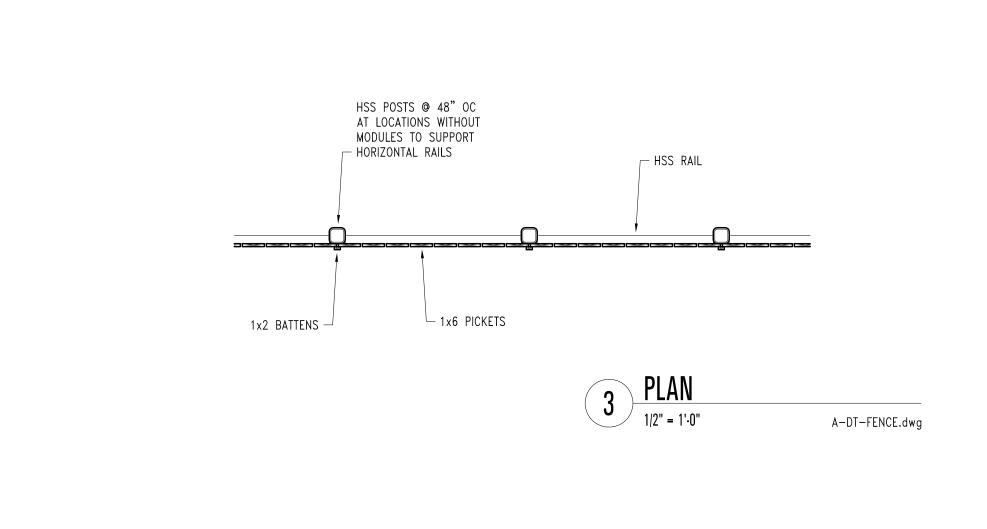

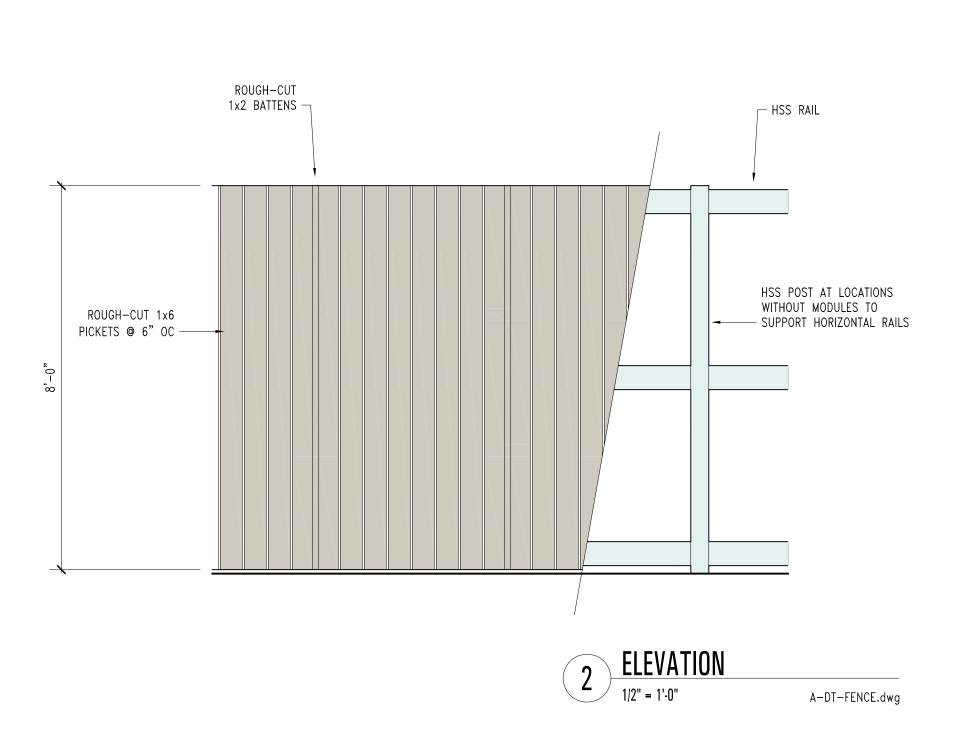

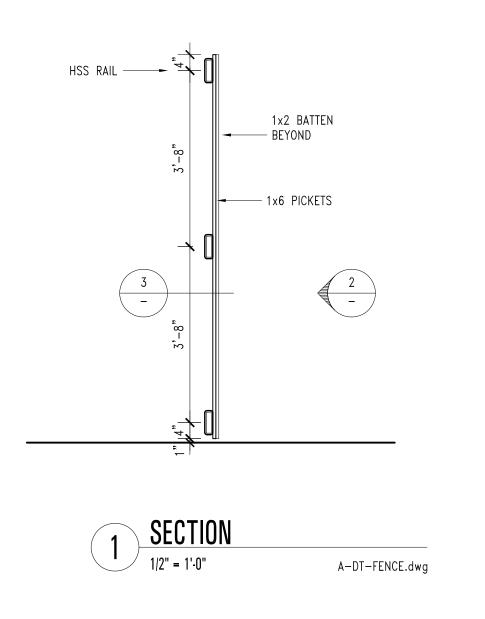

roject Number

21016.00

THE OFFICE OF

CHARLES F.

BLOSZIES FAIA

LTD

ARCHITECTURE | STRUCTURES

Three Embarcadero Center Promenade Level, Suite P2 San Francisco, CA 94111 www.archengine.com 415.834.9002

HOMEKEY Palo Alto
Supportive Interim Housing

1237 San Antonio Road Palo Alto, California

Graphic and written material appearing on this sheet constitutes original and unpublished work of the Architect. Copyright of this material is owned by the Architect and protected by the 1990 Architectural Works Copyright Act. Unauthorized duplication of this material, without written prior consent of the Architect, is prohibited.

Architectural Works Copyright Act. Unauthorized duplication of the material, without written prior consent of the Architect, is prohibited.

File Name:
21016—A8.21.dwg

Drawn By:
CB

Issues

2

Number Date

Description

1 04.04.22 100% SCHEMATIC DESIGN

2 04.07.22 ARCH REVIEW BOARD SUBMITTAL

Revisions


Number Date

Description

FENCE DETAILS

Date: APRIL 04, 2022

48.21

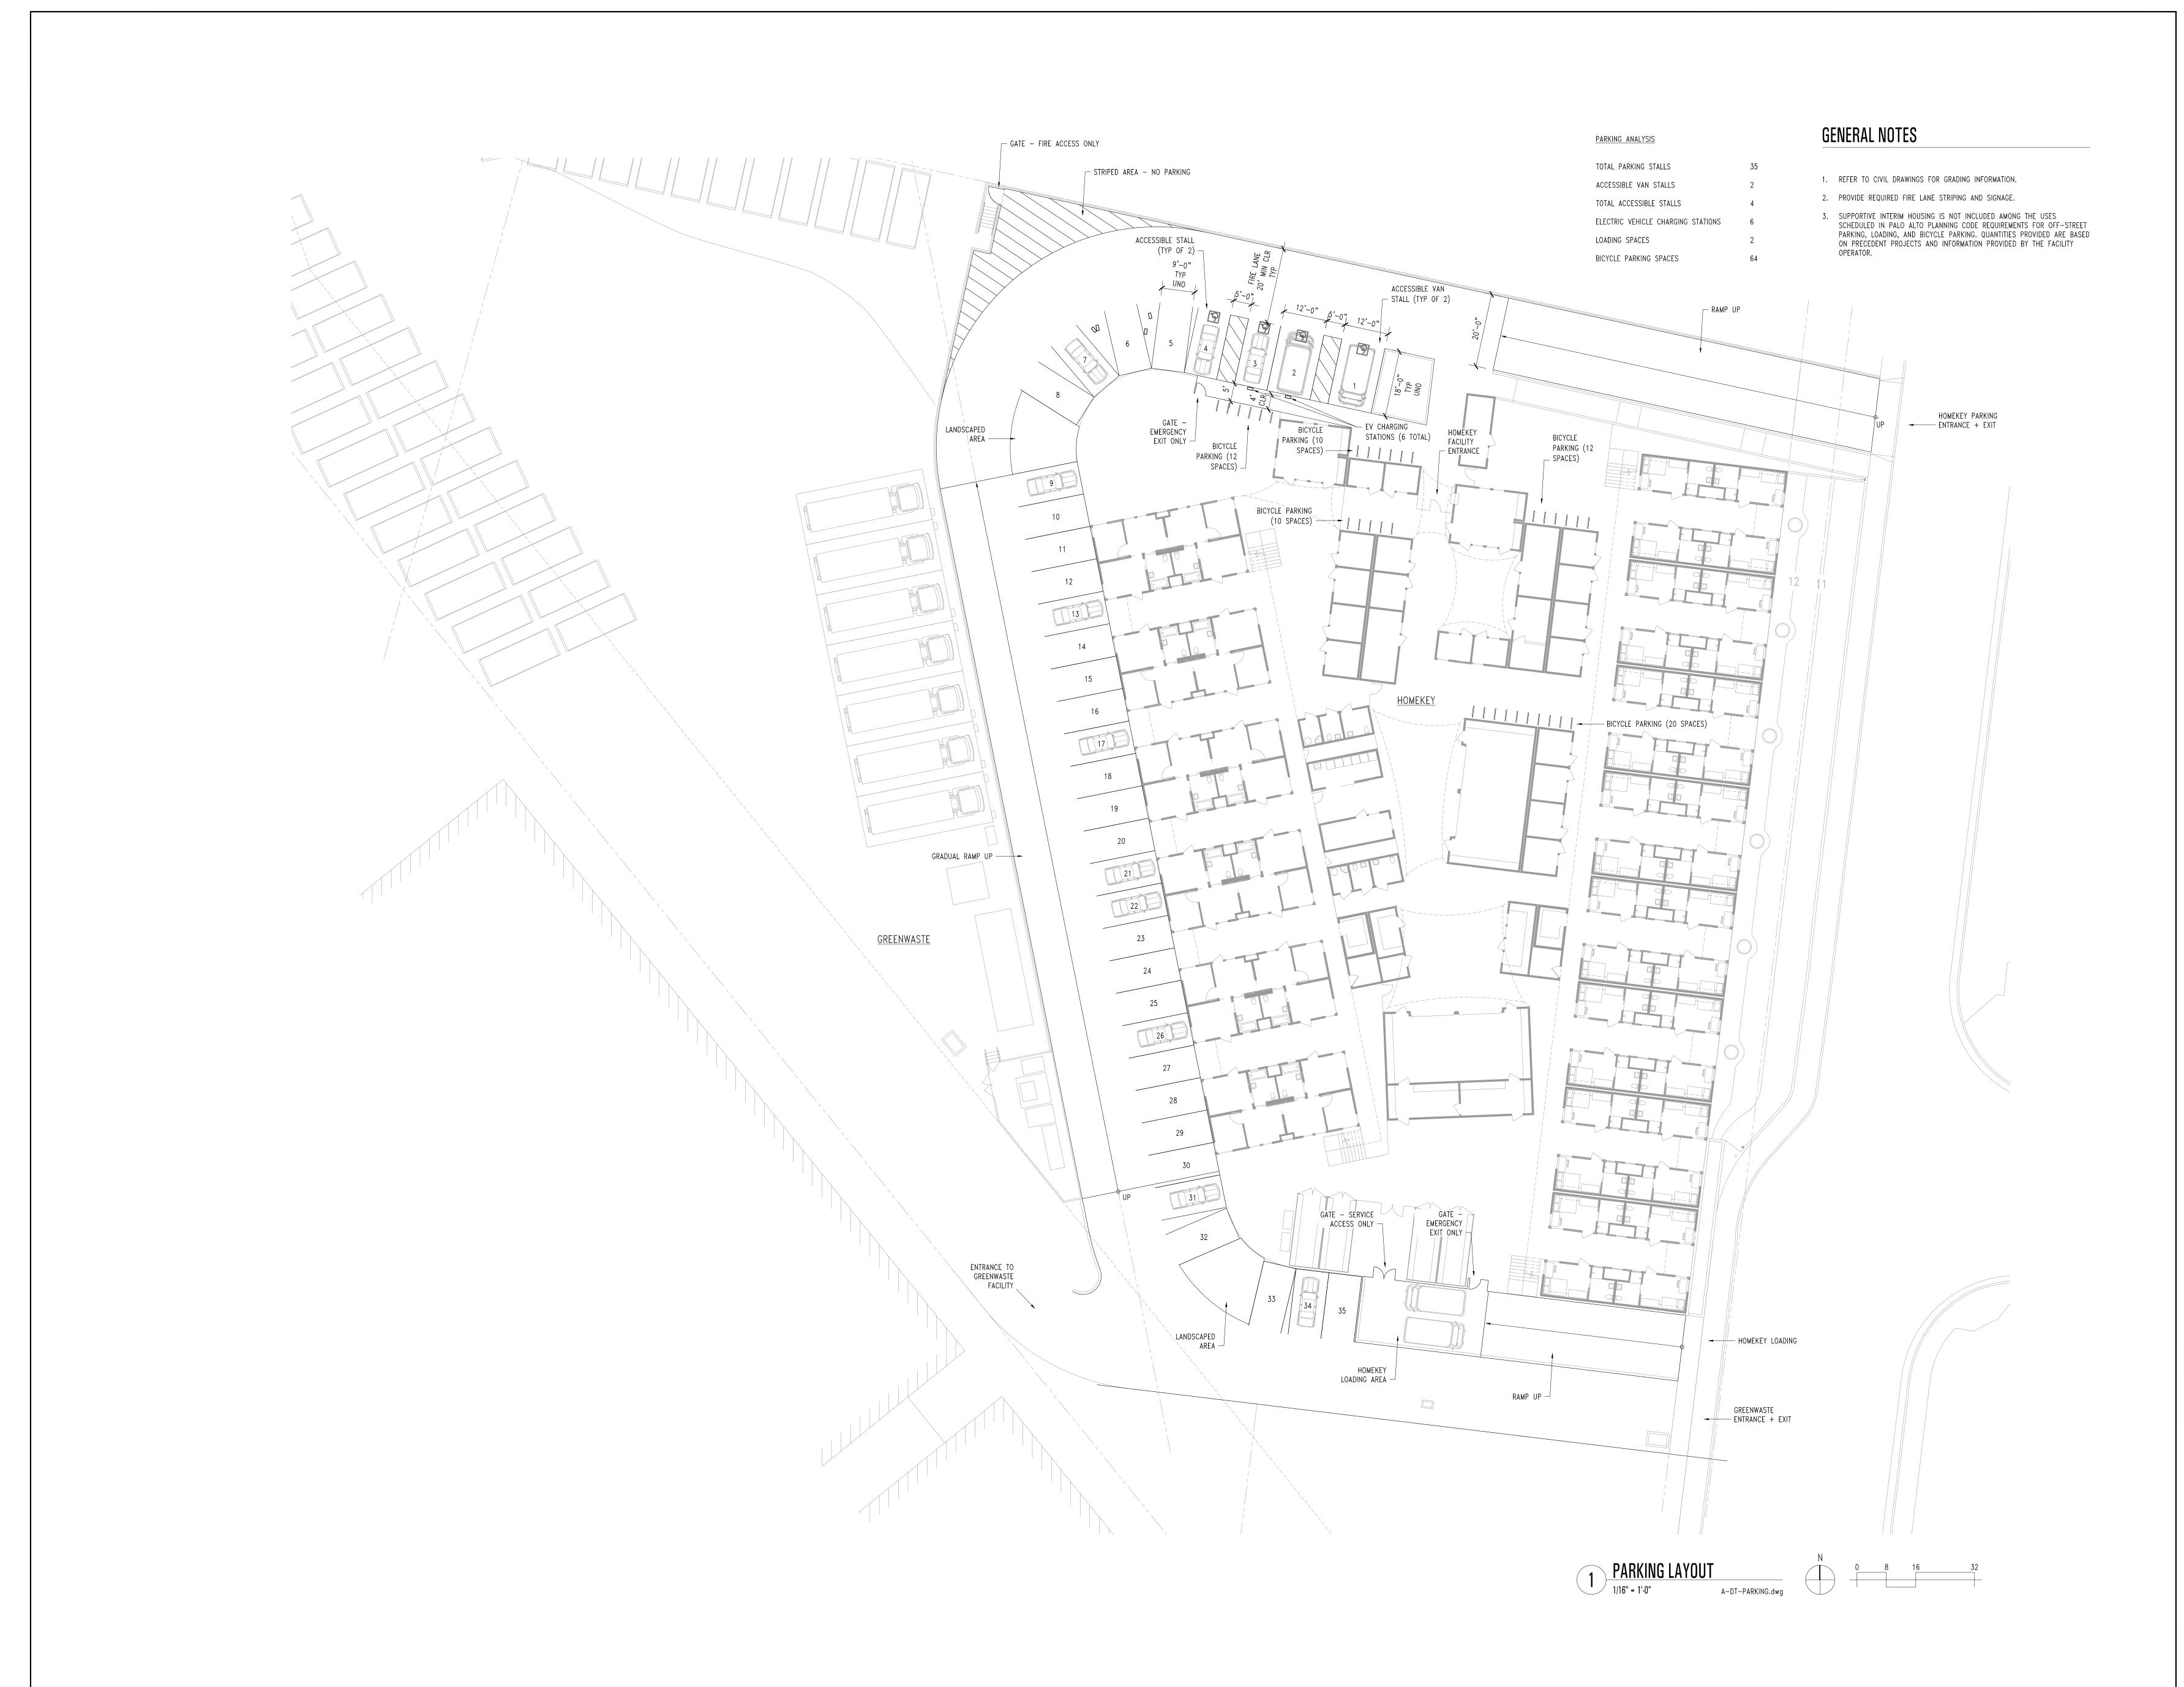

21

21016.00


THE OFFICE OF

CHARLES F.

BLOSZIES FAIA

ARCHITECTURE | STRUCTURES

Three Embarcadero Center Promenade Level, Suite P2 San Francisco, CA 94111 www.archengine.com 415.834.9002

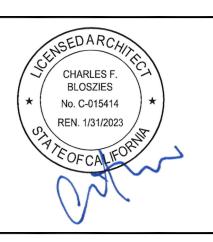

HOMEKEY Palo Alto
Supportive Interim Housing

1237 San Antonio Road Palo Alto, California


Graphic and written material appearing on this sheet constitutes original and unpublished work of the Architect. Copyright of this material is owned by the Architect and protected by the 1990 Architectural Works Copyright Act. Unauthorized duplication of this material, without written prior consent of the Architect, is prohibited.

materia	i, withou	it Writ	ten prior consent of the A	rchitect, is pronibited.	
ile Name 21016—		dwg	Drawn By: MW	Checked By: CB	
lss	ues	2			
Vumber	Date		Description		
1	04.04	4.22	100% SCHEMATIC DE	SIGN	
2	04.07	7.22	ARCH REVIEW BOARD	GUBMITTAL	
Re	visions	5			
Vumber	Date		Description		

PARKING LOT DETAILS

APRIL 07, 2022

A8.41

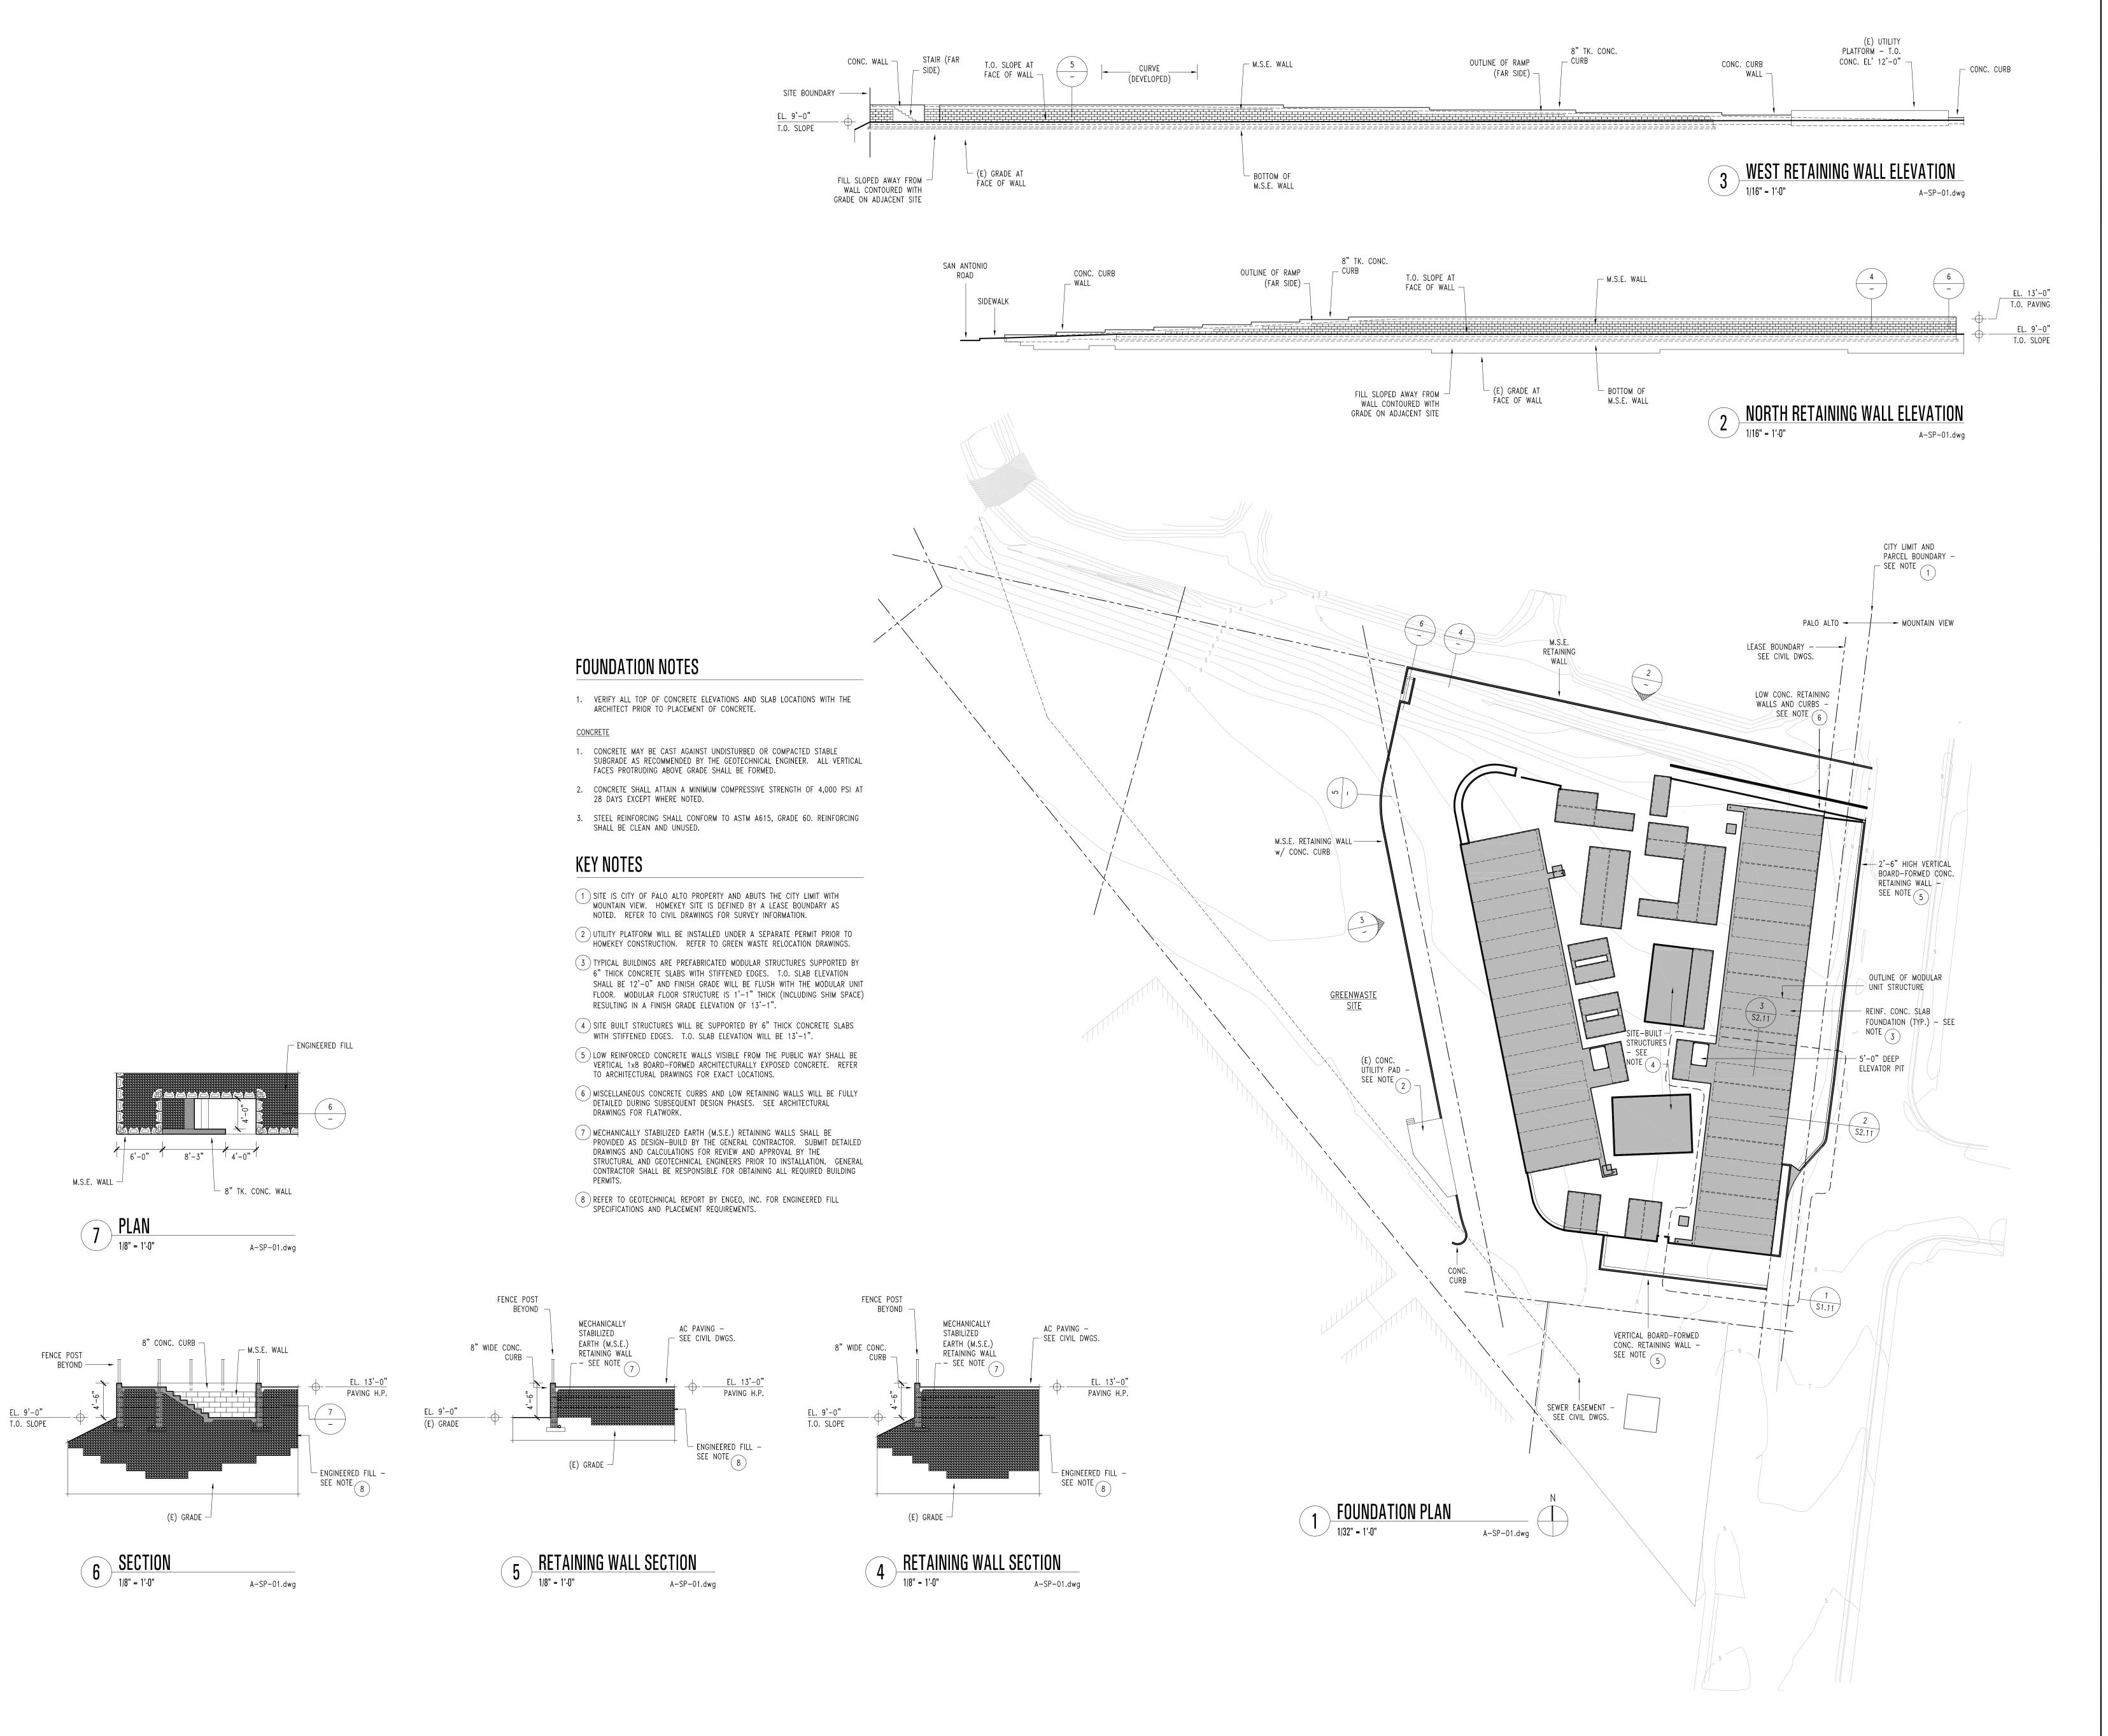

21016.00


THE OFFICE OF

CHARLES F.

BLOSZIES FAIA
LTD

ARCHITECTURE | STRUCTURES

Three Embarcadero Center Promenade Level, Suite P2 San Francisco, CA 94111 www.archengine.com 415.834.9002

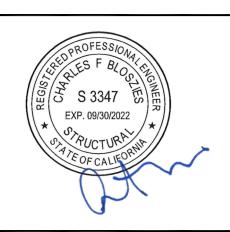

HOMEKEY Palo Alto
Supportive Interim Housing

1237 San Antonio Road Palo Alto, California


Graphic and written material appearing on this sheet constitutes original and unpublished work of the Architect. Copyright of this material is owned by the Architect and protected by the 1990 Architectural Works Copyright Act. Unauthorized duplication of this material, without written prior consent of the Architect, is prohibited.

File Namo 21016-	e: -S0.11.dwg	Drawn By: MW	Checked By: CB
lss	ues 2		
Number	Date	Description	
1	04.04.22	100% SCHEMATIC DE	SIGN
2	04.07.22	ARCH REVIEW BOARD	SUBMITTAL
Re	visions _		
Number	Date	Description	

FOUNDATION PLAN

APRIL 07, 2022

SO<sub>2</sub>11

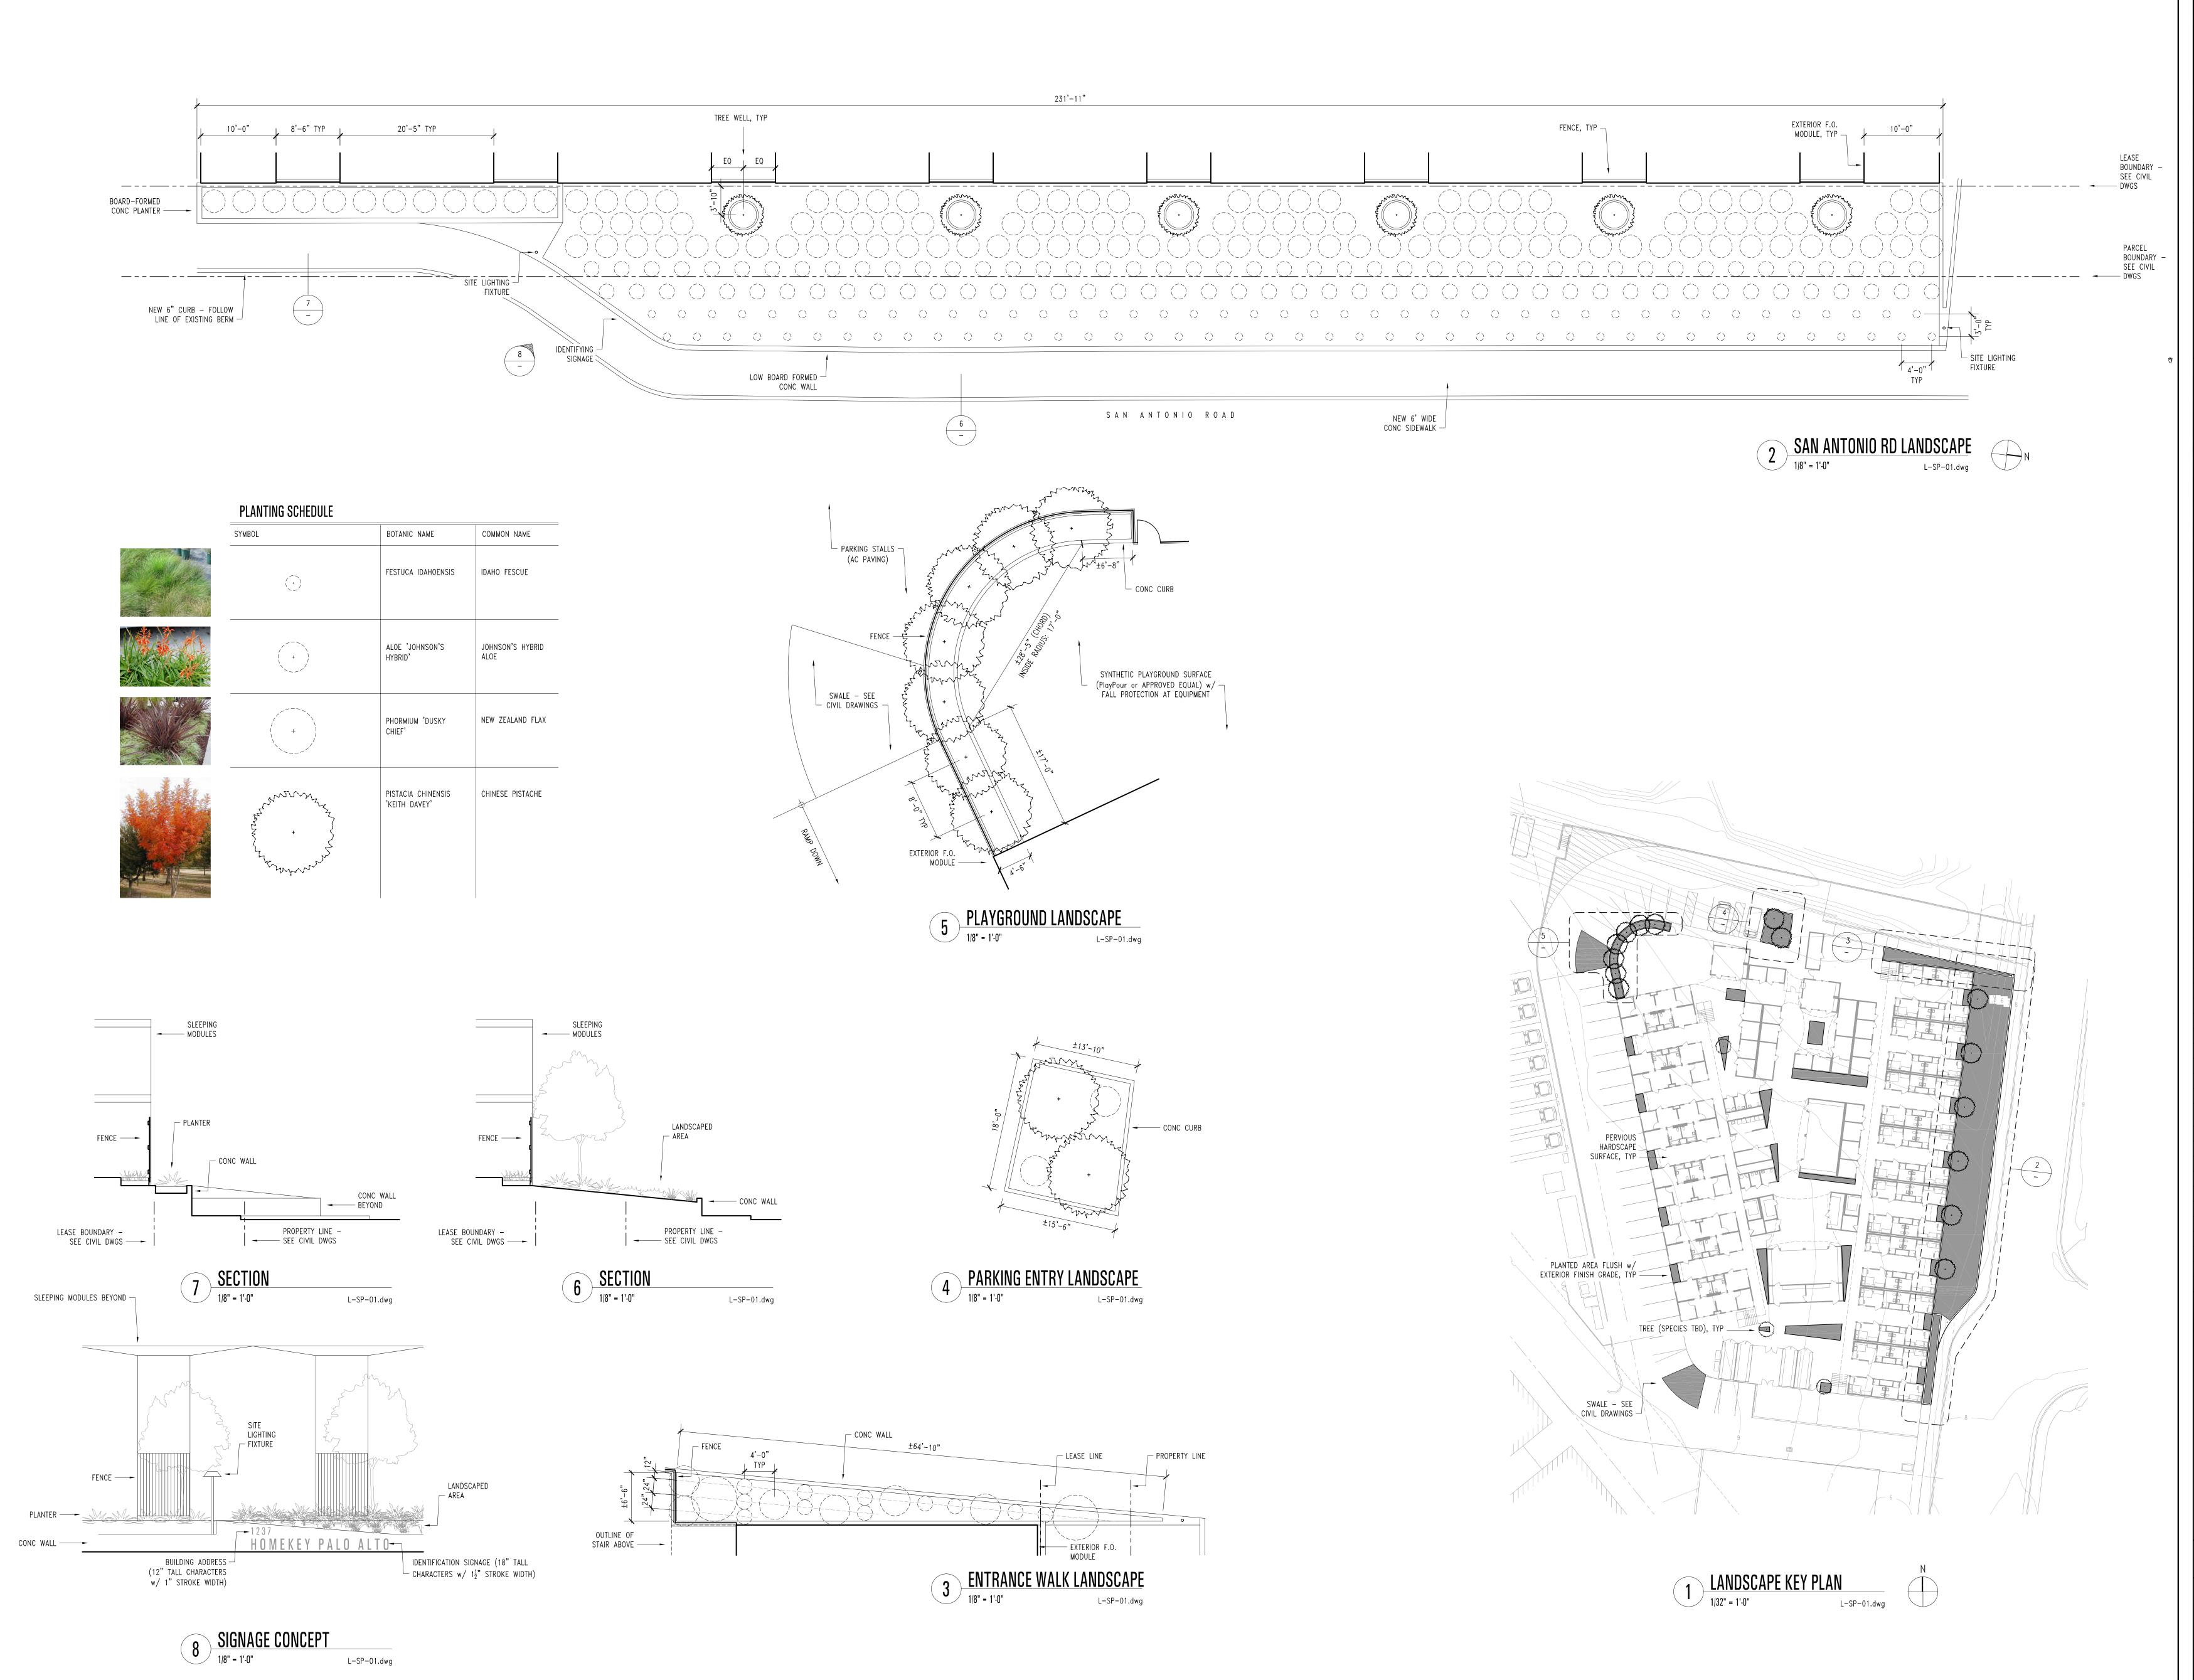


21016.00

THE OFFICE OF

CHARLES F

BLOSZIES F/

Three Embarcadero Center Promenade Level, Suite P2 San Francisco, CA 94111 www.archengine.com 415.834.9002

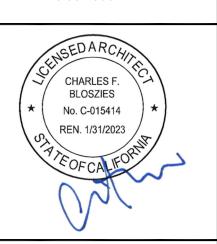

HOMEKEY Palo Alto
Supportive Interim Housing

1237 San Antonio Road Palo Alto, California

Graphic and written material appearing on this sheet constitutes original and unpublished work of the Architect. Copyright of this material is owned by the Architect and protected by the 1990 Architectural Works Copyright Act. Unauthorized duplication of this material, without written prior consent of the Architect, is prohibited.

File Name: 21016-L0.11.dwg			Drawn By: MW	Checked By: CB
Number	Date		Description	
1	04.04.22		100% SCHEMAT	IC DESIGN
2	04.07.22		ARCH REVIEW BO	ARD SUBMITTAL
Re	visions	<b>s</b> _		
Number	Date		Description	

LANDSCAPE PLAN

APRIL 07, 2022

L0.11