
ARB SUBMISSION TENANT IMPROVEMENT WORK FOR

L'CCCITANE EN PROVENCE

BOUTIQUE # 224 STANFORD SHOPPING CENTER

180 EL CAMINO REAL SPACE # 10B - BLDG. C PALO ALTO, CA 94304

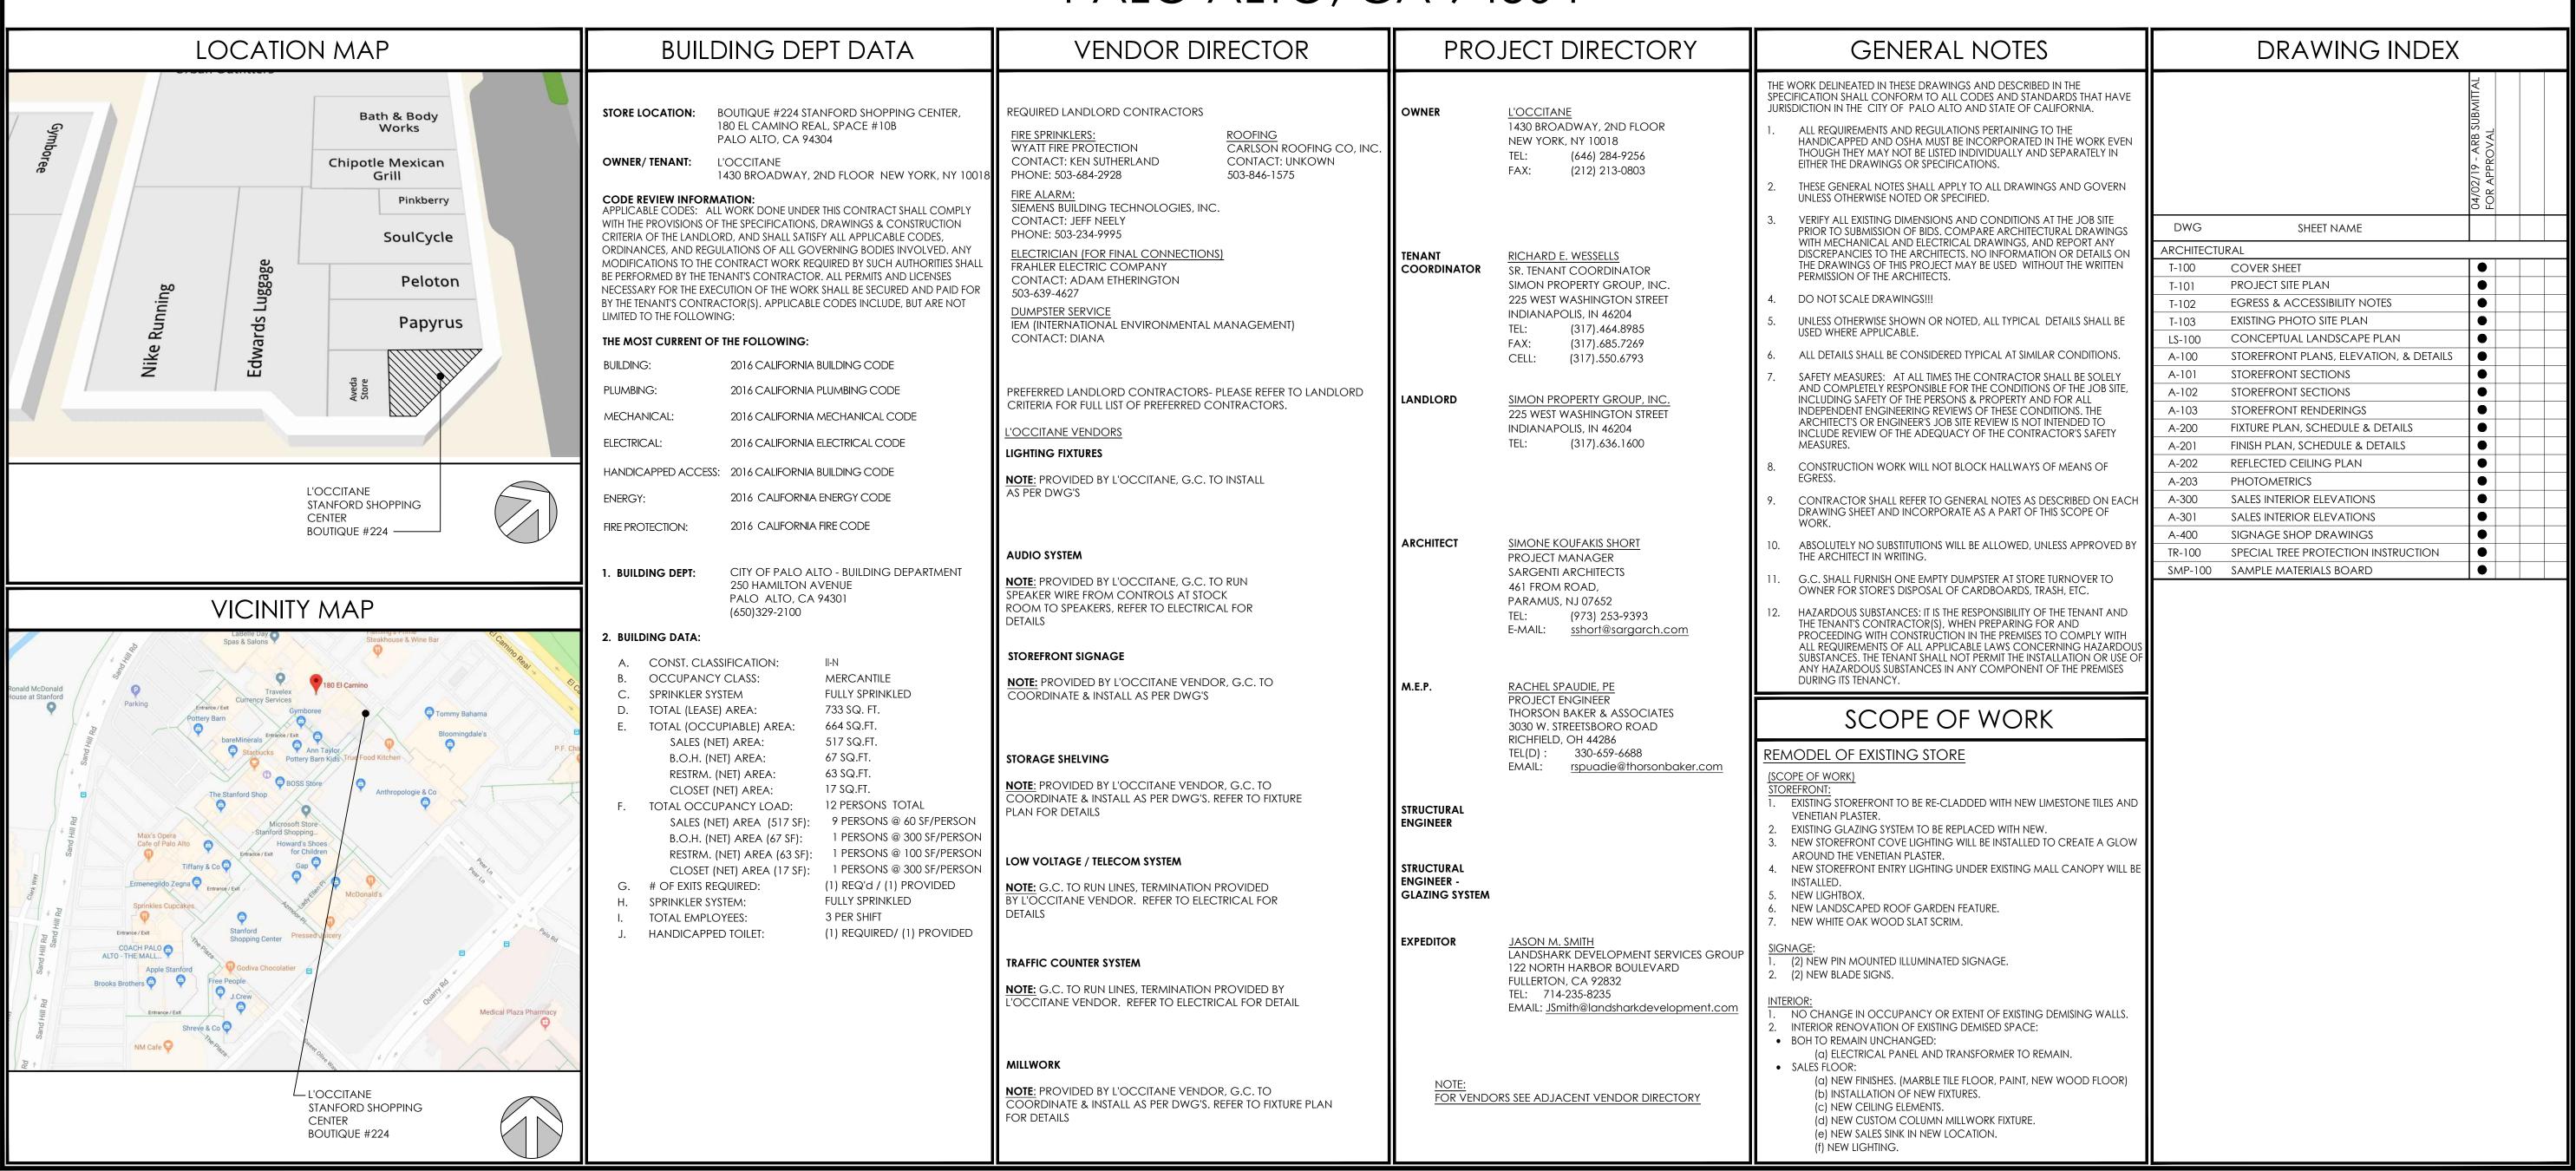



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ARCHITECTURAL SEAL

CONSULTANTS

DATE ISSUE

04/02/19 ARB INITIAL SUBMITTAL

DATE REVISION

L'OCCITANI EN PROVENCE

PROJECT NAME

ARB SUBMISSION
BOUTIQUE #224
STANFORD SHOPPING CENTER
SPACE #10B - BLDG. C
180 EL CAMINO REAL,
PALO ALTO, CA 94304

DATE: 03/29/2019
NO MEZZANINE ABOVE
PROJECT NO. 3274-18

PROJECT INFORMATION

 GROSS AREA:
 733 SQ. FT.

 NET AREA:
 664 SQ. FT.

 DRAWN BY:
 SJO


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 SKS/CS


SHEET TITLE

COVER SHEET

TITLE NUMBER

T-10C

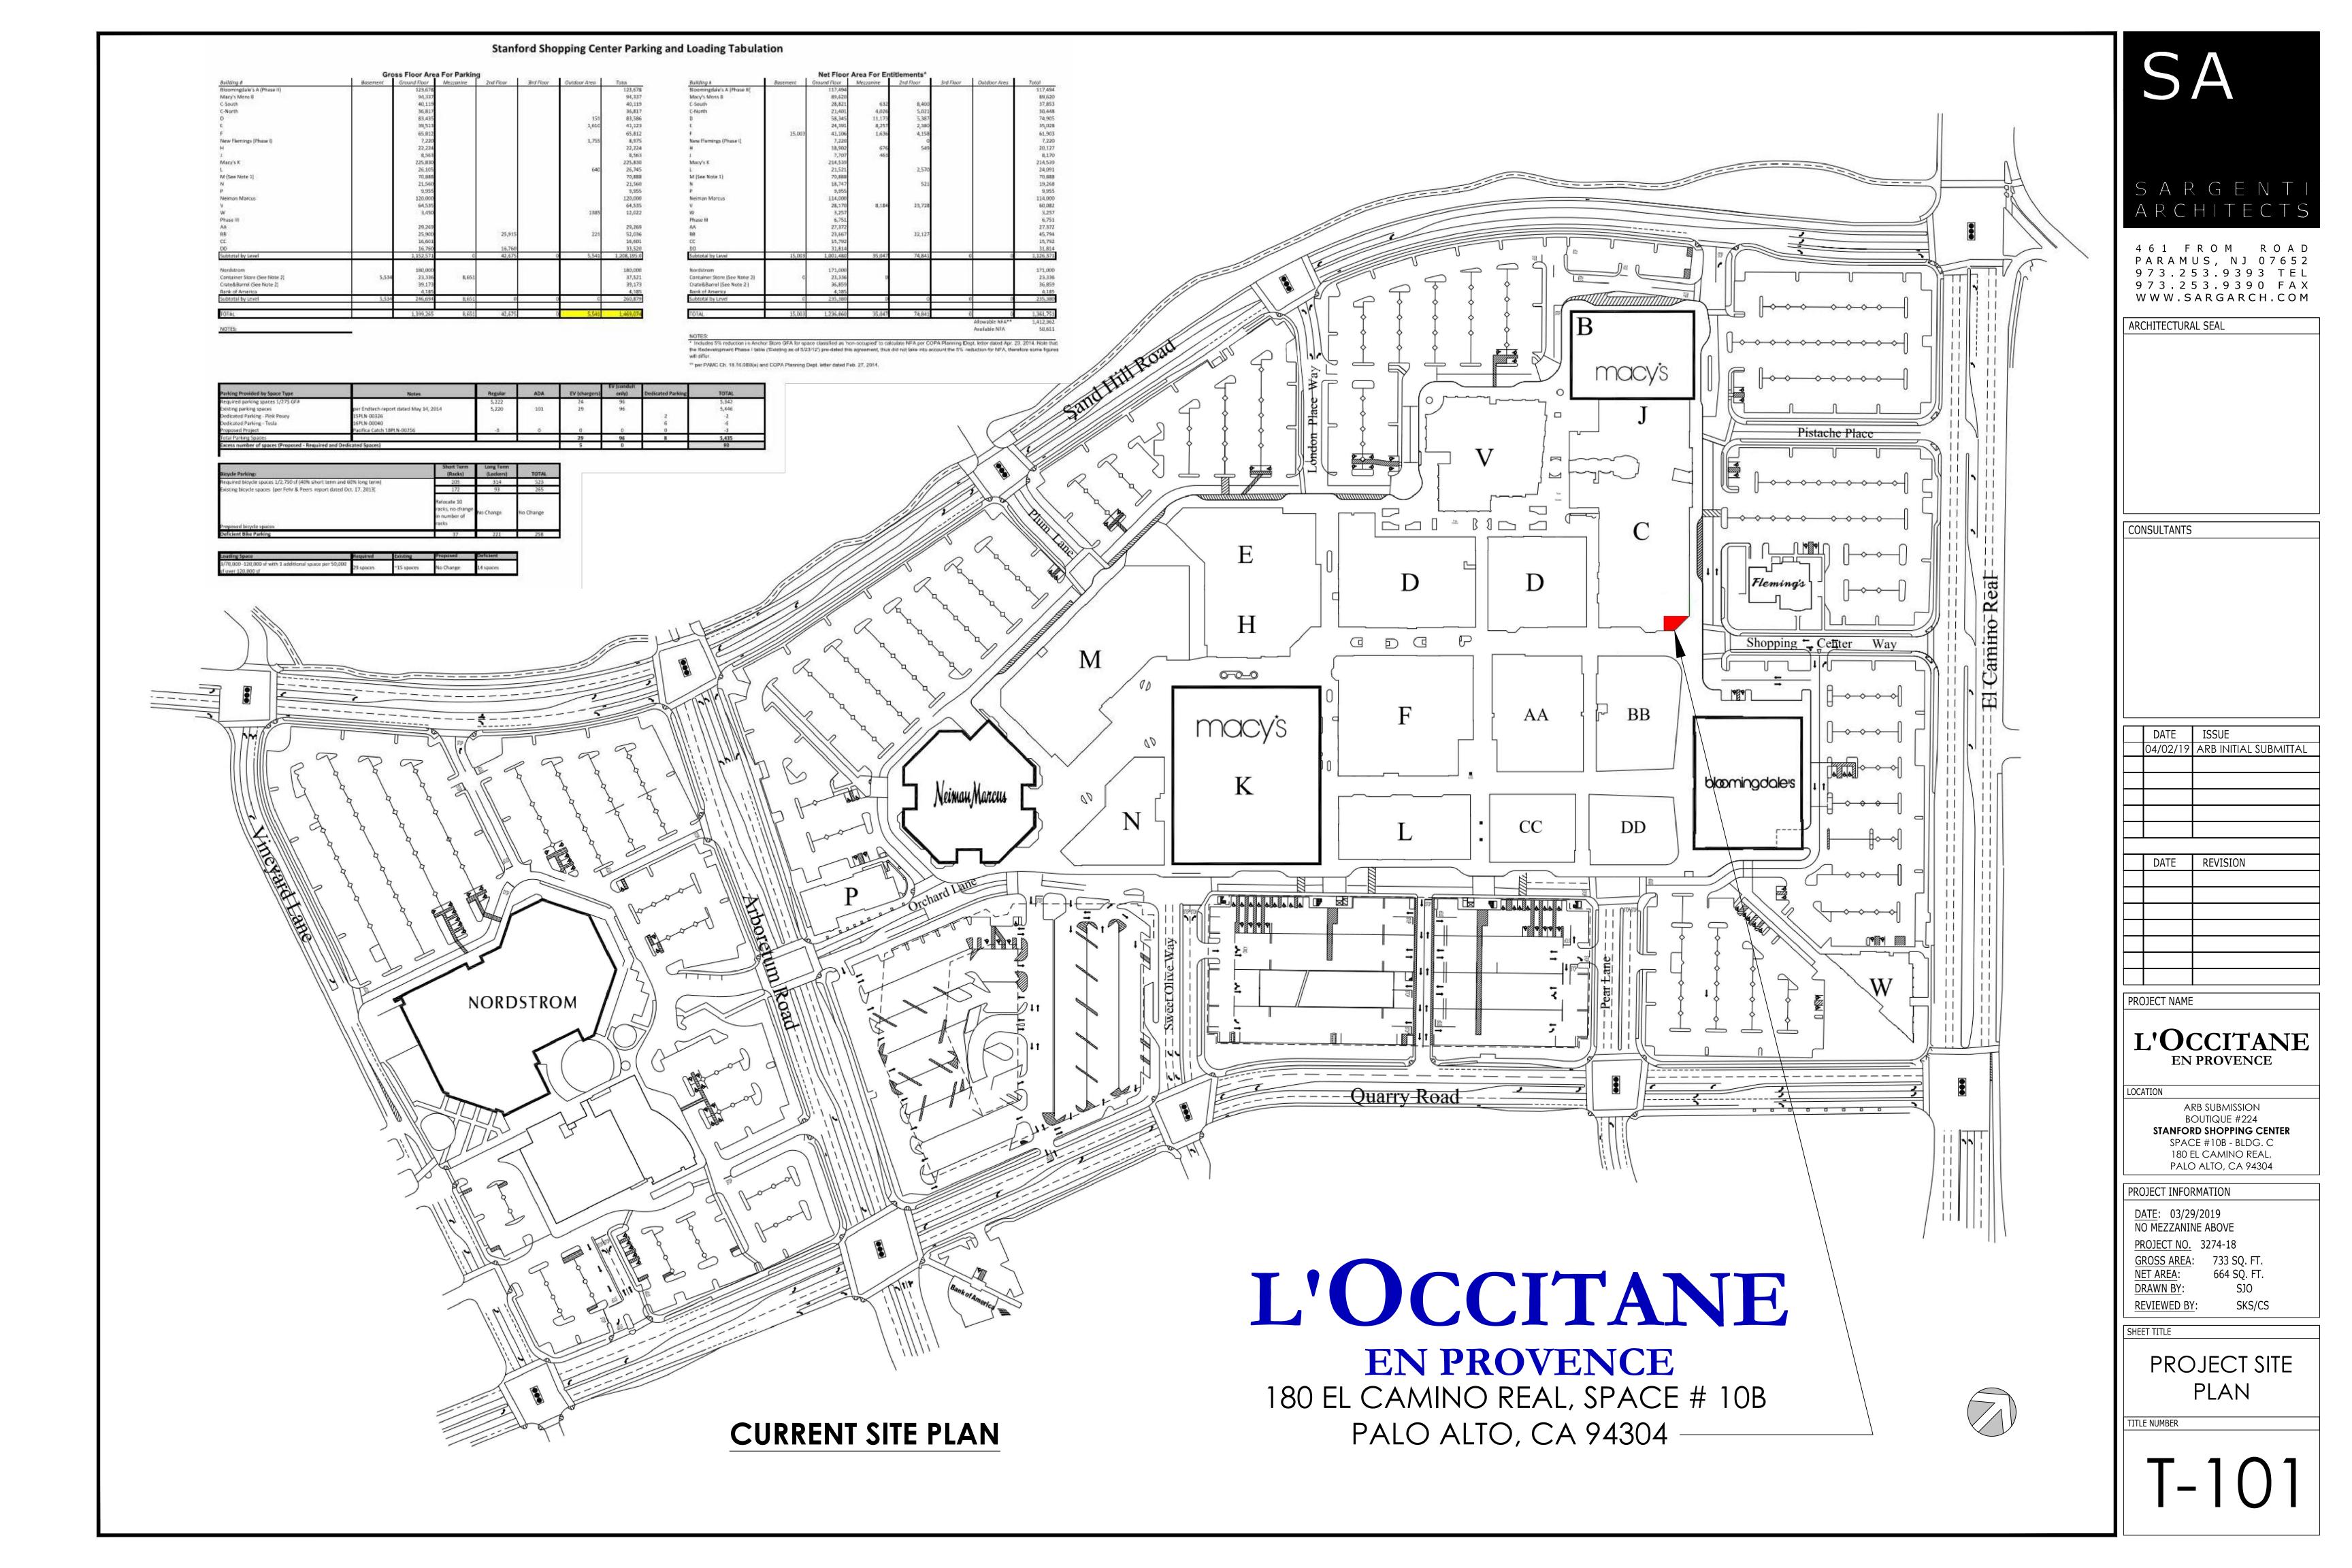

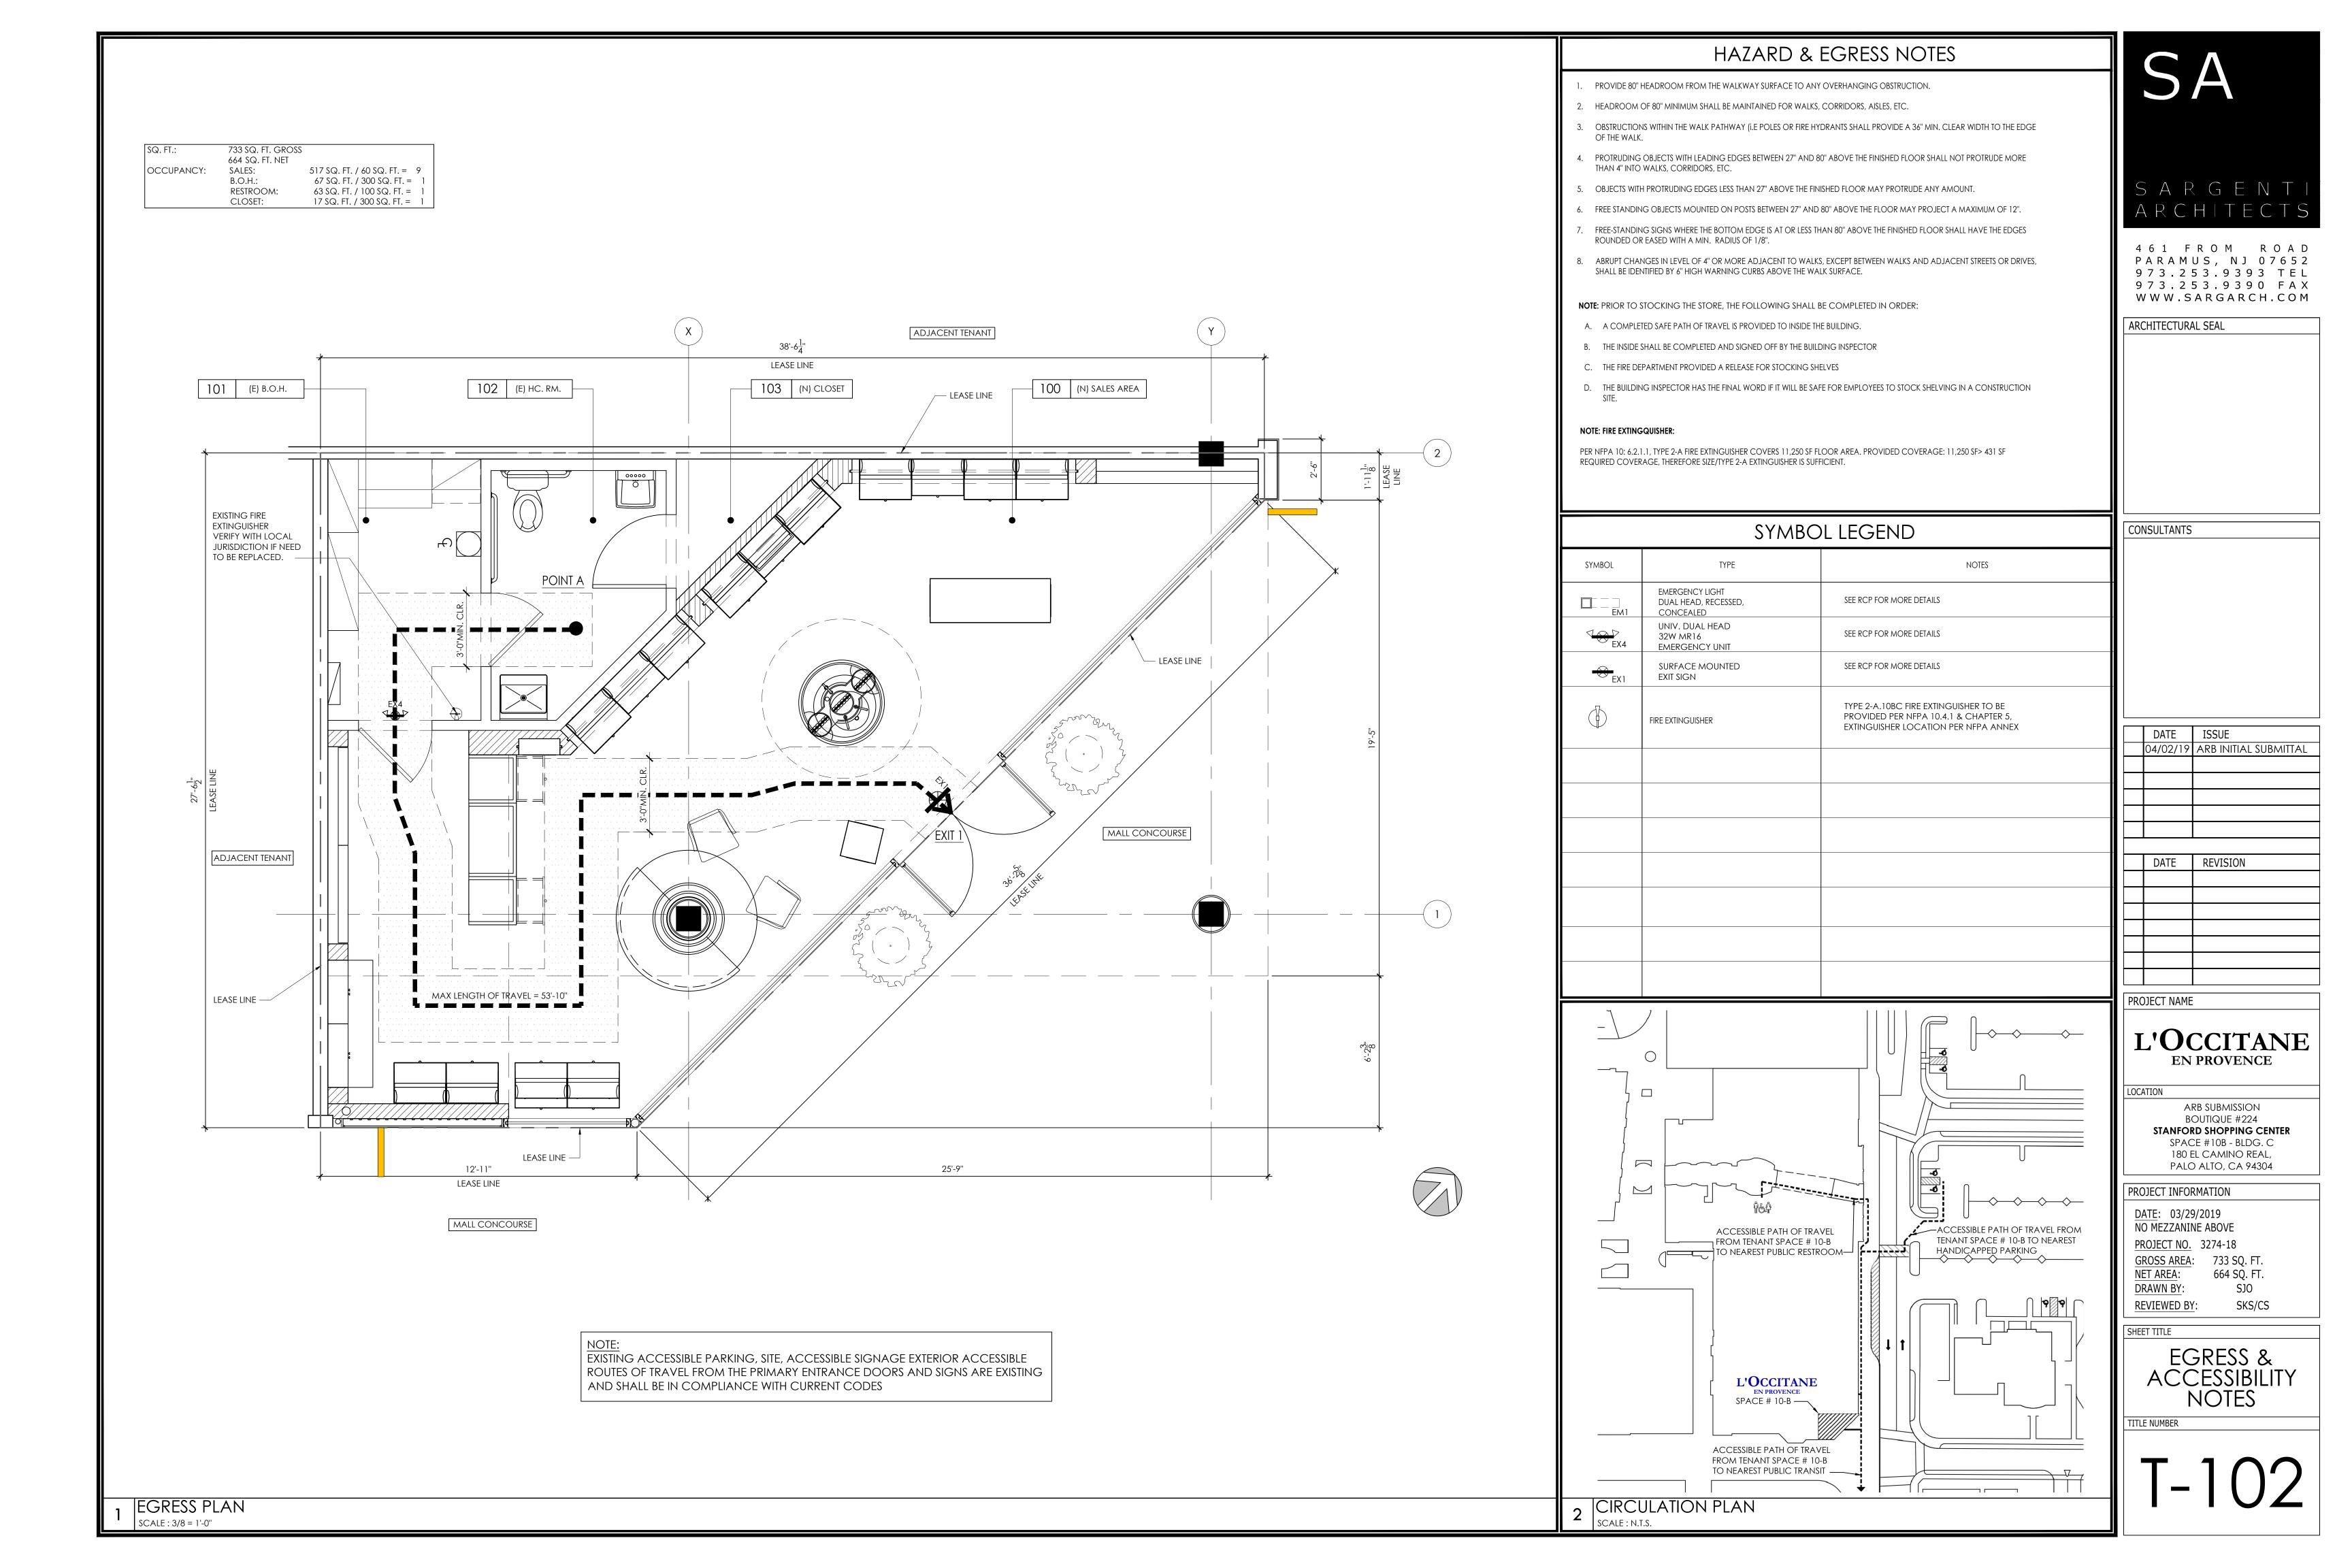





2 STOREFRONT ELEVATION

4 KEY PLAN SCALE: 1/4" = 1'-0" S A R G E N T I A R C H I T E C T S

4 6 1 F R O M R O A D P A R A M U S , N J 0 7 6 5 2 9 7 3 . 2 5 3 . 9 3 9 3 T E L 9 7 3 . 2 5 3 . 9 3 9 0 F A X W W W . S A R G A R C H . C O M

ARCHITECTURAL SEAL

CONSULTANTS

DATE ISSUE
08/28/18 PRELIM CLIENT REVIEW
09/04/18 PRELIM LL/EXP. REVIEW

DATE REVISION

01/11/19 PRELIM LL/RESUBMISSION

03/04/19 PRELIM LL/RESUBMISSION

PROJECT NAME

L'OCCITANE EN PROVENCE

LOCATION

BOUTIQUE #224

STANDFORD SHOPPING CENTER

SPACE #10B

180 EL CAMINO REAL,
PALO ALTO, CA 94304

PROJECT INFORMATION

<u>DATE</u>: 08/24/2018

<u>PROJECT NO.</u> 3274-18 <u>AREA</u>: 733 SQ. FT.

DRAWN BY: REVIEWED BY:

SHEET TITLE

EXISTING PHOTO SITE PLAN

SKS/CS


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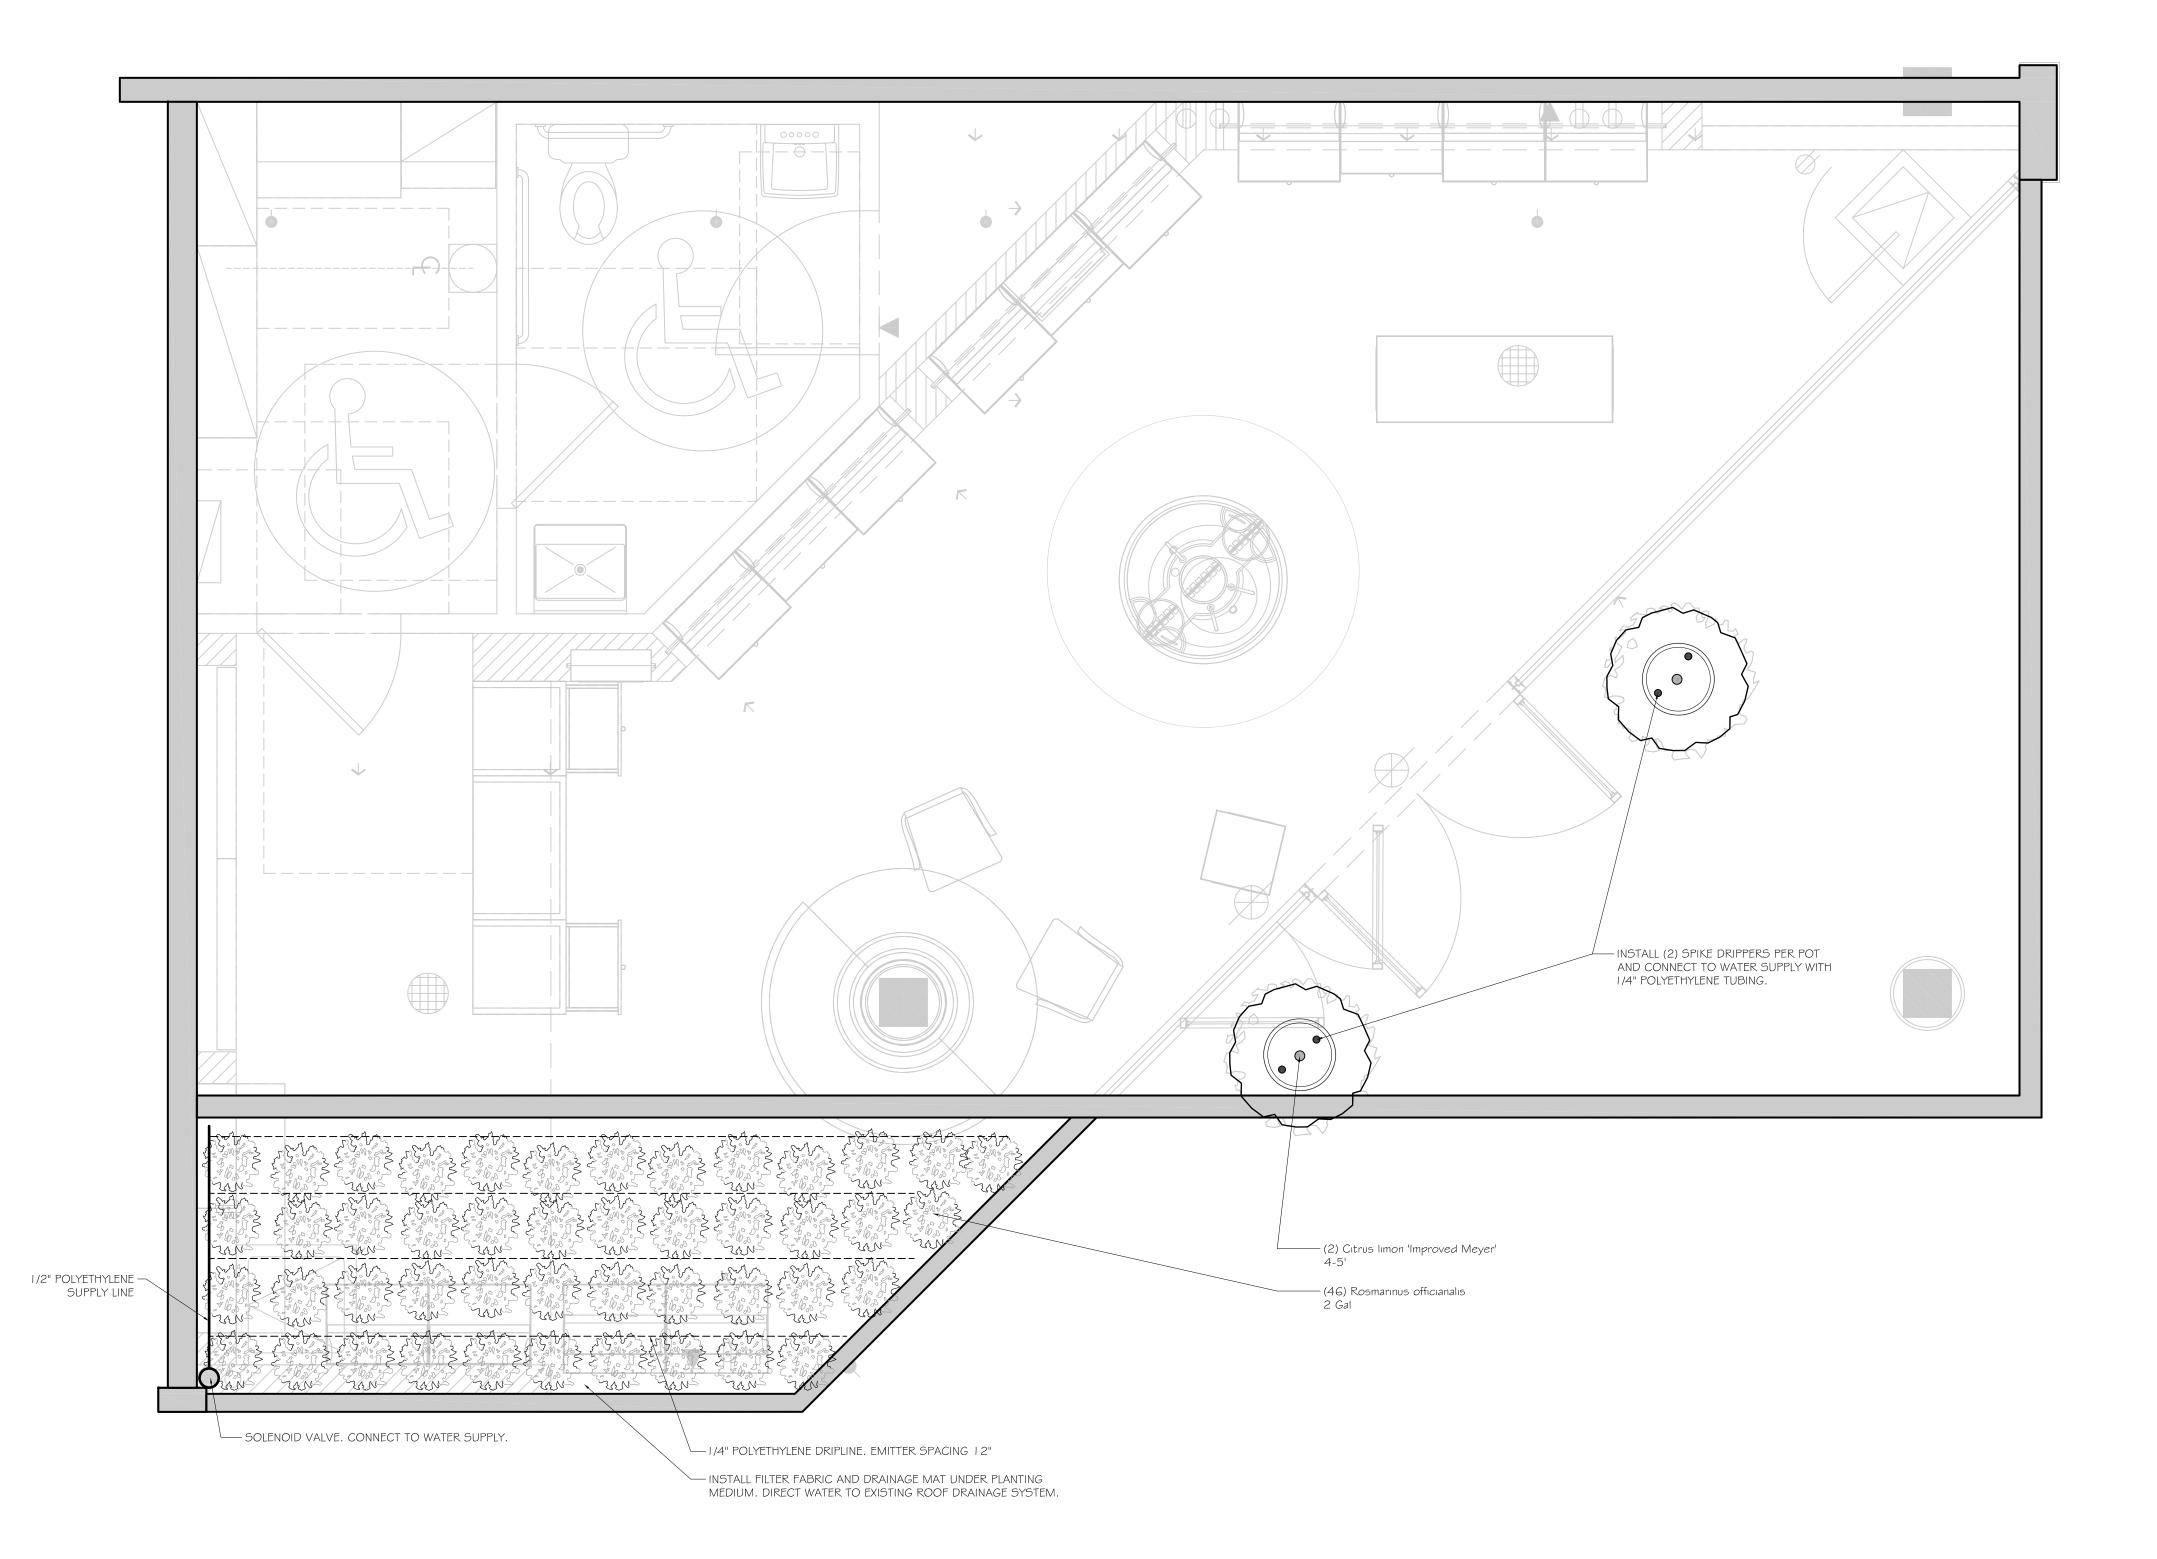
T-103



STOREFRONT ELEVATION ANGLED

STOREFRONT ELEVATION



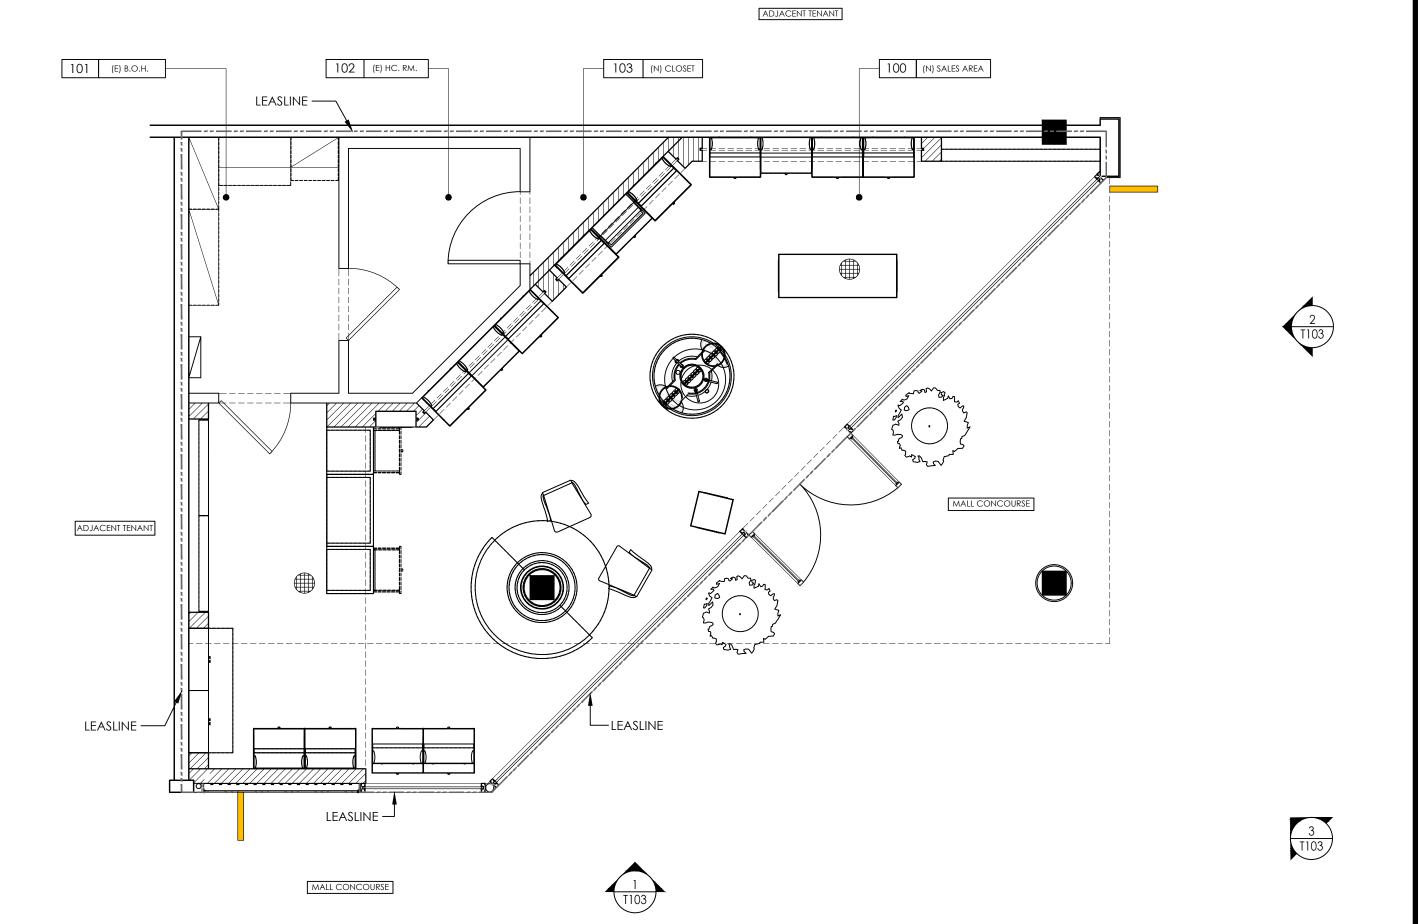

☐ IRRIGATION NOTES

- I. CONTINUOUSLY SELF-FLUSHING, PRESSURE COMPENSATING DRIPLINE TO BE USED AS IRRIGATION IN ROOF PLANTER.
- 2. ALL MAIN LINES TO BE 1/2" POLYETHYLENE TUBING AND ALL LATERAL LINES TO BE 1/4" POLYETHYLENE TUBING. HIDE FROM VIEW AS APPLICABLE.
- 3. ALL PLANTERS TO BE IRRIGATED WITH SPIKE DRIPPERS. HIDE SPIKE DRIPPERS AND TUBING FROM VIEW WHERE POSSIBLE.
- 5. NEW SYSTEM TO TIE INTO EXISTING WATER SOURCE.
- 7. ALL IRRIGATION MUST COMPLY WITH REQUIREMENTS OF THE LOCAL PLUMBING CODE.
- 8. INSTALL PIPING, VALVES, CONTROLS AND SPRINKLERS IN ACCORDANCE WITH MANUFACTURER'S WRITTEN INSTRUCTIONS.

□ PLANTING NOTES

- I. PLANT MATERIAL SHALL BE FURNISHED AND INSTALLED AS INDICATED; INCLUDING ALL LABOR, MATERIALS, PLANTS, EQUIPMENT, INCIDENTALS, AND CLEAN-UP.
- 2. THE CONTRACTOR SHALL BE RESPONSIBLE FOR PLANTING AT CORRECT GRADES AND ALIGNMENT.

POSSIBLE, THE CONTRACTOR SHALL PROTECT, IRRIGATE & CARE FOR STOCK NOT PLANTED.

- 3. PLANTS SHALL BE TYPICAL OF THEIR SPECIES AND VARIETY; HAVE NORMAL GROWTH HABITS; WELL DEVELOPED BRANCHES, DENSELY FOLIATED, VIGOROUS ROOT SYSTEMS AND BE FREE FROM DEFECTS AND INJURIES.
- 4. CONTRACTOR SHALL REPORT ANY SOIL OR DRAINAGE CONDITIONS CONSIDERED DETRIMENTAL TO THE GROWTH OF PLANT MATERIAL.
- 5. ALL PLANT MATERIAL SHALL BE GUARANTEED BY THE CONTRACTOR TO BE IN VIGOROUS GROWING CONDITION.
 PROVISIONS SHALL BE MADE FOR A GROWTH GUARANTEE OF AT LEAST ONE YEAR FROM THE DATE OF ACCEPTANCE FOR
 TREES AND SHRUBS. REPLACEMENTS SHALL BE MADE AT THE BEGINNING OF THE FIRST SUCCEEDING PLANTING SEASON. ALL
 REPLACEMENTS SHALL HAVE A GUARANTEE EQUAL TO THAT STATED ABOVE.
- REPLACEMENTS SHALL HAVE A GUARANTEE EQUAL TO THAT STATED ABOVE.

 G. INSOFAR AS IT IS PRACTICABLE, PLANT MATERIAL SHALL BE PLANTED ON THE DAY OF DELIVERY. IN THE EVENT THIS IS NOT
- 7. QUALITY AND SIZE OF PLANTS, SPREAD OF ROOTS, AND SIZE OF BALLS SHALL BE IN ACCORDANCE WITH ANSI 260 (REV. I 980) "AMERICAN STANDARD FOR NURSERY STOCK" AS PUBLISHED BY THE AMERICAN ASSOCIATION OF NURSERYMEN, INC.
- 8. PLANTS SHALL NOT BE BOUND WITH WIRE OR ROPE AT ANY TIME SO AS TO DAMAGE THE BARK OR BREAK BRANCHES. PLANTS SHALL BE HANDLED FROM THE BOTTOM OF THE BALL ONLY.
- 9. PLANTING OPERATIONS SHALL BE PERFORMED DURING PERIODS WITHIN THE PLANTING SEASON WHEN WEATHER AND SOIL CONDITIONS ARE SUITABLE AND IN ACCORDANCE WITH ACCEPTED LOCAL PRACTICE. PLANTS SHALL NOT BE INSTALLED IN TOPSOIL THAT IS IN A MUDDY OR FROZEN CONDITION.
- I O. SET ALL PLANTS PLUMB AND STRAIGHT. SET AT SUCH LEVEL THAT A NORMAL OR NATURAL RELATIONSHIP TO THE CROWN OF THE PLANT WITH THE GROUND SURFACE WILL BE ESTABLISHED. LOCATE PLANT IN THE CENTER OF THE PIT.
- I I. ALL INJURED ROOTS SHALL BE PRUNED UTILIZING CLEAN, SHARP TOOLS TO MAKE CLEAN ENDS BEFORE PLANTING.
- I 2. EACH TREE AND SHRUB SHALL BE PRUNED IN ACCORDANCE WITH STANDARD HORTICULTURAL PRACTICE TO PRESERVE NATURAL CHARACTER OF PLANT. PRUNING SHALL BE DONE WITH CLEAN, SHARP TOOLS.
- 13. ALL PLANTING BEDS SHALL BE MULCHED WITH 2" LAYER OF DOUBLE SHREDDED HARDWOOD BARK MULCH.

□ PLANTING SCHEDULE

	QTY	BOTANICAL NAME	COMMON NAME	SIZE	DROUGHT RESISTANT	NATIVE
TR	EES_					
	2	Citrus limon 'Improved Meyer'	Dwarf Meyer Lemon Tree	4-5'	NO	NO
SH	IRUBS					
	46	Rosmarınus officianalis	Rosemary	2 Gallon	YES	NO





Citrus limon 'Improved Meyer'


Citrus limon 'Improved Meyer'





Rosmarınus officianalis

Rosmarınus officianalis

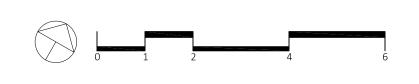

LS-100

SHEET NO.

Blythe M Yost ASLA | Registered Landscape Architect

PLANTING

PLAN

178 elizabeth st

pearl river, ny 10965 p 845.365.4595 | f 914.361.4473

yostdesign.com

DATE: MARCH 27, 2019

FILENAME: 2019_0327 Palo Alto

DRAWN BY: ZJS


REVISIONS:


JOB NO: 032719 SCALE: 1/2" = 1'-0"

SURVEYOR:

SHEET: I of

TO SCALE WHEN PLOTTED ON 24x36
PROGRESS SET NOT FOR CONSTRUCTION

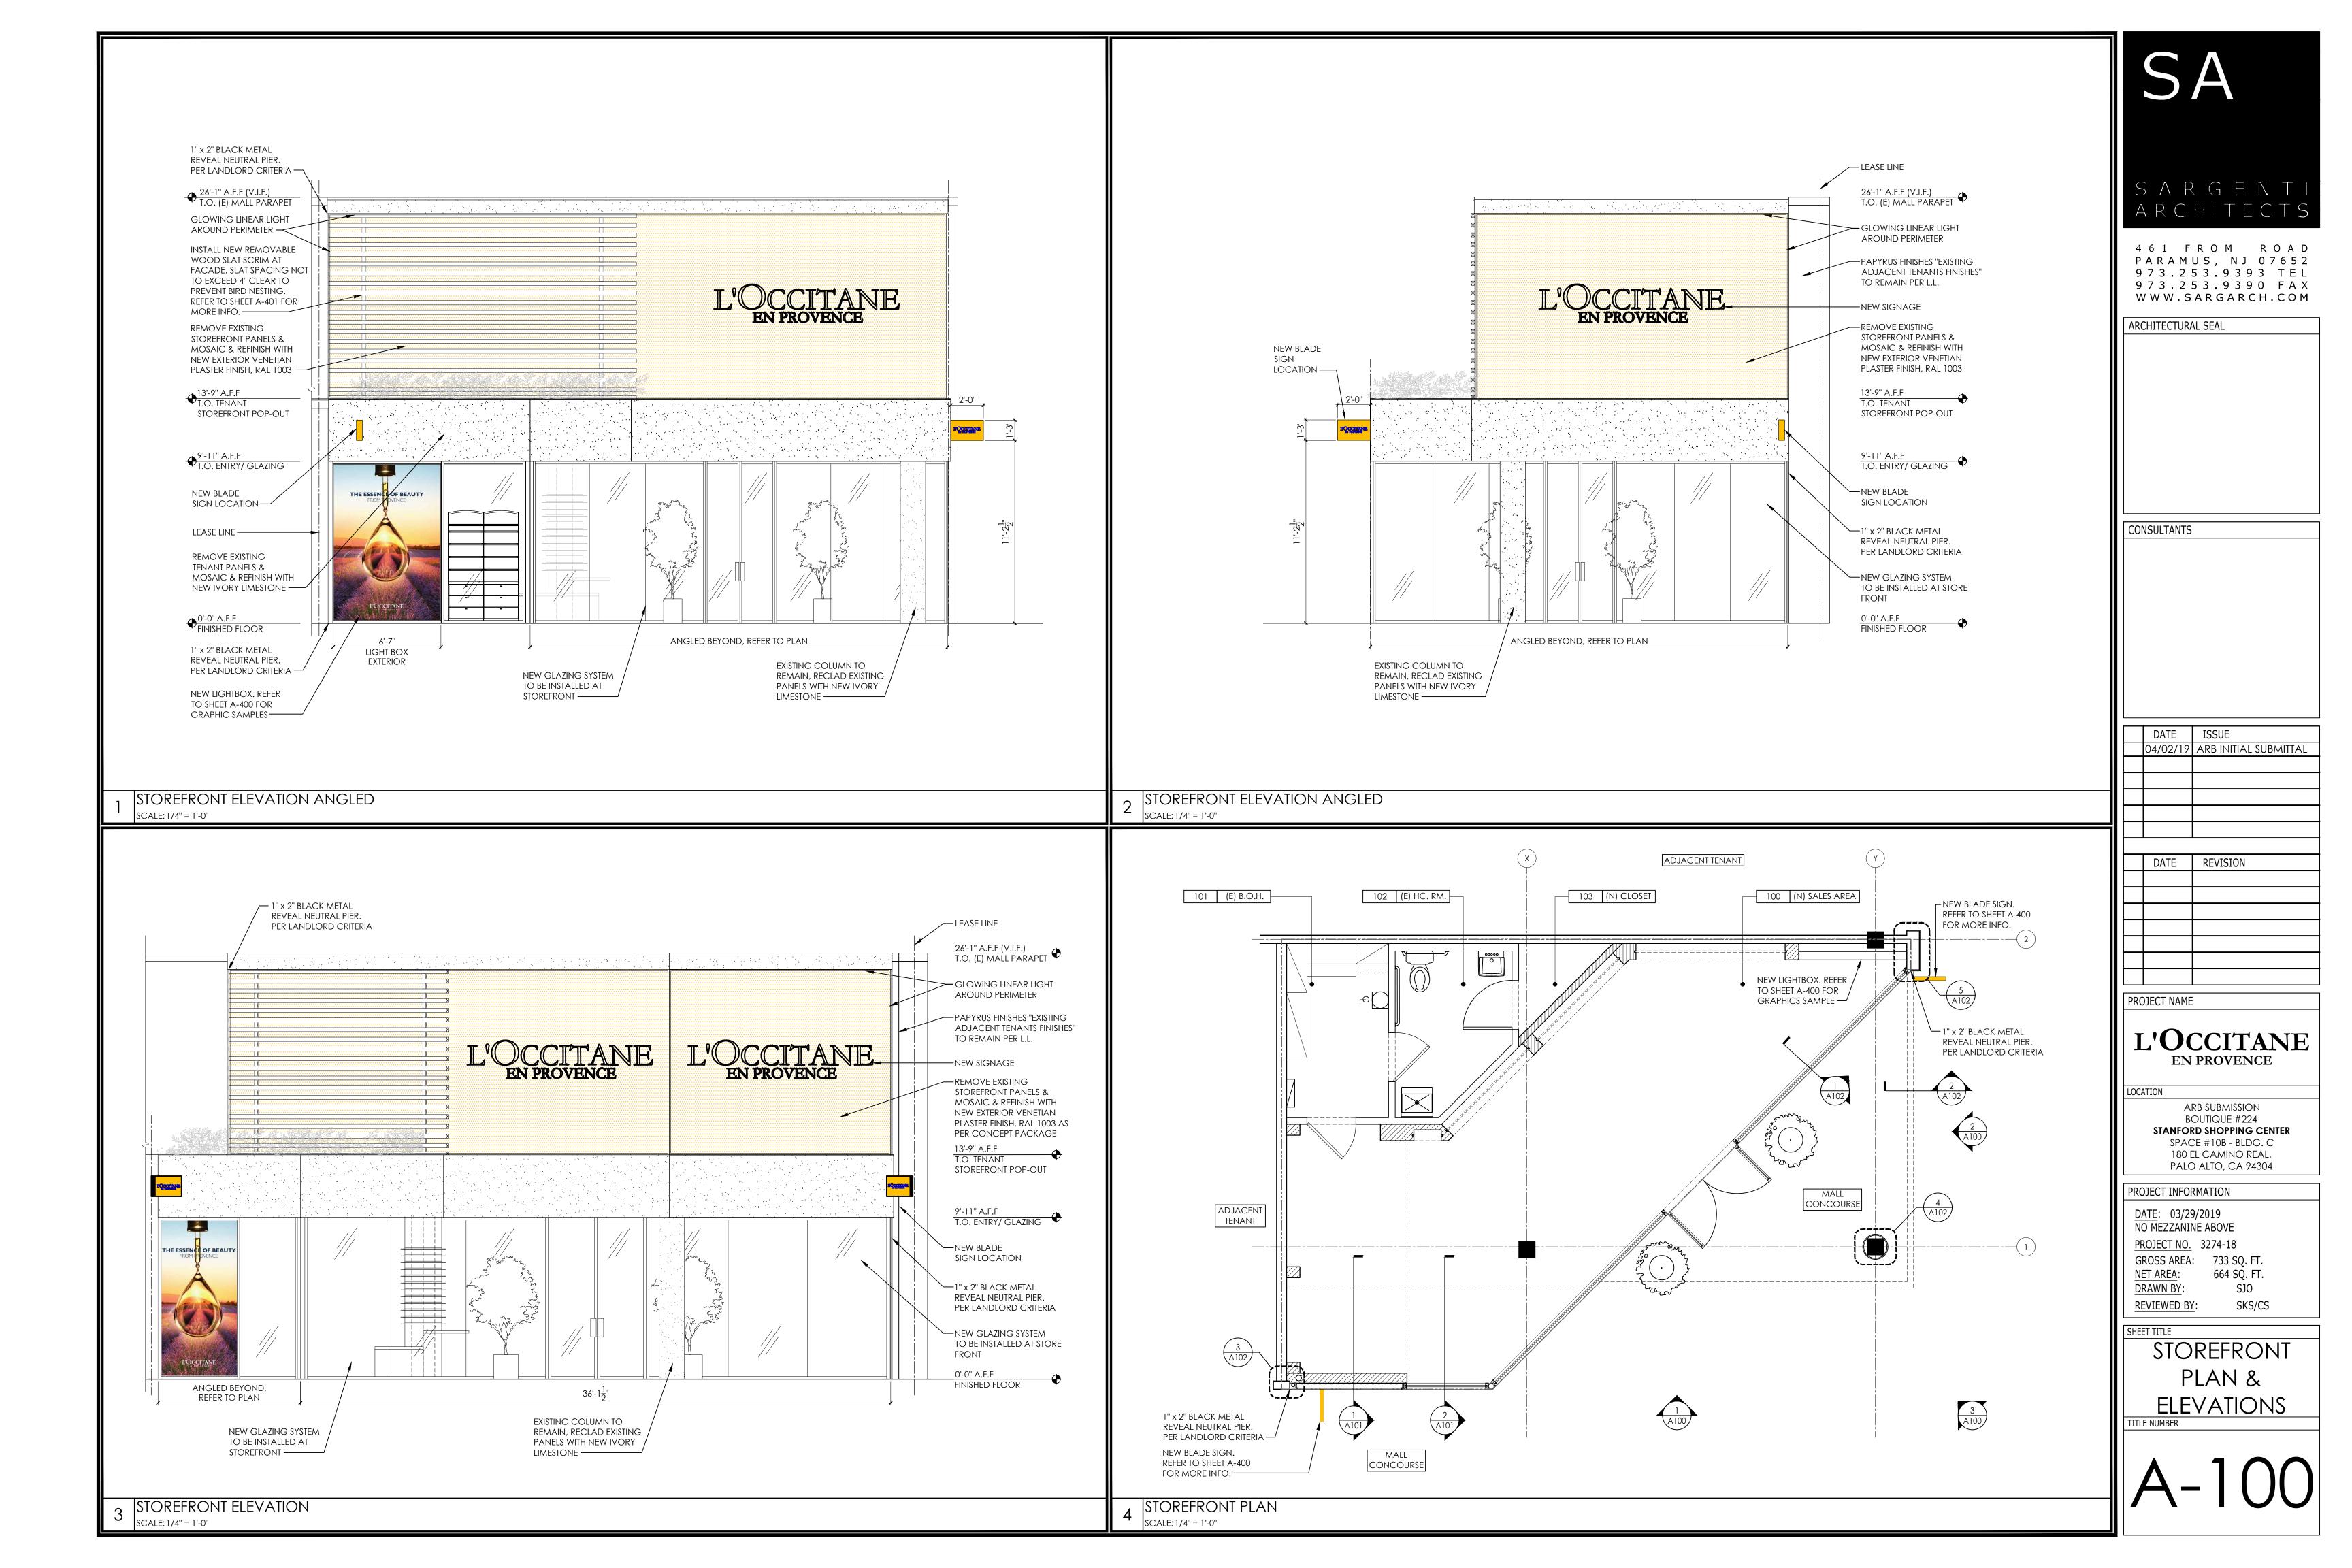

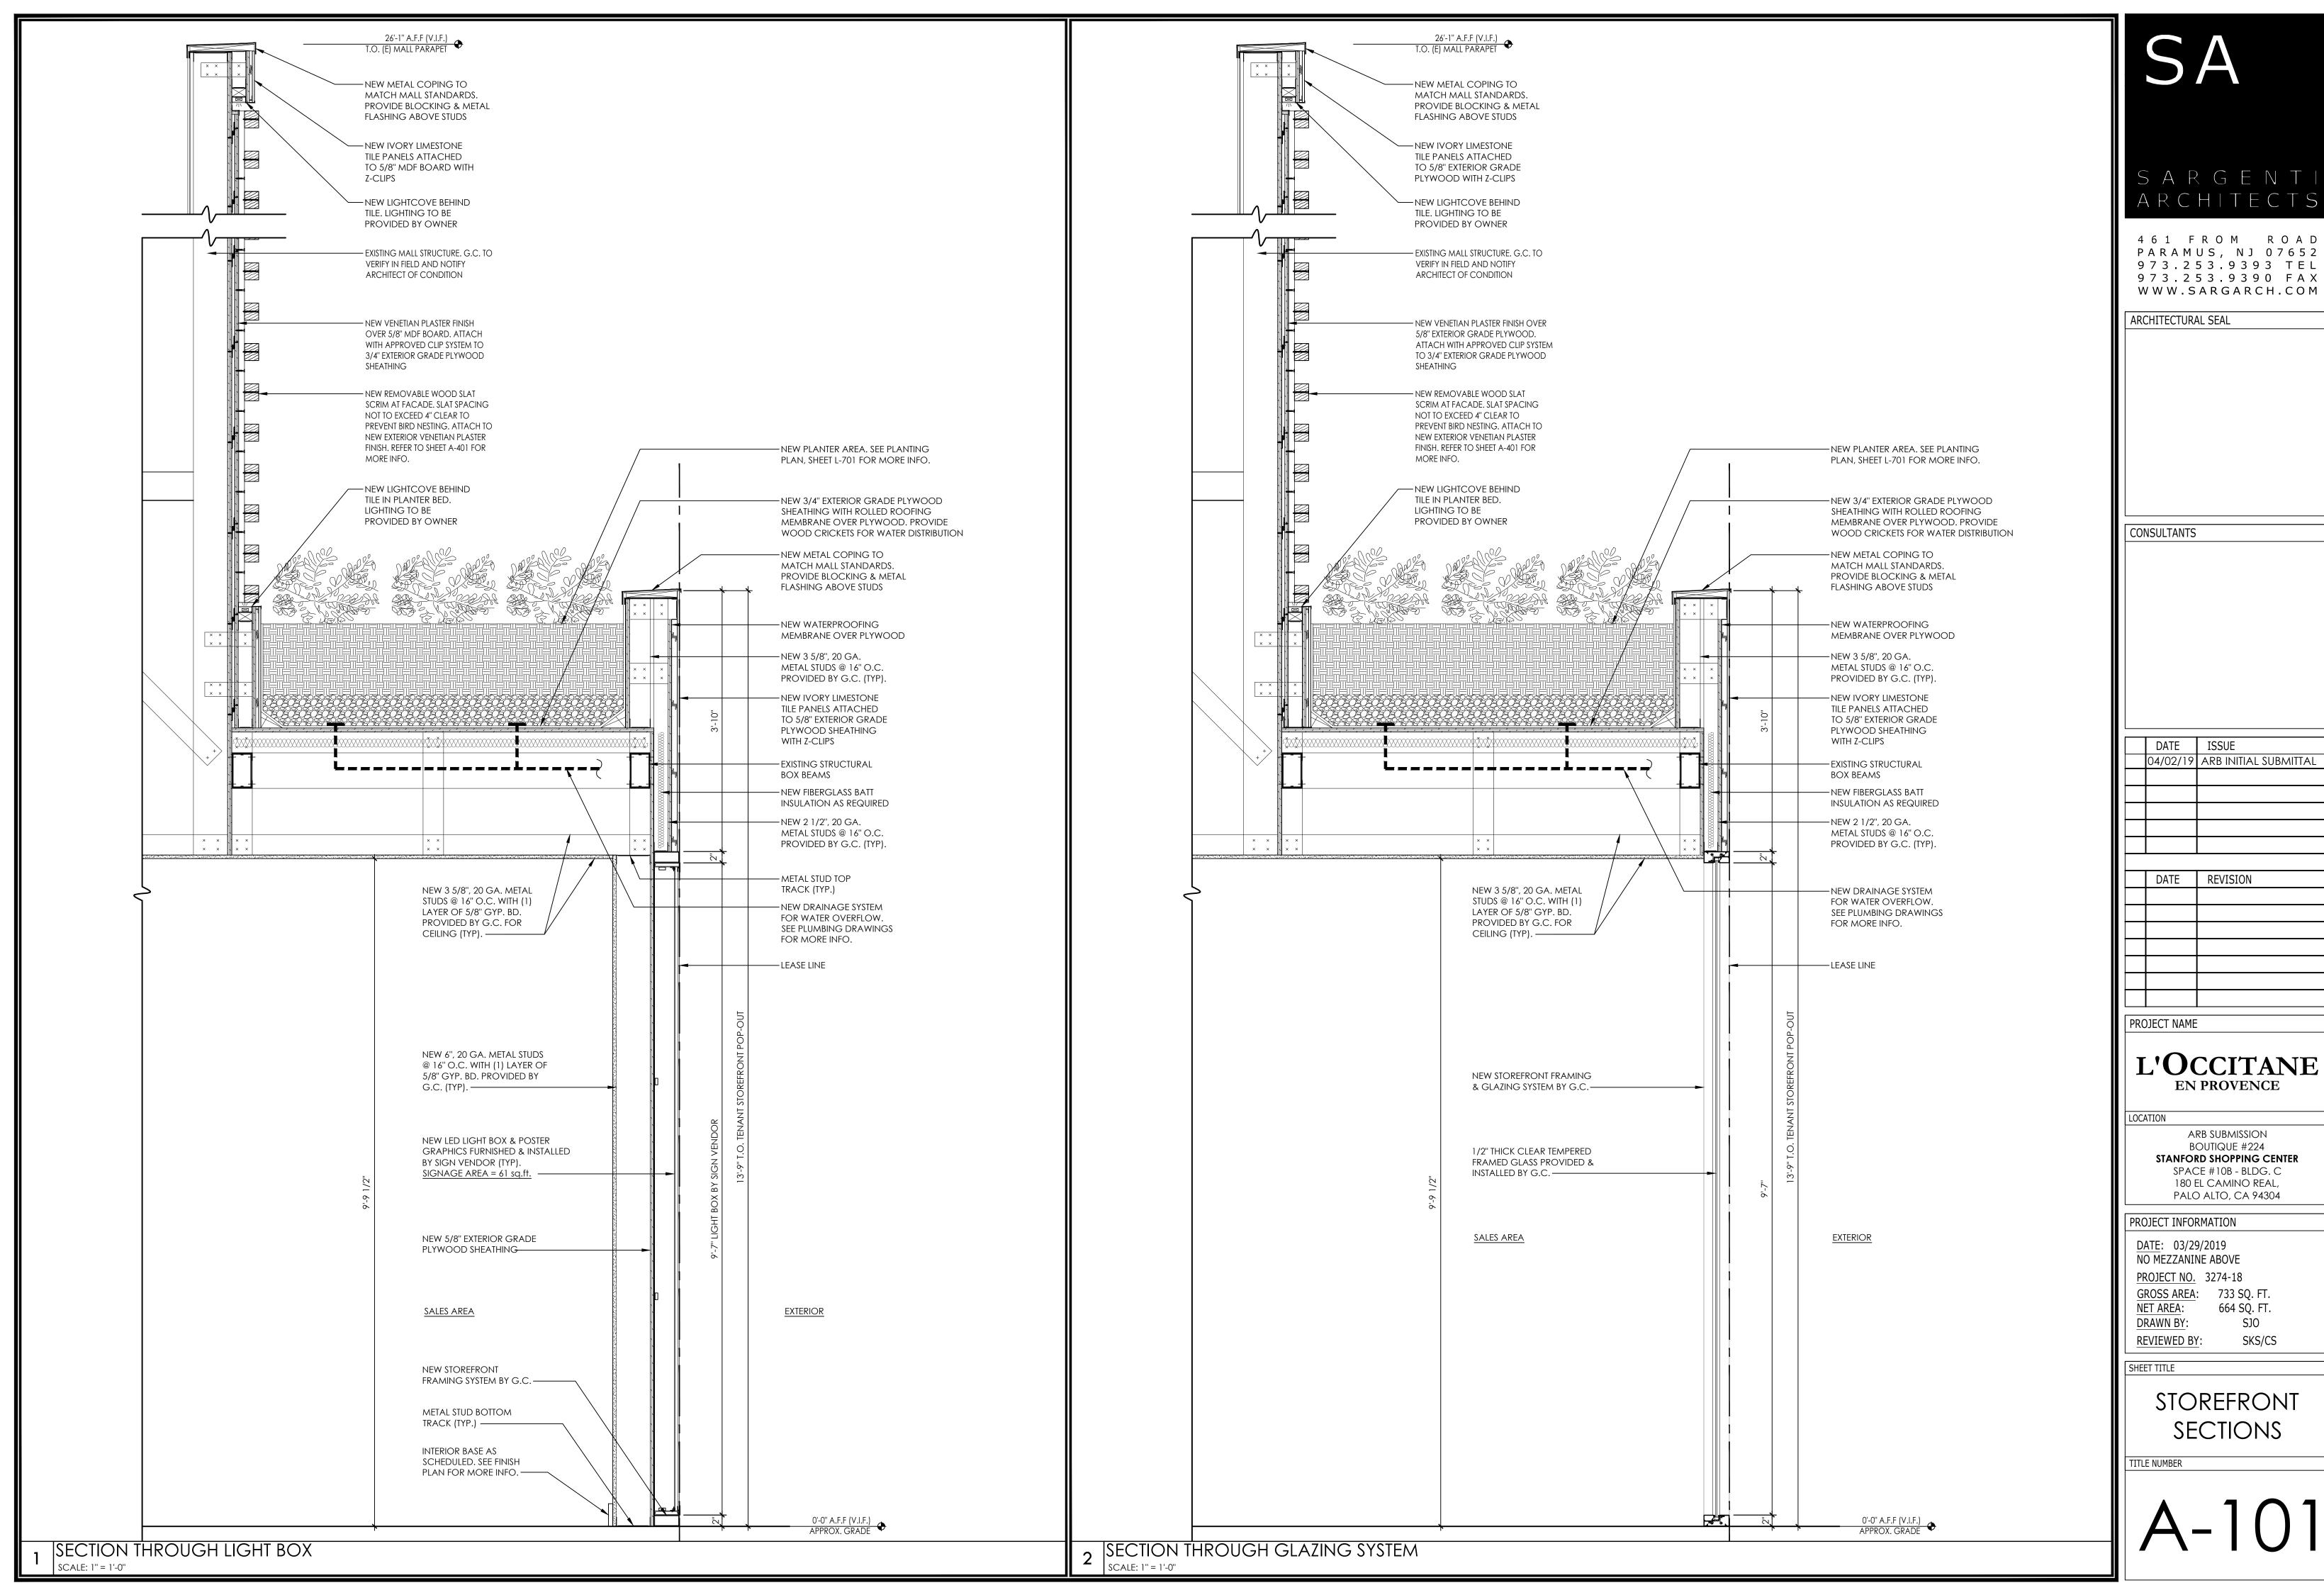



461 FROM ROAD PARAMUS, NJ 07652 973.253.9393 TEL 973.253.9390 FAX


CHITECTURAL SEAL	

DATE	REVISION

L'OCCITANE EN PROVENCE

STANFORD SHOPPING CENTER SPACE #10B - BLDG. C 180 EL CAMINO REAL,

STOREFRONT

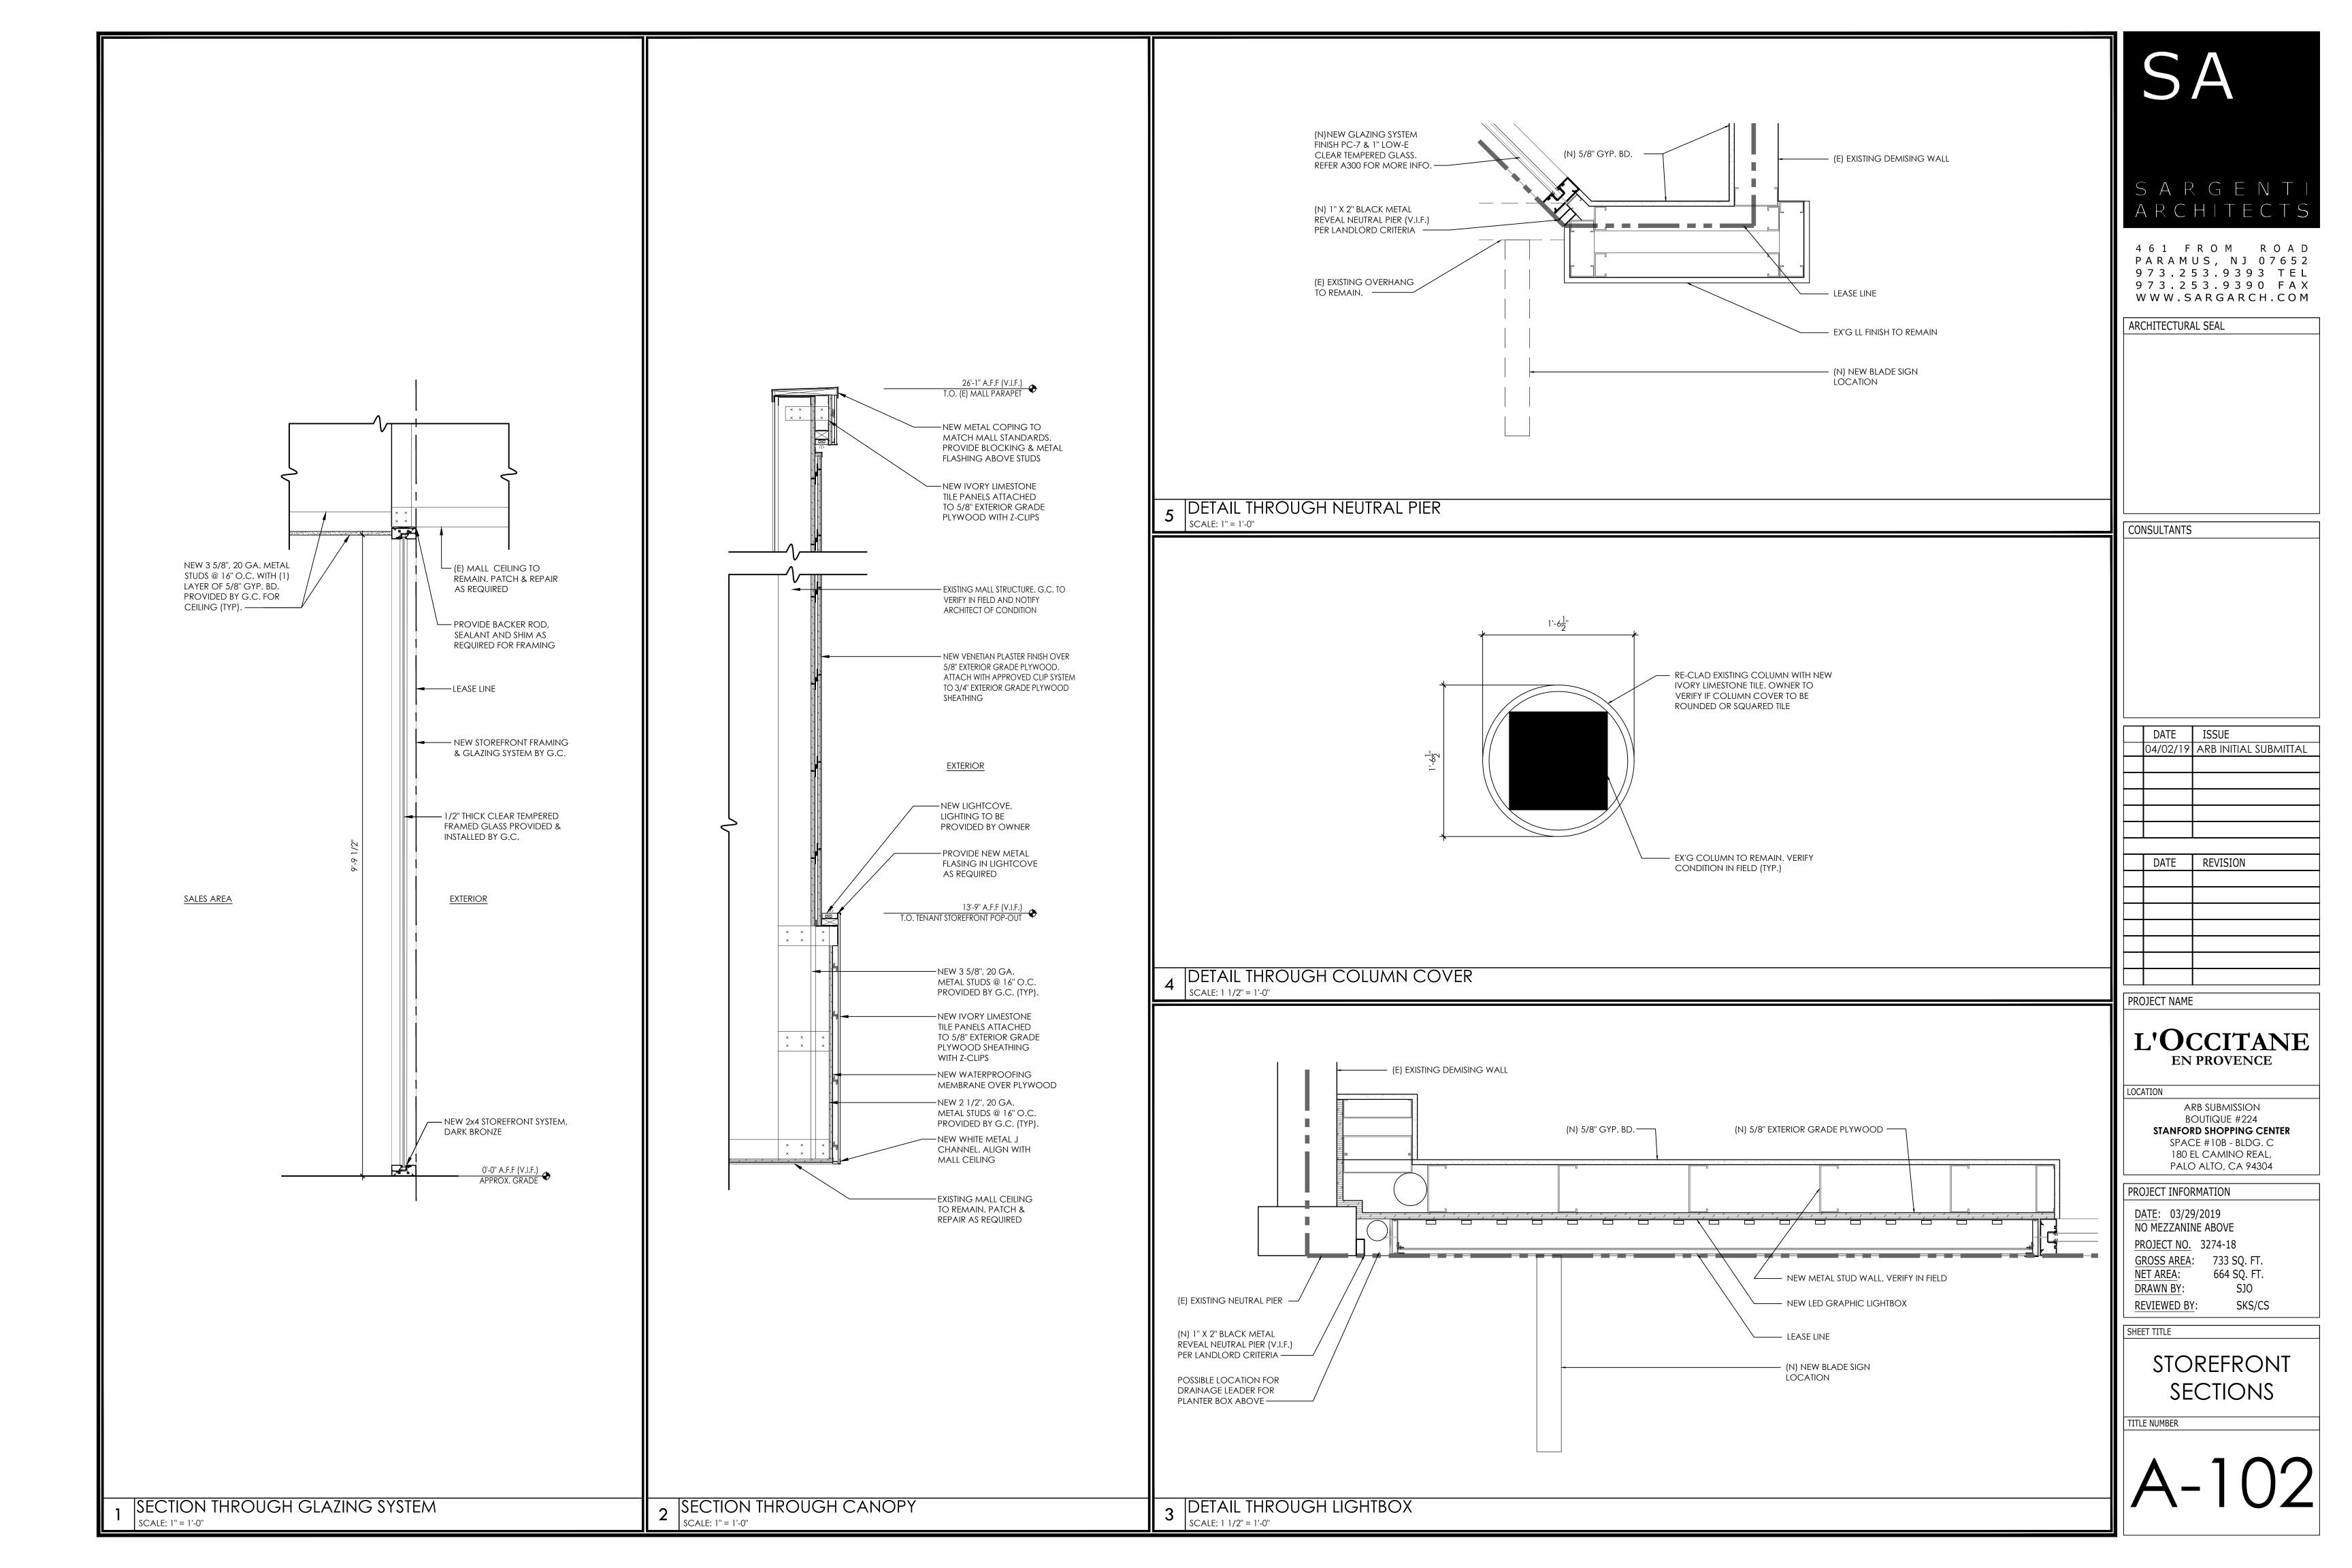





461 FROM ROAD PARAMUS, NJ 07652 973.253.9393 TEL 9 7 3 . 2 5 3 . 9 3 9 0 F A X W W W . S A R G A R C H . C O M

ARCHITECTURAL SEAL

CONSULTANTS

DATE	ISSUE
04/02/19	ARB INITIAL SUBMITTAL
DATE	REVISION

DATE	REVISION
	-

PROJECT NAME

L'OCCITANE EN PROVENCE

LOCATION

ARB SUBMISSION BOUTIQUE #224
STANFORD SHOPPING CENTER SPACE #10B - BLDG. C 180 EL CAMINO REAL, PALO ALTO, CA 94304

PROJECT INFORMATION

<u>DATE</u>: 03/29/2019 NO MEZZANINE ABOVE PROJECT NO. 3274-18

 GROSS AREA:
 733 SQ. FT.

 NET AREA:
 664 SQ. FT.


DRAWN BY: **REVIEWED BY**:

> SHEET TITLE PROPOSED STOREFRONT

SJO

SKS/CS

RENDERING

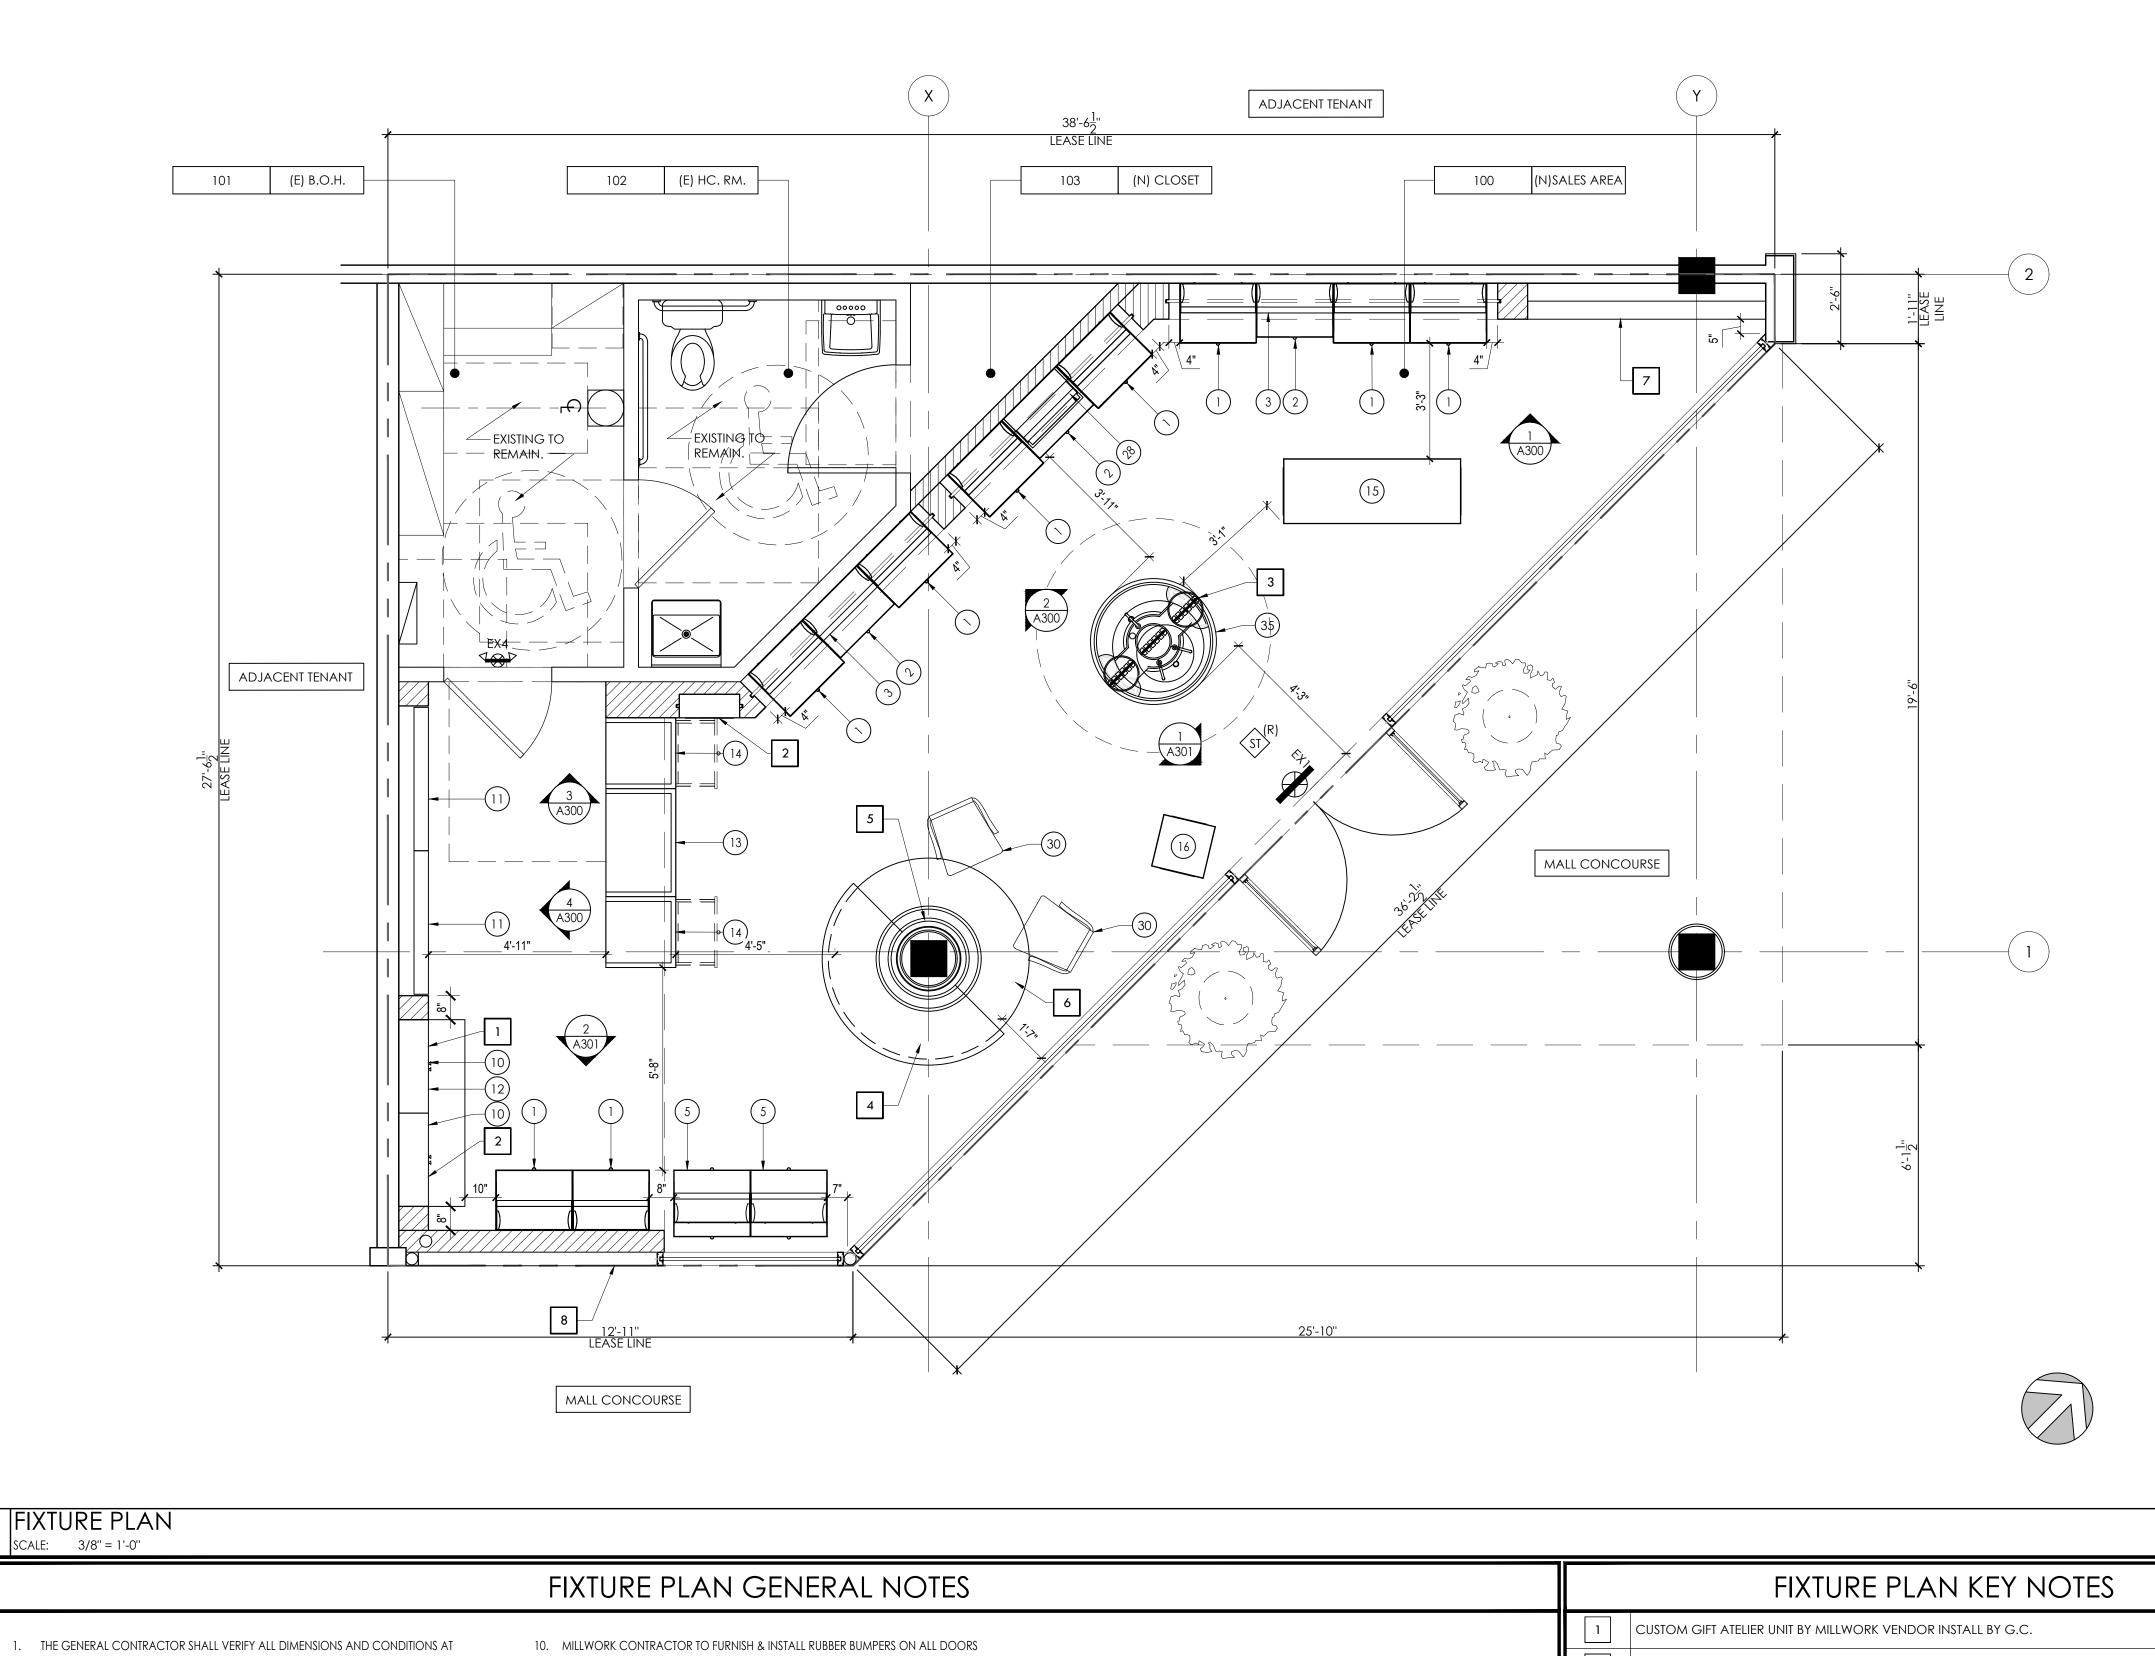

	FIXTURE PLAN GENERAL NOTES		FIXTURE PLAN KEY NOTES
THE GENERAL CONTRACTOR SHALL VERIFY ALL DIMENSIONS AND CONDITIONS AT	10. MILLWORK CONTRACTOR TO FURNISH & INSTALL RUBBER BUMPERS ON ALL DOORS		CUSTOM GIFT ATELIER UNIT BY MILLWORK VENDOR INSTALL BY G.C.
THE JOB SITE AND NOTIFY THE ARCHITECT AS TO ANY DISCREPANCIES IMMEDIATELY.	AND DRAWERS. 11. MILLWORK CONTRACTOR IS TO FURNISH FIXTURE SHOP DRAWINGS TO THE	2	CUSTOM SHELVING BY MILLWORK VENDOR INSTALL BY G.C.
 GENERAL CONTRACTOR IS TO PROVIDE ALL NECESSARY FIRE RETARDANT BLOCKING REQUIRED FOR ALL WALL MOUNTED FIXTURES. GC MUST PATCH AND REPAIR AT DEMISING WALL TO MAINTAIN FIRE RATING. 	ARCHITECT & PROJECT MANAGER FOR APPROVAL PRIOR TO FABRICATION. SEE GENERAL NOTES ON COVER SHEET AND AS03.	3	SECURE ICEBREAKER UNIT TO FLOOR. COORDINATE W/ MWK SHOP DRAWINGS. NO VISIBLE ANCHORS.
3. ALL WOODWORK ATTACHED TO THE PREMISES, BLOCKING, GROUNDS ETC., SHALL BE FIRE RETARDANT AND COMPLY WITH THE LANDLORD'S REQUIREMENTS AND	12. NO FIELD FINISHING OTHER THAN MINOR TOUCH-UPS OF MILLWORK WILL BE PERMITTED.	4	CUSTOM BUILT BENCH PROVIDED AND INSTALLED BY GC., CUSHIONS PROVIDED BY VENDOR.
GOVERNING BUILDING CODE REQUIREMENTS. 4. ALL MILLWORK IS TO CONFORM TO A.W.I. PREMIUM STANDARDS.	13. MILLWORK IS TO BE FURNISHED UNDER SEPARATE CONTRACT BY TENANT U.O.N. GENERAL CONTRACTOR IS TO COORDINATE SCHEDULING WITH MILLWORKER, ACCEPT FIXTURE DELIVERY AT SITE & CONFIRM FIXTURE COUNT AGAINST PLAN.	5	CUSTOM COLUMN WALL HAND CREAM DISPLAY. PROVIDED BY L'OCCITANE, INSTALLED BY G.C. FINAL DETAIL TBD.
ALL WOOD FIXTURES SHALL BE KILN-DRIED, MILL QUALITY FINISH AND ALL WOOD	14. GENERAL CONTRACTOR IS TO PROVIDE ALL NECESSARY FIRE RETARDANT		
SHALL RECEIVE A FIRE RETARDANT COATING OR TREATMENT AS REQUIRED BY CODE.	BLOCKING REQUIRED FOR ALL WALL MOUNTED FIXTURES. GC MUST PATCH AND REPAIR AT DEMISING WALL TO MAINTAIN FIRE RATING.		CUSTOM CONSULTING TABLE, PROVIDED BY L'OCCITANE, INSTALLED BY G.C.
6. ALL CABINET AND DRAWER INTERIORS TO BE CLEAR MAPLE LACQUERED PLYWOOD VENEER UNLESS OTHERWISE NOTED.	15. GENERAL CONTRACTOR IS TO INSTALL ALL FIXTURES U.O.N.	7	LOCATION OF FULL HEIGHT KENDU LIGHT BOX, REFER TO A200 FOR MORE INFO.
7. ALL FINISHED VENEERED WOOD SHALL BE FREE FROM KNOTS, SHAKES AND OTHER DEFECTS AFFECTING EITHER DURABILITY OR APPEARANCE, & SHALL BE CAREFULLY	16. GENERAL CONTRACTOR TO CLEAN STORE AT TURN OVER AND PRIOR TO OPENING OF SPACE.	8	LOCATION OF EXTERIOR LIGHT BOX, REFER TO A300 FOR MORE INFO.
SELECTED FOR GRAIN & COLOR FOR MARKED VARIATIONS AT JOINTS BETWEEN	17. GC SHALL PROVIDE 5 LB FIRE EXTINGUISHER TYPE "ABC" ALL-PURPOSE CHEMICAL IN		

FIXTURE SCHEDULE Symbol | fixture | sku # DESCRIPTION *55HOMURAHUS | COMPLETE UNIT- UPPER L'OC DC GC 55HOINTERUS L'OC DC L'OC DC 55HOGRETAUS LARGE (SET OF 4) INTERMEDIATE SHELVES -55HOPEETAUS L'OC DC SMALL (SET OF 5) DOUBLE-SIDED UNIT -55HODFHAUUS UPPER UNIT L'OC DC 55HODFCAIUS DOUBLE-SIDED UNIT -DOUBLE FACE 55HODFINTUS L'OC DC GC INTERMEDIATE UNIT 55HOHOMMHUS | MEN'S UNIT - UPPER L'OC DC GC 55HOHOMMBUS | MEN'S UNIT -LOWER CASHIER SHELF (1500 x 55HOETCAIUS L'OC DC GC CASHIER VISUAL FRAME ARCHITECTURAL SEAL L'OC DC GC 55HOCA128US (1280 x 780mm) BACK UNIT STORAGE L'OC DC GC 55HOARSTOUS 55" VIDEO SCREEN & L'OC MW GC BRACKET 55CSUPSOI SILK PAPER HOLDER L'OC DC GC NOVELTIES TABLE V2 L'OC DC GC 55HOTANO2US [1100x750MM] NOVELTIES TABLE - SMALL L'OC DC GC 55HONOUPEUS TESTERS TABLE V2 [1500x550MM] 55HOTATE2US L'OC DC GC SMALL PRICE TABLE L'OC DC GC 55HOTAPRIUS [450x450MM] FOLDING WRAPPING L'OC DC GC 55HOTAEMBUS TABLE [1071MM] ROUND TABLE 650 mm L'OC DC GC 55HOTARO2US CONSULTANTS L'OC DC GC 55HOTARO1US ROUND TABLE 456 mm L'OC DC 55HOTAFACUS CENTRALE CONSULTATION TABLE WA 55HOTACONUS L'OC DC GC SINK TAP STOPPER TRAP 55HOEVIERUS SET (SINK, TAP, PLUG, L'OC DC GC L'OC DC GC 55HOCONPEM 55HOTAEVIUS L'OC DC GC SINK UNIT 55HOMAR17US | MEDIUM MARKET STAND L'OC DC GC 55HOBOKARUS L'OC DC GC (28.5x52x33cm) DIVINE TRIPTYCH - 2 55HODIVOLUS L'OC DC GC DIVINE TRIPTYCH CENTRAL FRAME L'OC DC GC 55HODICADUS TERRACOTTA POT [35CM] L'OC DC GC 55POT35CM 2018_ DWR_ STOOL BIANCO OAK NAOCMM6000058 L'OC DC GC 55EASELV3 STREET EASEL L'OC DC GC COMMUNITY TABLE COMMUNITY TABLE -2017_SMALL_ICE_BREAKER_ VISION TV WINDOW NAOC MM6000063 DISPLAY (2018) 37) NAOC MM6000062 VISION ILLUMINATED MWC PODIUM (2018) KIT 5 METAL DOMAIN HEADEF 55HODOMHEI TBD L'OC DC GC DOUBLE-SIDED DOMAIN 55HODFDOMUS L'OC DC GC NAOCMM6000053 TRAVEL UNIT L'OC DC GC L'OC DC GC NAOCMM6000059 RECYCLE BIN SHEA BUTTER FRAME (900 X 500 mm) 55HOCAKARUS 55HOCAKAGI LARGE SHEA BUTTER FRAME L'OC DC GC 2014_PH_IDX_EPOS NAOCMM6000005 2014_PH_IDX_POS CENTER L'OC DC GC NAOCMM6000004 SAMPLES PRODUCT DRAWER 55 HOTAECH 55 HOTAPMR DISABLED DRAWER MARKET UNIT 1 55 HOMARCIUS 55 HOMARC24S MARKET UNIT 2 SMALL BOX TALL BOX 55 HOBOIGD 55 HOPODPE SMALL PODIUM TALL PODIUM 55 HOPODGD DIVINE ART FRAME 55 HOARTDI SHEA BUTTER FRAME 55 HOARTKA 55 HOARTHO MENS ARTY FRAME 55 HOARTLA LAVENDER FRAME 2'-6X3'-4' COCOA MAT W/L'OCCI 926298 VINTAGE UNIT ARMOIRE L'OC DC GC

SARGENT ARCHITECTS

> 461 FROM ROAD PARAMUS, NJ 07652 973.253.9393 TEL 973.253.9390 FAX WWW.SARGARCH.COM

04/02/19 ARB INITIAL SUBMITTAL DATE REVISION

PROJECT NAME L'OCCITANE **EN PROVENCE**

LOCATION ARB SUBMISSION **BOUTIQUE #224** STANFORD SHOPPING CENTER SPACE #10B - BLDG. C 180 EL CAMINO REAL, PALO ALTO, CA 94304


PROJECT INFORMATION


DATE: 03/29/2019 NO MEZZANINE ABOVE PROJECT NO. 3274-18 GROSS AREA: 733 SQ. FT. 664 SQ. FT. NET AREA: DRAWN BY: SJ0 **REVIEWED BY:** SKS/CS


SHEET TITLE FIXTURE PLAN, SCHEDULE &


DETAILS


- MILLWORK CONTRACTOR TO COORDINATE WITH OTHER TRADES AND PROVIDE CONCEALED GROUNDS AS REQUIRED. PROVIDE CUTOUTS IN FIELD FOR OUTLETS AND EQUIPMENT AS REQUIRED. VERIFY ALL DIMENSIONS PRIOR TO FABRICATION.
- ALL MILLWORK HARDWARE TO BE FURNISHED & INSTALLED BY MILLWORK CONTRACTOR U.O.N.
- ACCORDANCE TO LATEST ADDITION OF NFPA 10 FOR SPRINKLER BUILDING. INSPECTED AND TAGGED ANNUALLY BY A LICENSING AGENCY.
- 18. ALL FIXTURES MUST BE FASTENED TOGETHER BY GC. BASE SECTIONS GC TO REMOVE TOP DRAWER, SCREW FIXTURES TOGETHER THROUGH THE SIDE, AND LEVEL BOTTOM OF FIXTURES WITH LEVELERS. UPPER SECTIONS - GC TO SCREW TOGETHER AT INCONSPICUOUS LOCATIONS. ALL FASTENINGS MUST BE HIDDEN FROM SALES AREA

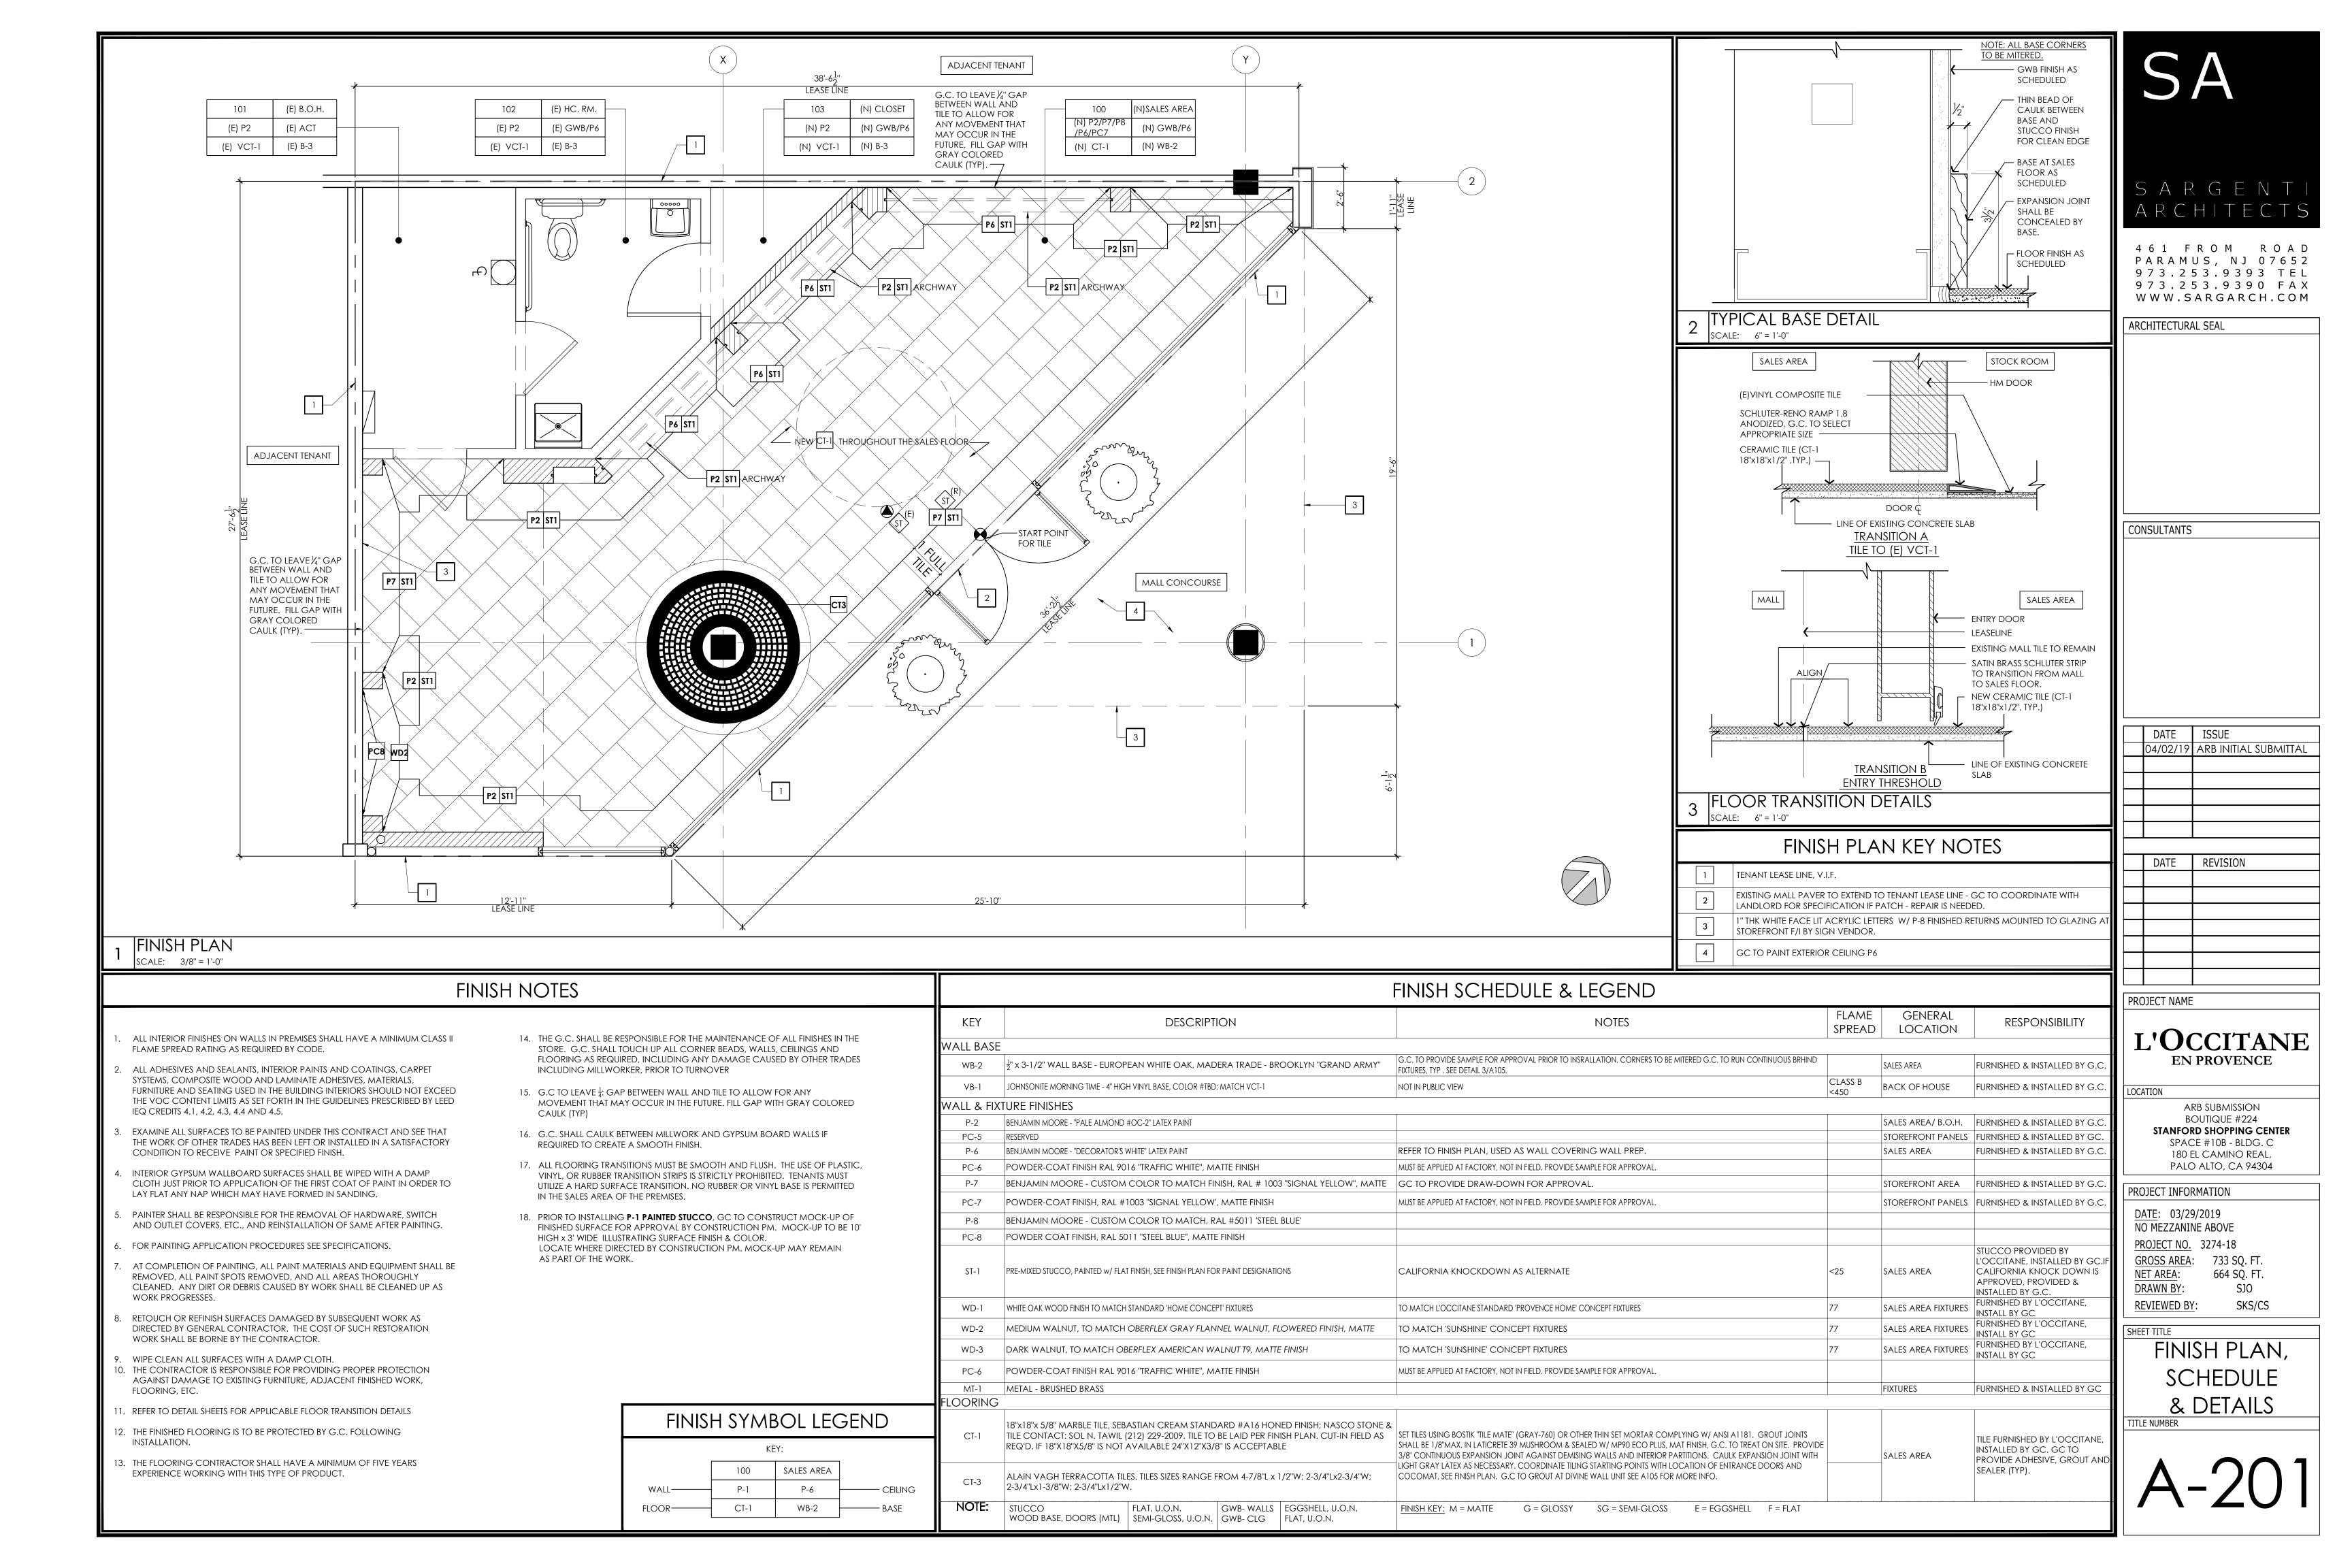

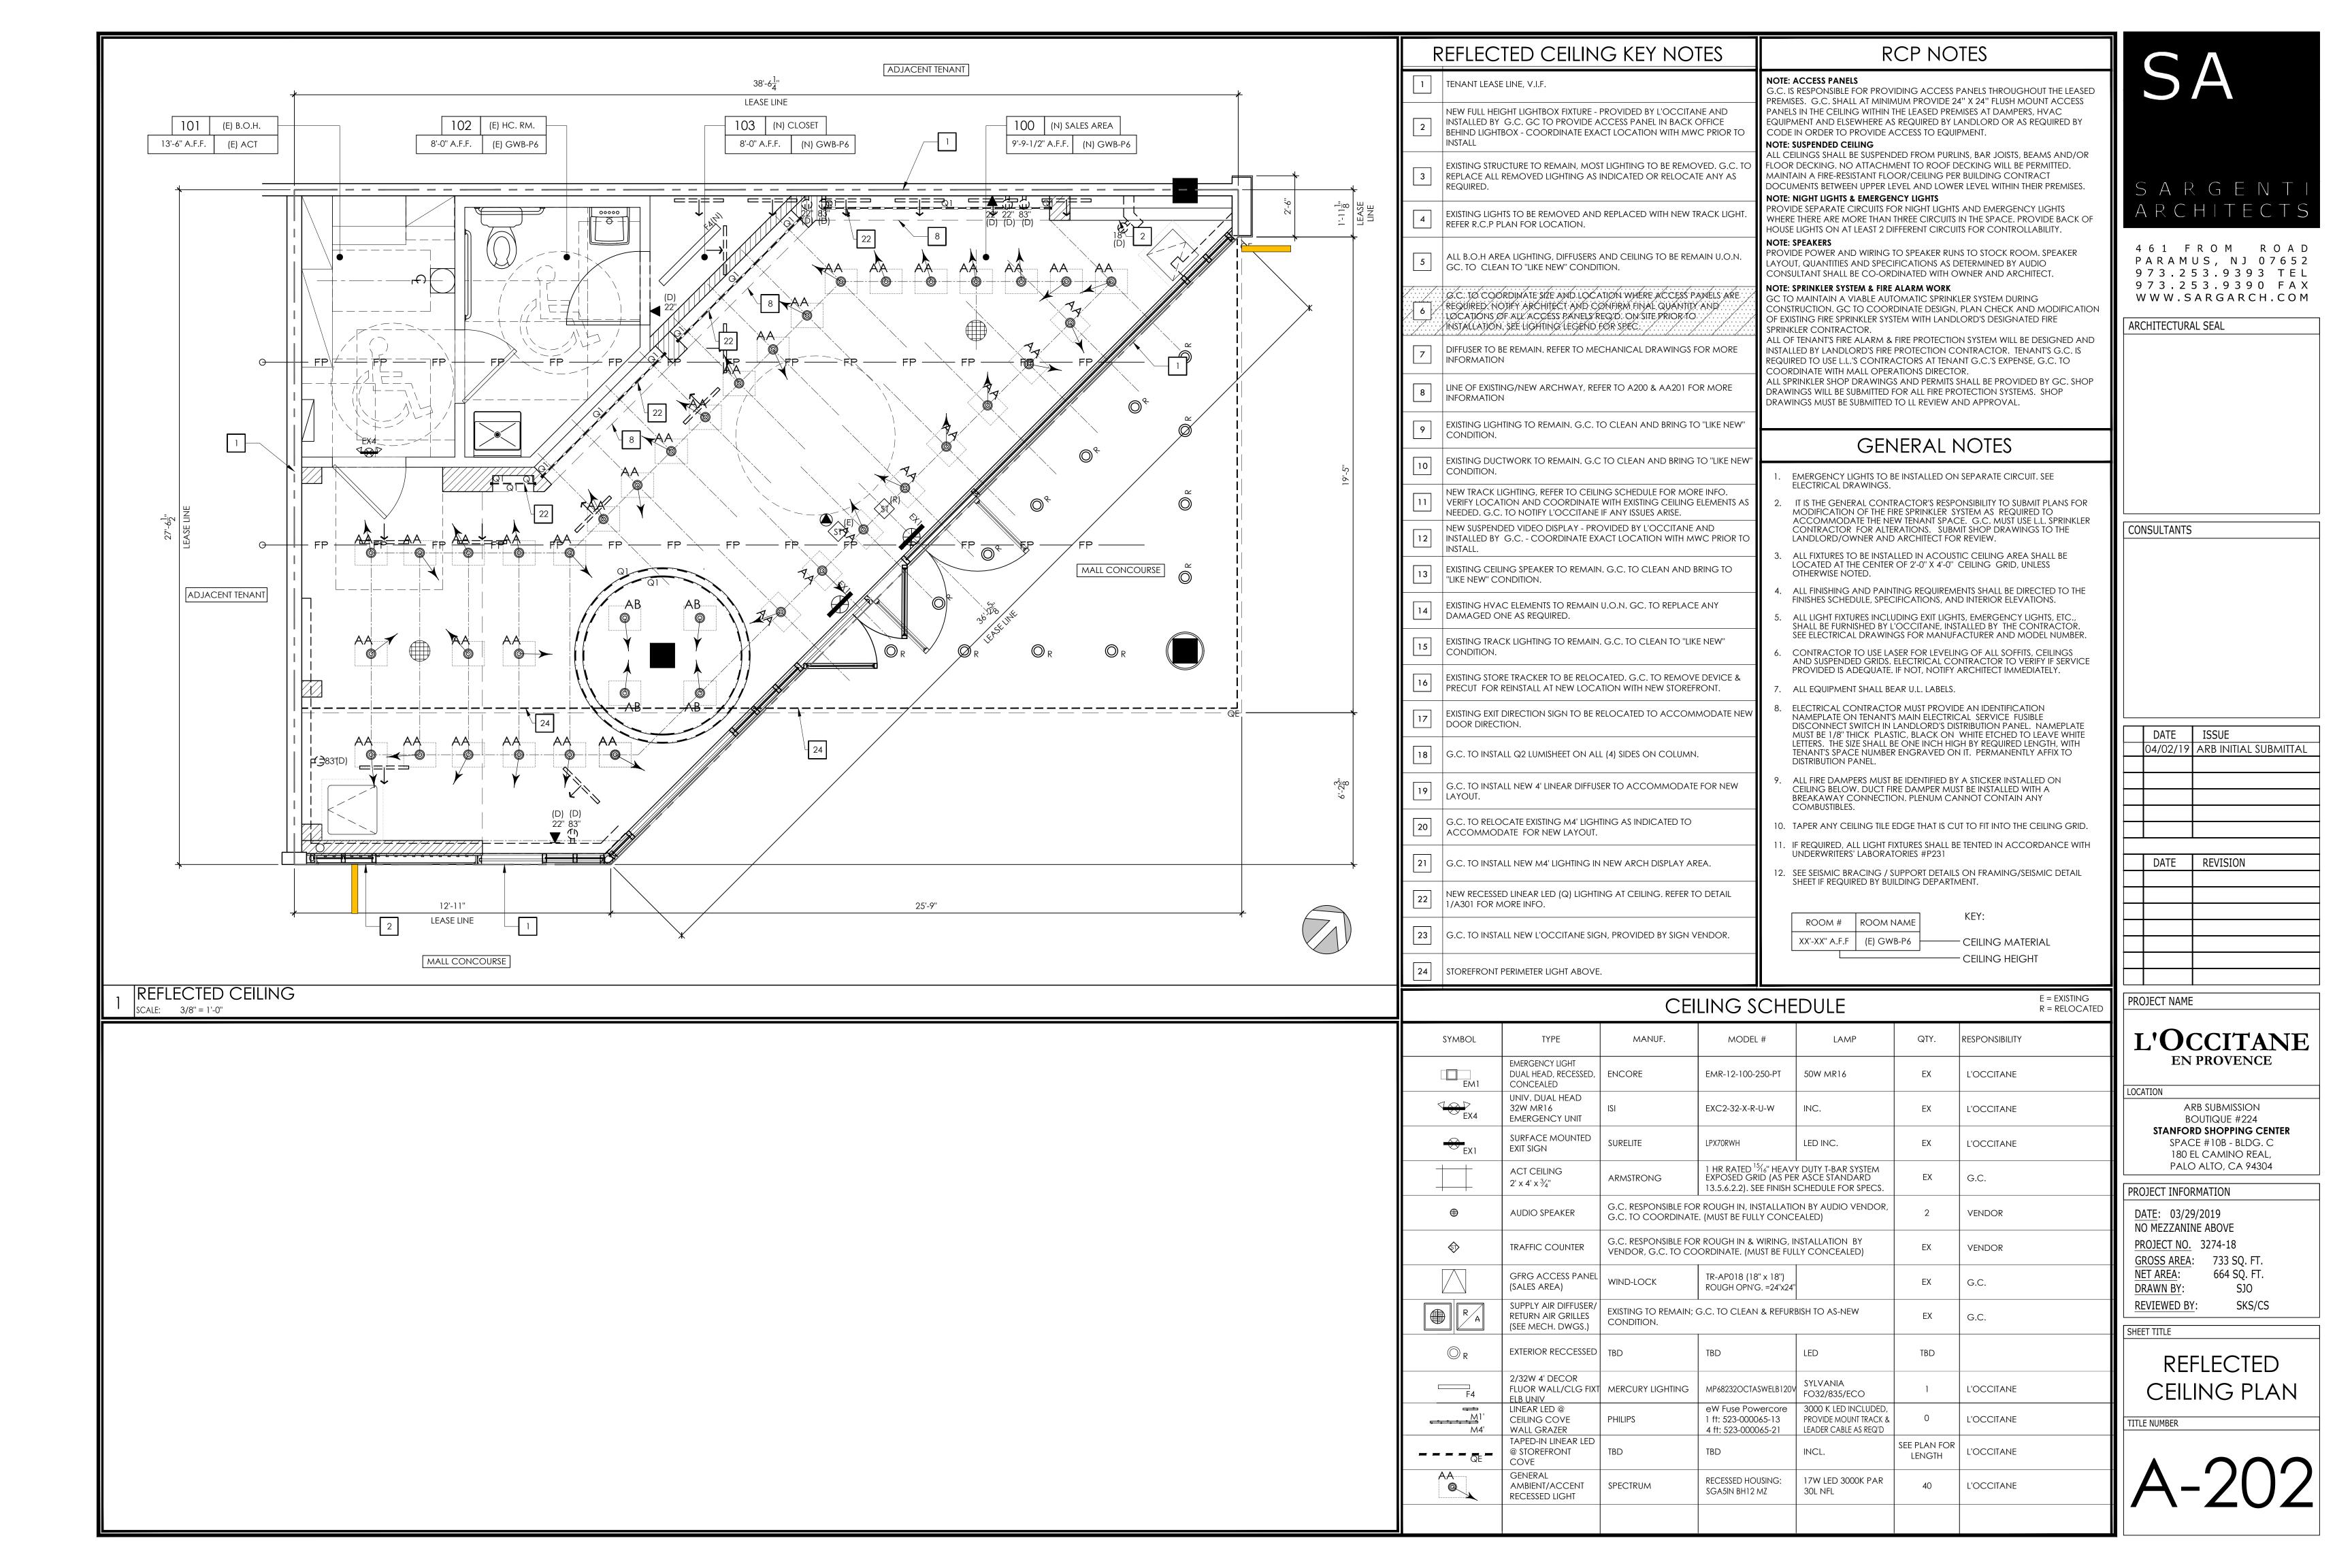


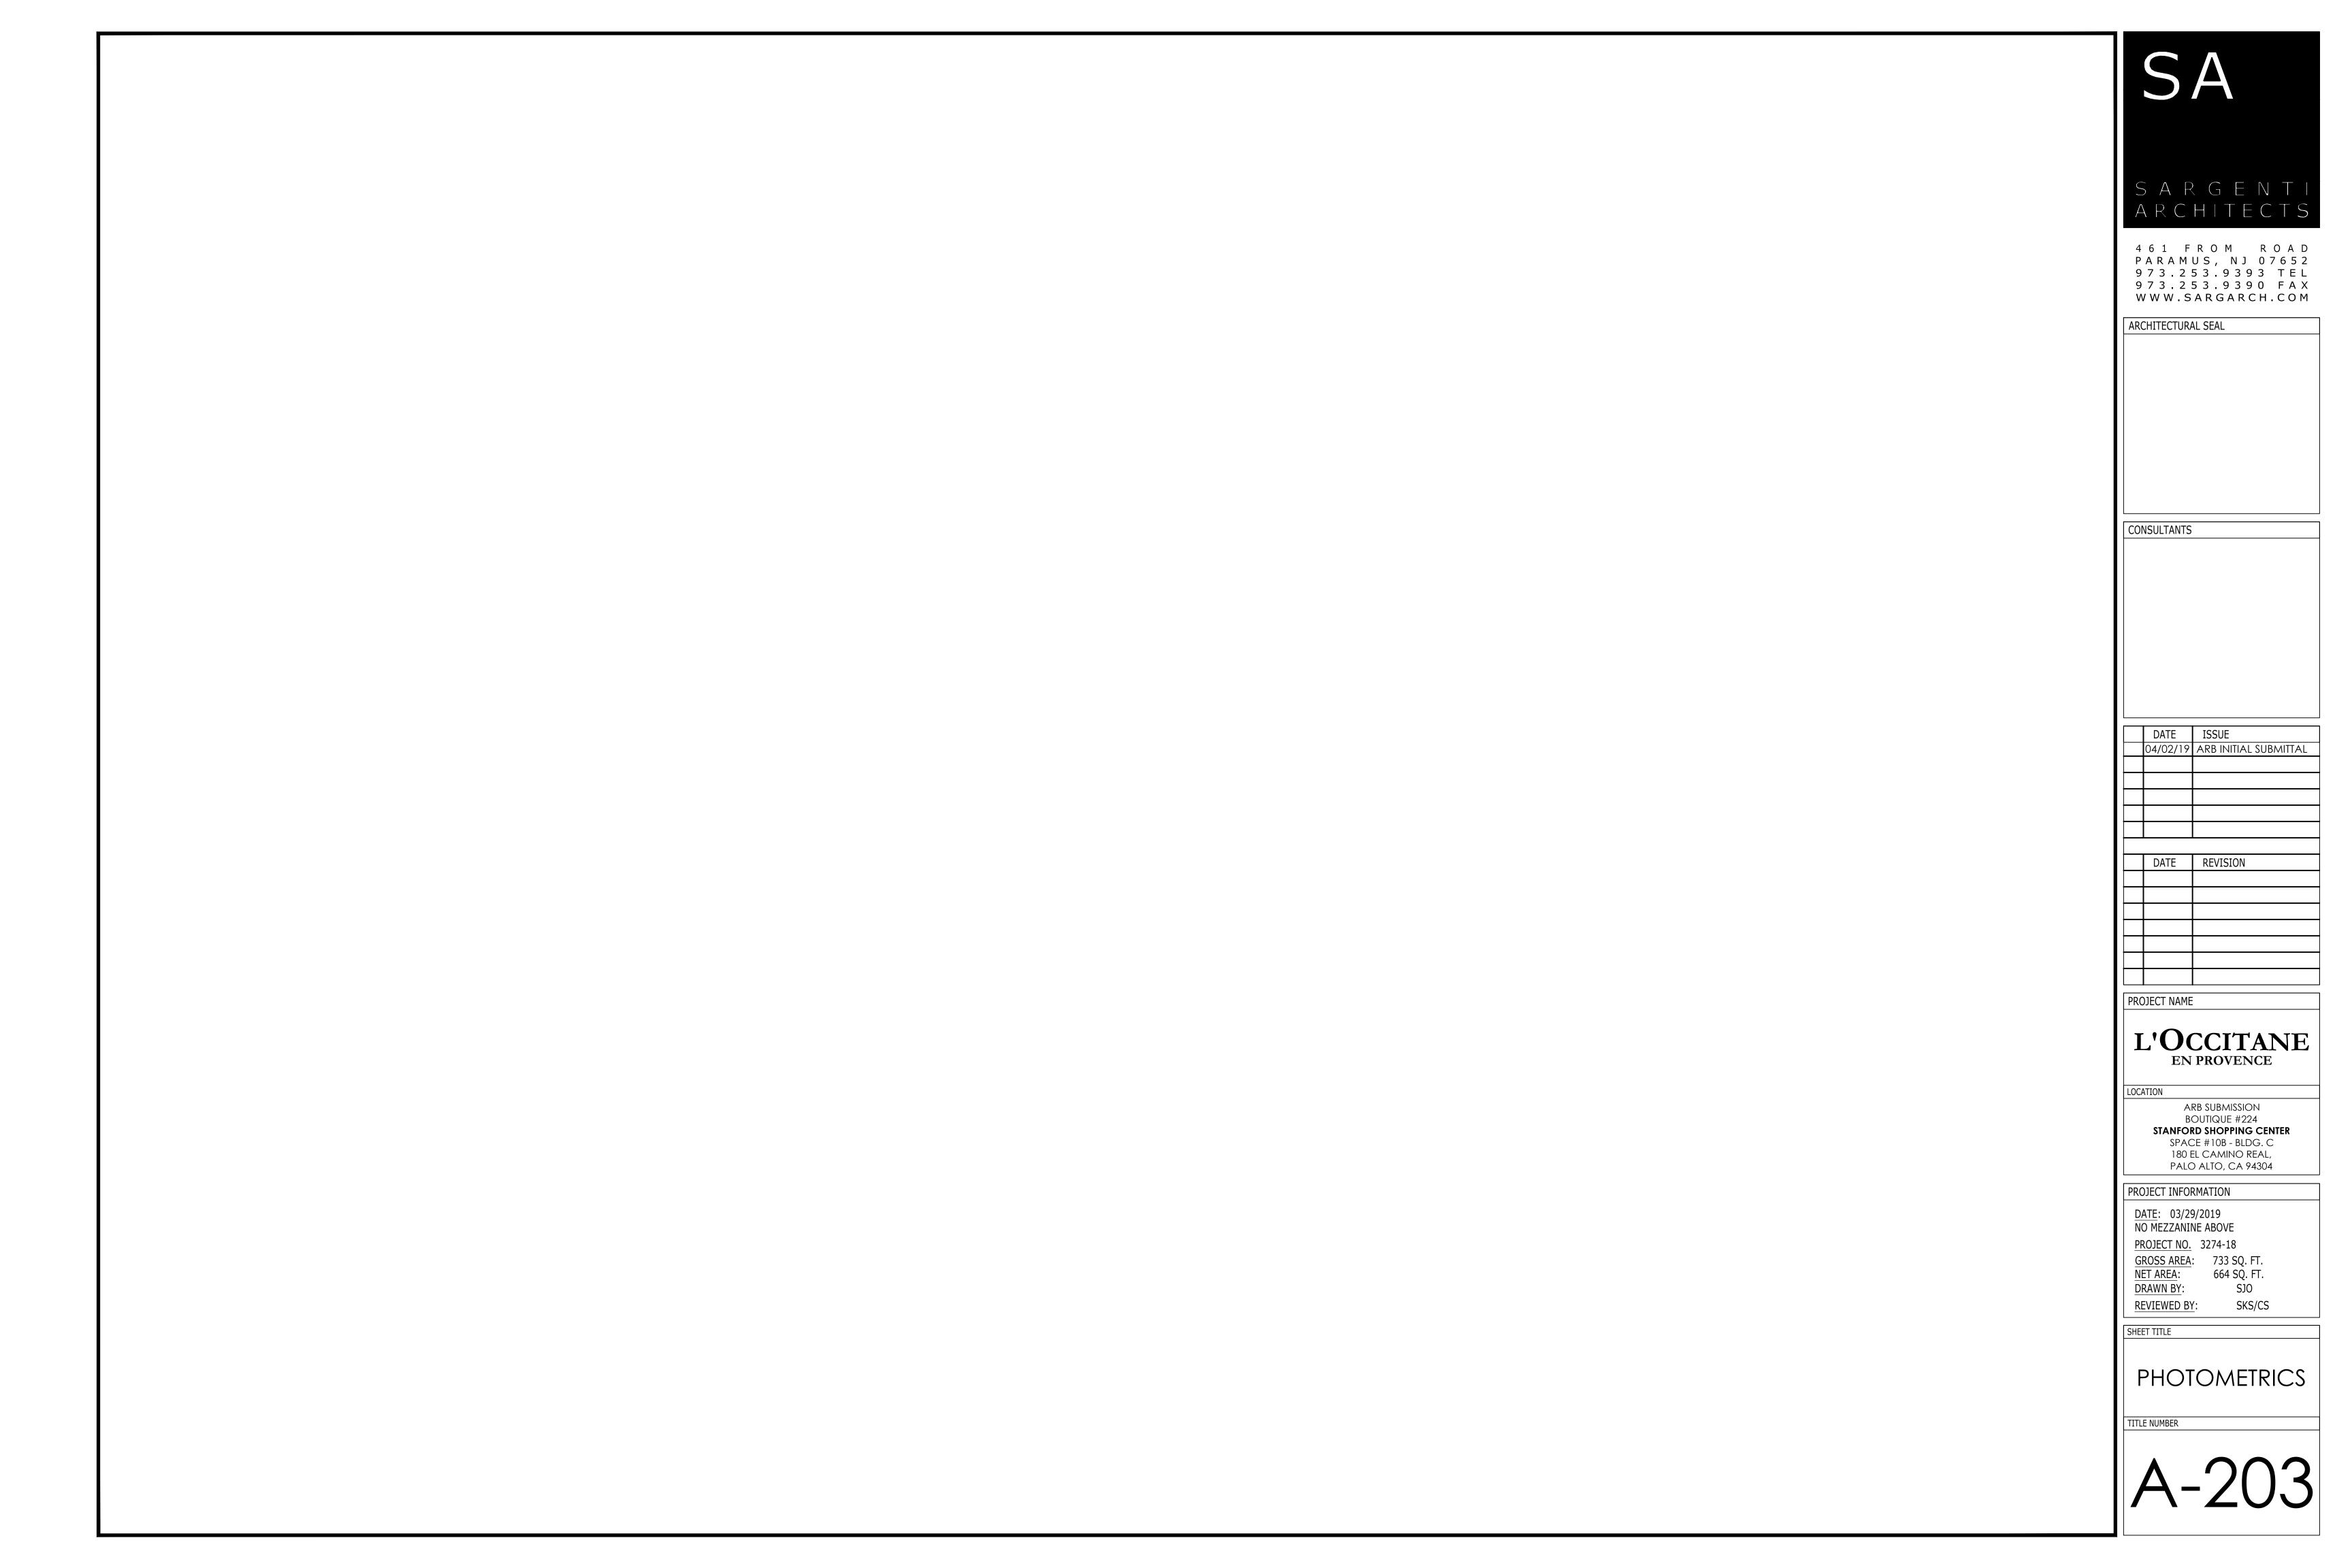

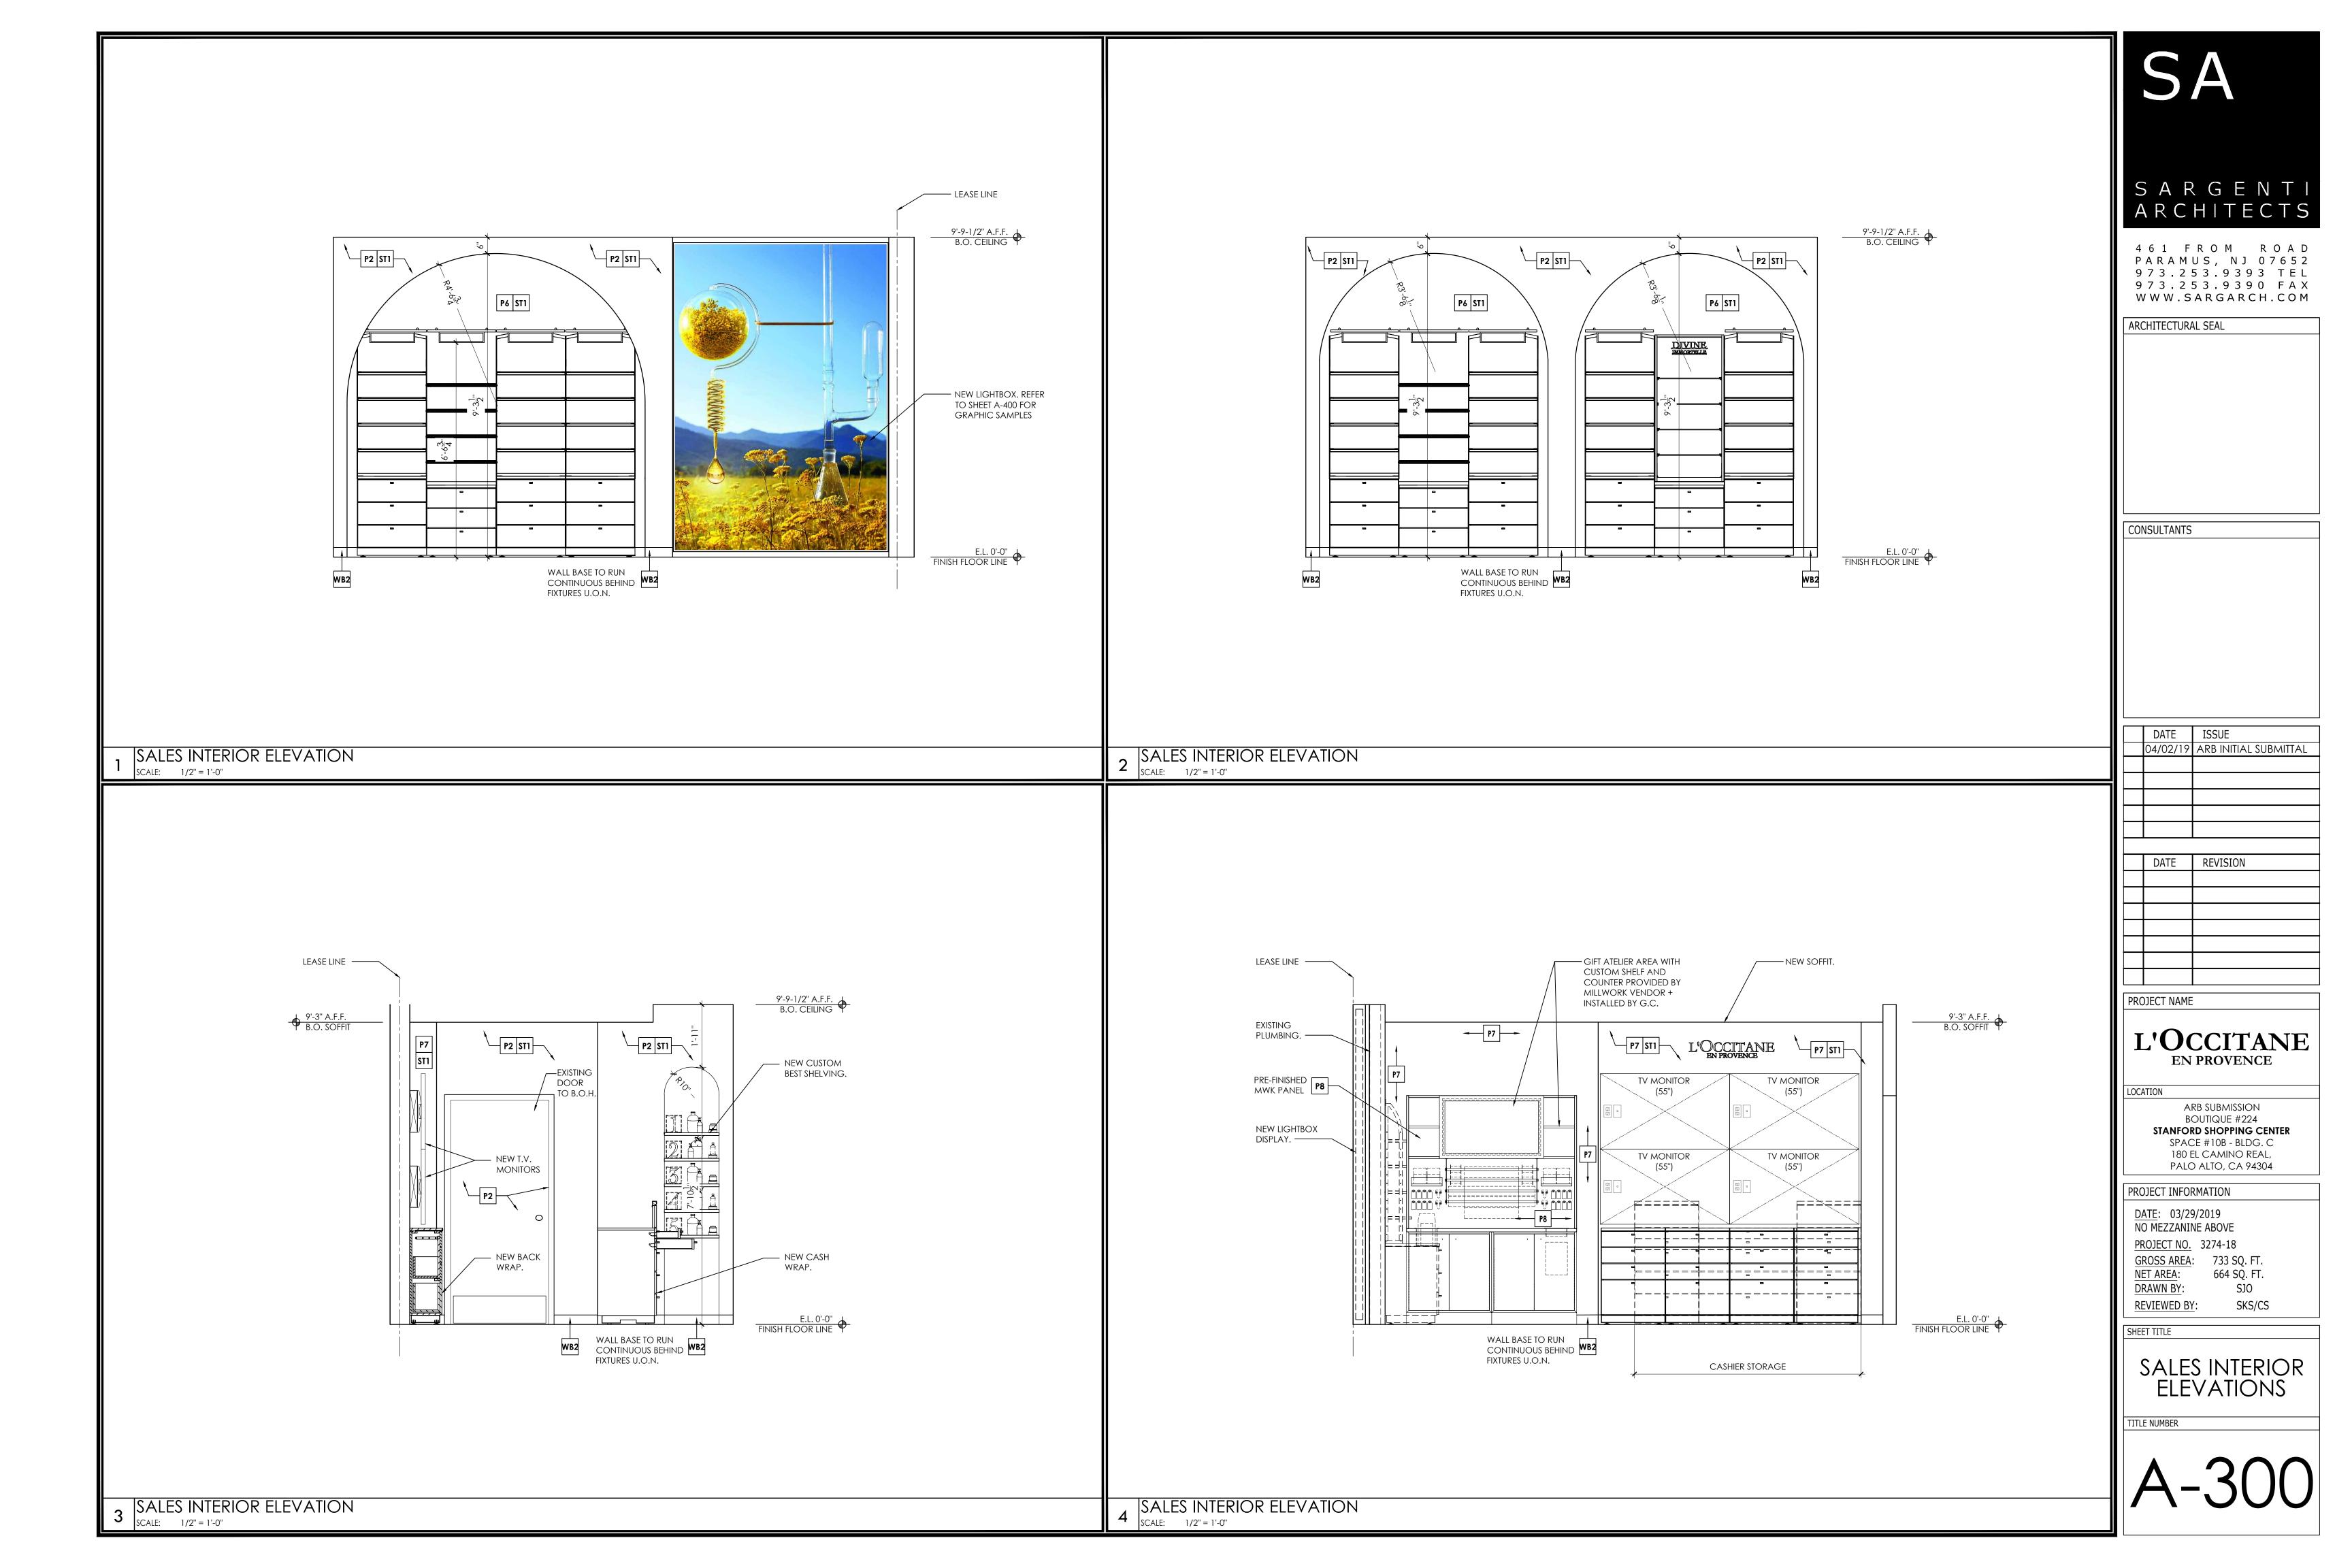

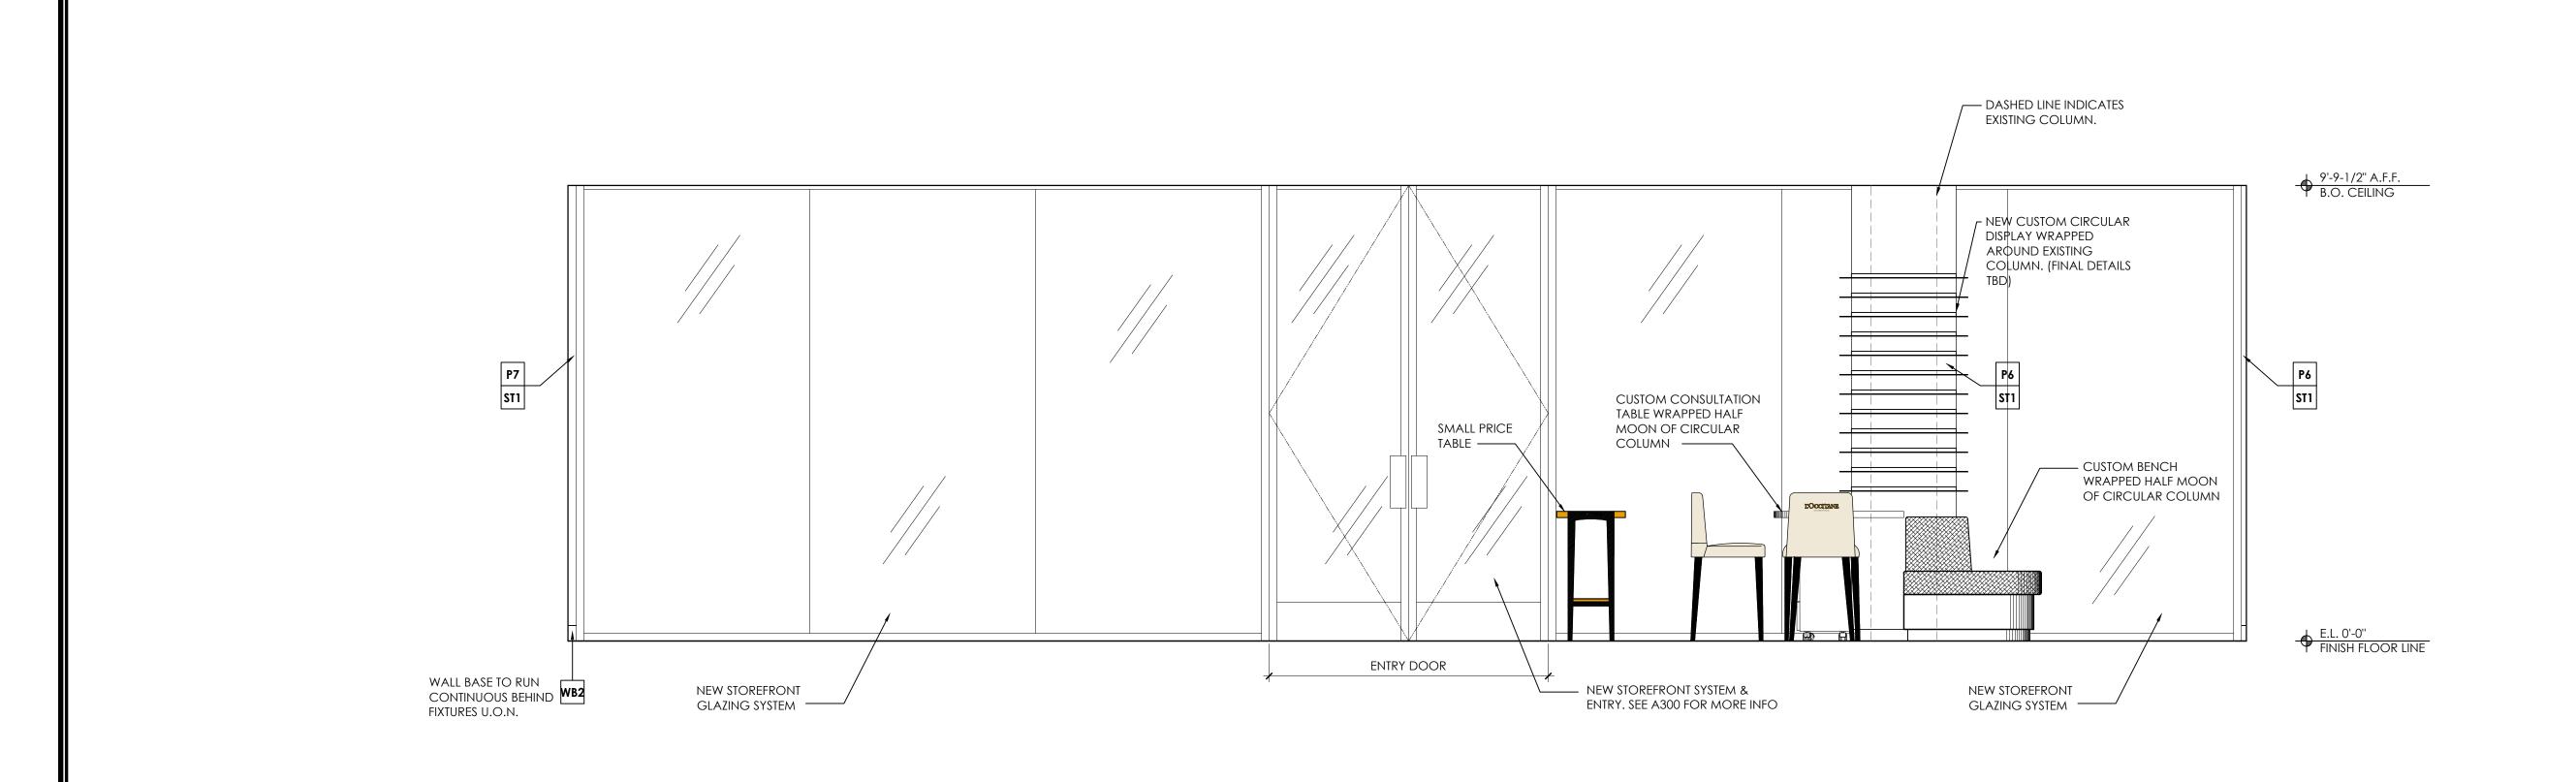

SALES INTERIOR ELEVATION SCALE: 1/2" = 1'-0"

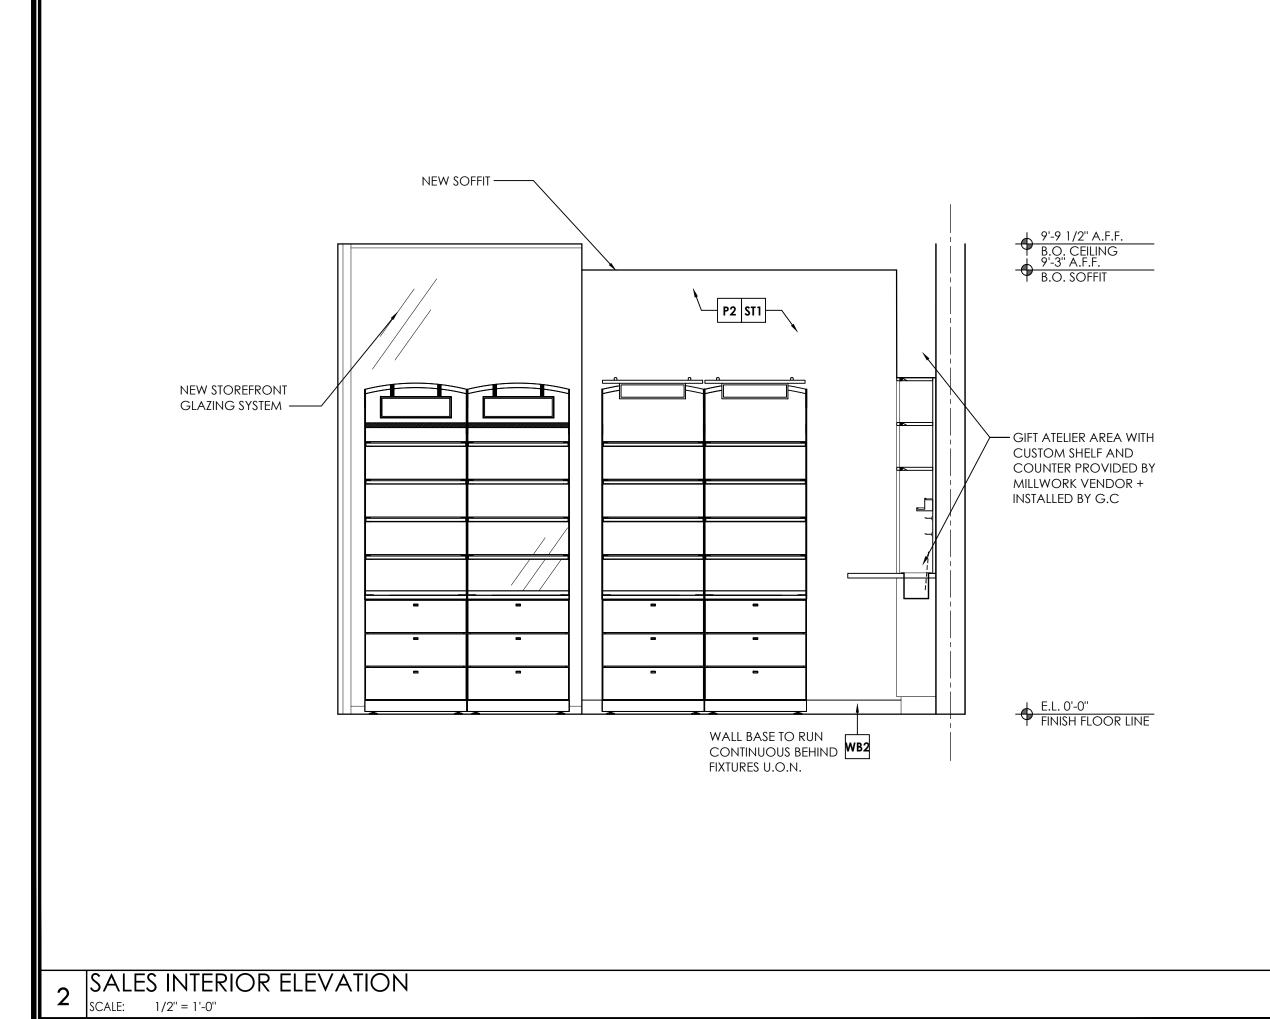

INTERIOR ELEVATION NOTES

NOTE: STUCCO FINISH

EX'G STUCCO W/SWIRL PATTERN TO BE REMOVED & NEW STUCCO TO BE APPLIED IN A CALIFORNIA KNOCKDOWN FINISH.

NOTE: BLOCKING FOR WALL FIXTURES

GC TO PROVIDE ALL NECESSARY FIRE RETARDANT BLOCKING REQUIRED FOR ALL WALL MOUNTED FIXTURES. GC MUST PATCH AND REPAIR AT DEMISING WALL TO MAINTAIN FIRE RATING. SEE FIXTURE DRAWINGS FOR MORE INFORMATION, EXACT DIMENSIONS AND FURTHER FIXTURE DETAILS.

NOTE: FASTENING FIXTURES

ALL FIXTURES MUST BE FASTENED TOGETHER BY GC. BASE SECTIONS - GC TO REMOVE TOP DRAWER, SCREW FIXTURES TOGETHER THROUGH THE SIDE, AND LEVEL BOTTOM OF FIXTURES WITH LEVELERS. UPPER SECTIONS - GC TO SCREW TOGETHER BEHIND GRAPHIC PANEL AT INCONSPICUOUS LOCATIONS. ALL FASTENINGS MUST BE HIDDEN FROM SALES AREA.

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|--|

	CONSULTANTS
	CONSOLITATIO

DATE	ISSUE
04/02/19	ARB INITIAL SUBMITTAL

DATE	REVISION

PROJECT NAME

L'OCCITANE EN PROVENCE

LOCATION

ARB SUBMISSION **BOUTIQUE #224** STANFORD SHOPPING CENTER SPACE #10B - BLDG. C 180 EL CAMINO REAL, PALO ALTO, CA 94304

PROJECT INFORMATION

DATE: 03/29/2019 NO MEZZANINE ABOVE PROJECT NO. 3274-18 GROSS AREA: 733 SQ. FT. 664 SQ. FT. NET AREA:

DRAWN BY:


SKS/CS REVIEWED BY:

SJ0

SHEET TITLE

SALES INTERIOR ELEVATIONS

TITLE NUMBER

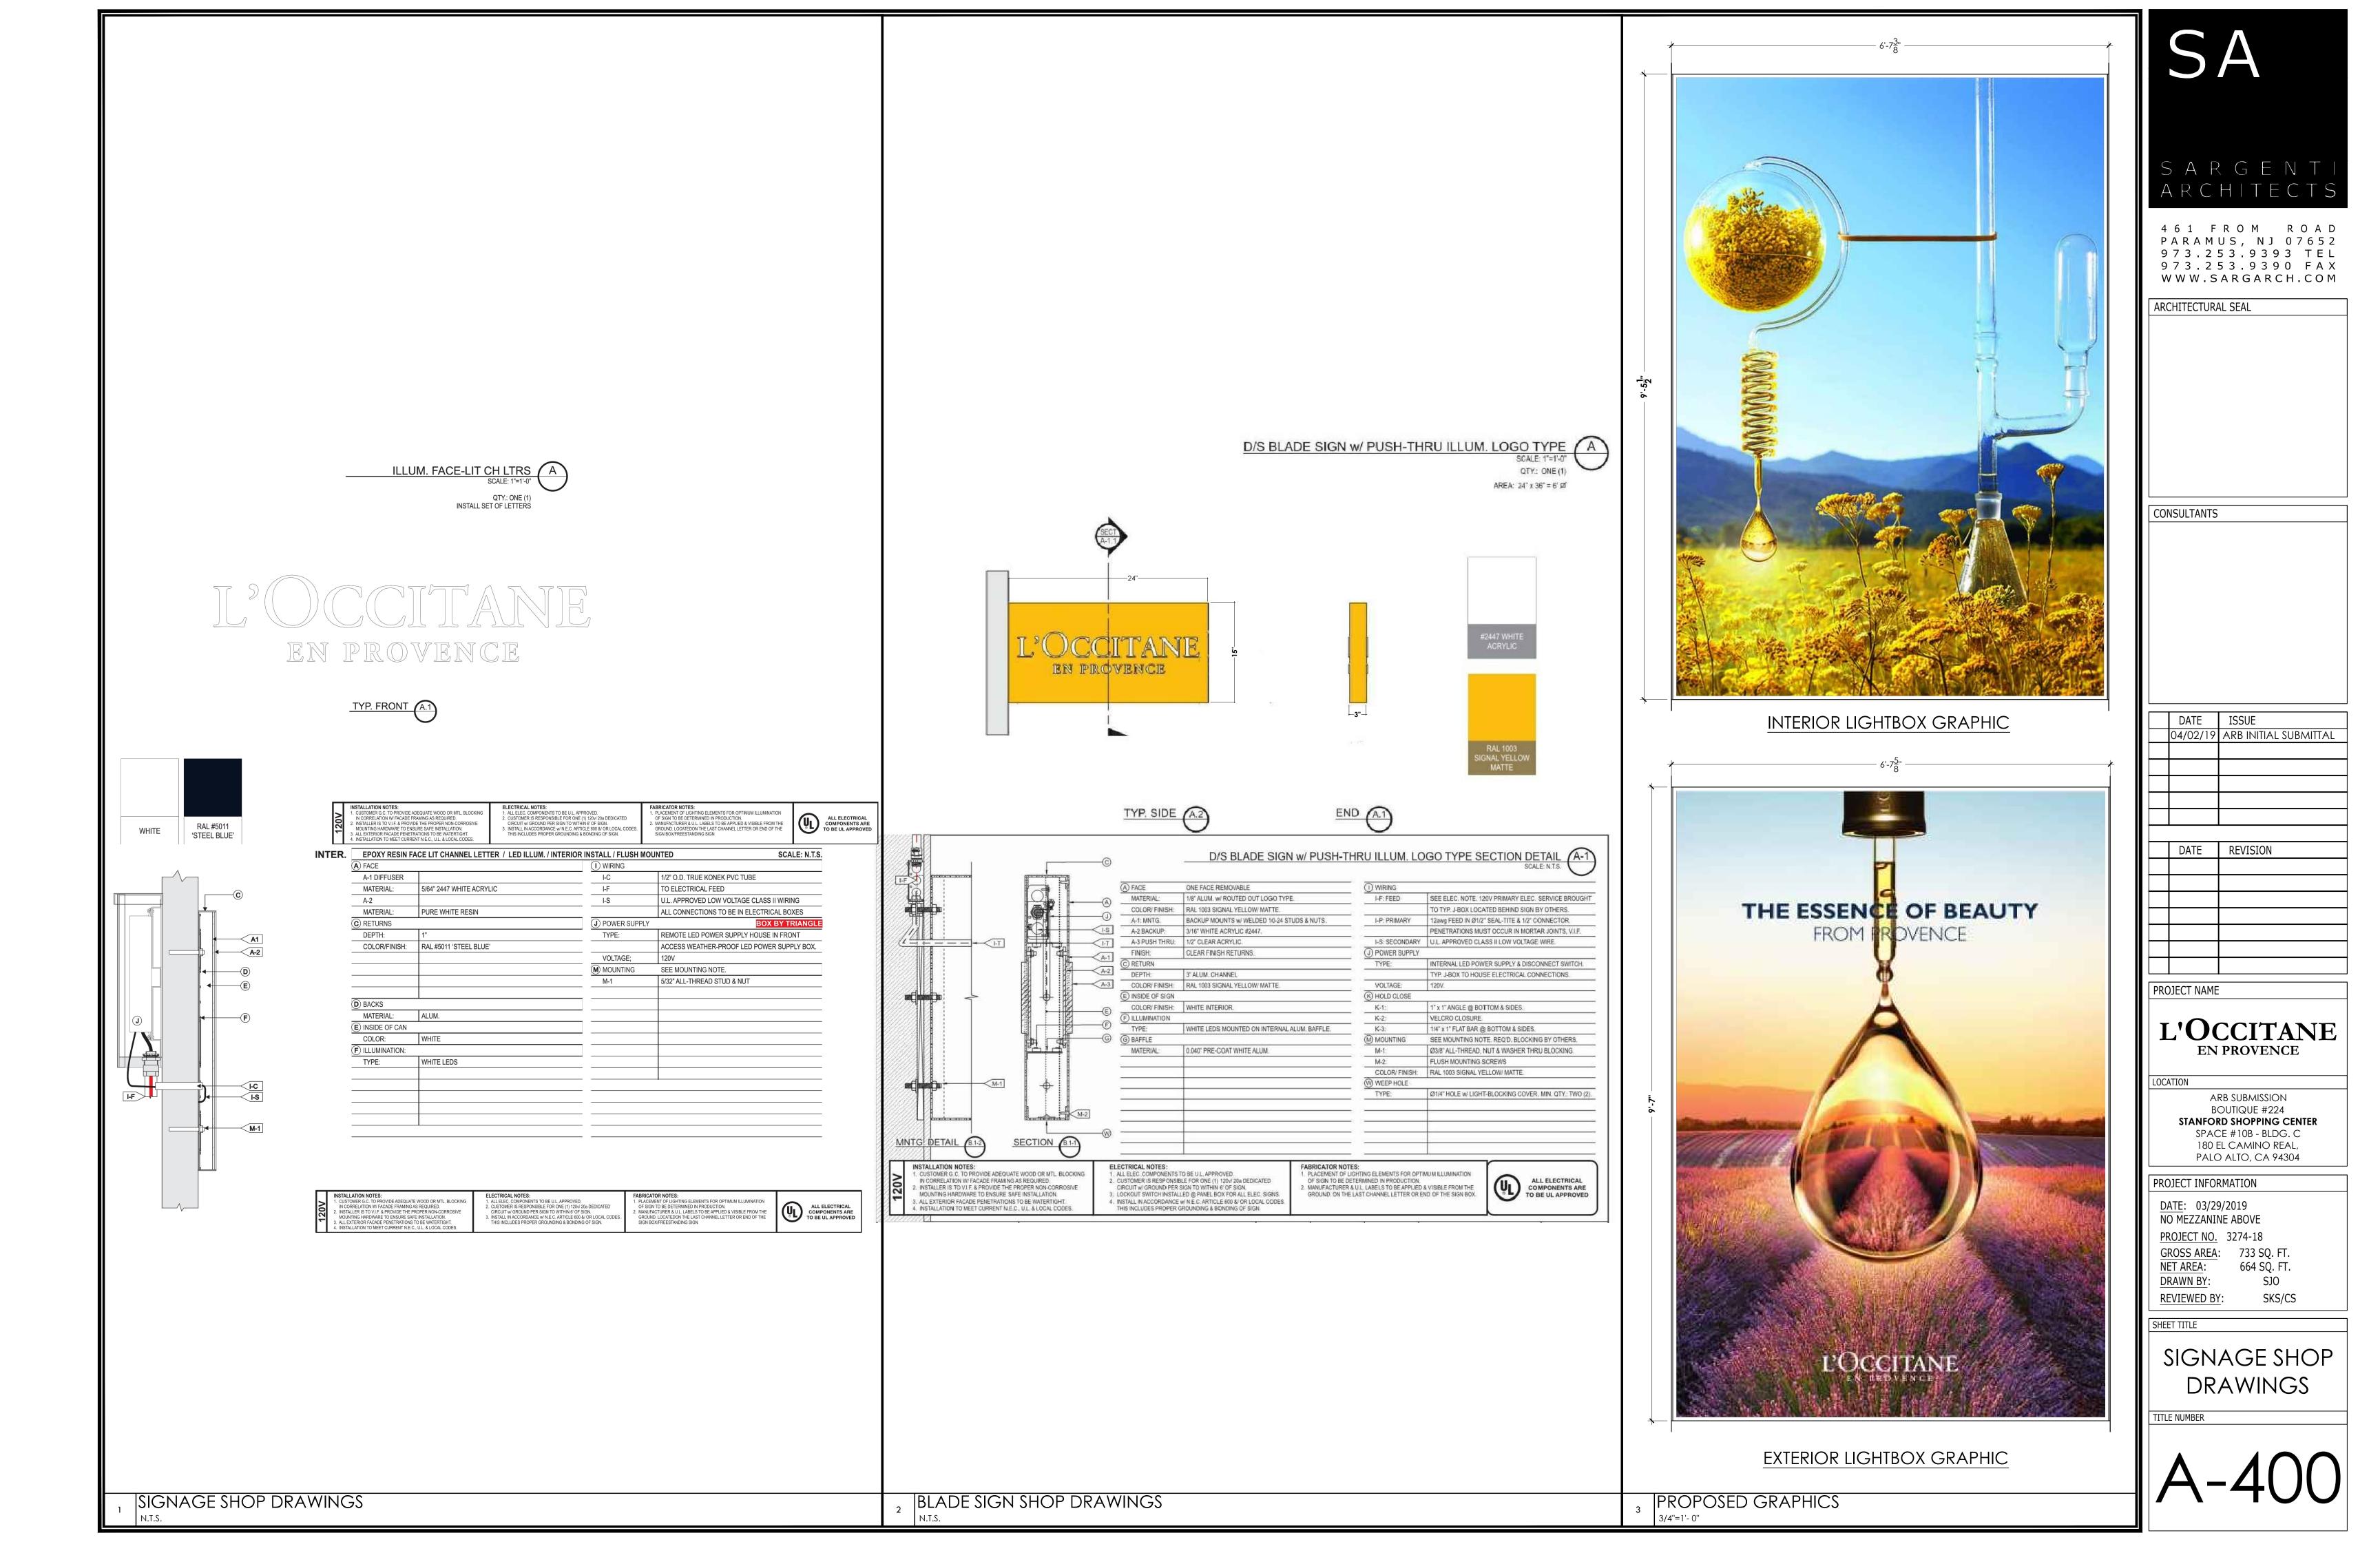

City of Palo Alto

Tree Protection - It's Part of the Plan!

Make sure your crews and subs do the job right!

Fenced enclosures around trees are essential to protect them by keeping the foliage canopy and branching structure clear from contact by equipment, materials and activities, preserving roots and soil conditions in an intact and non-compacted state, and identifying the Tree Protection Zone (TPZ) in which no soil disturbance is permitted and activities are restricted, unless otherwise approved. An approved tree protection report must be added to this sheet when project activity occurs within the TPZ of a regulated tree.

For detailed information on Palo Alto's regulated trees and protection during development, review the City Tree Technical Manual (TTM) found at www.cityofpaloalto.org/trees/.

TREE DISCLOSURE STATEMENT **CITY OF PALO ALTO** Planning Division, 250 Hamilton Avenue Palo Alto, CA 94301 (650) 329-2441 Palo Alto Municipal Code, Chapter 8.10.040, requires disclosure and protection of certain trees located on private and public property, and that they be shown on approved site plans. A completed disclosure statement must accompany all building permit applications that include exterior work, all demolition or grading permit applications, or other development activity. [Sections 1- 4 MUST be completed by the applicant. Please circle and/or check where applicable. 1. Where are the trees? Check those that apply. (Plans must be submitted showing over 4" diameter trees) ☐ On the property ☐ On adjacent property overhanging the project site ☐ In the City planter strip or right-of-way easement within 30' of property line (Street Trees)* *Street trees require special protection by a fenced enclosure, per the attached instructions. Prior to receiving any permit, you must provide an authorized Street Tree Protection Verification form by calling Public Works Operations at 493-5953 for inspection of required type I, II or III fencing (see attached Detail #605). 2. Are there any Protected or Designated Trees? YES (Check where applicable) NO ☐ Protected Tree (s) ☐ Designated Tree (s) ☐ On or overhanging the property 3. Is there activity or grading within the dripline? (radius 10 times the trunk diameter) of these trees?

If Yes, a Tree Preservation Report must be prepared by an ISA certified arborist and submitted for staff review (see TTM, Section 6.25).

**Protection of Regulated trees during development require the following: (1) Plans must show the measured trunk diameter and canopy

I, the undersigned, agree to the conditions of this disclosure. I understand that knowingly or negligently providing false or

misleading information in response to this disclosure requirement constitutes a violation of the Palo Alto Municipal Code Section

FOR STAFF USE:

Regulated Trees - a) Street trees - trees on public property; b) Protected trees - Coast Live Oaks or Valley Oaks which are 11.5" in diameter or larger, Coast

Redwoods which are 18" in diameter or larger, when measured 54" above natural grade; and Heritage trees are trees designated by City Council; and c)

Sections 5-6 must be completed by staff for the issuance of any development permit (demolition, grading or building permit).

5. <u>Protected Trees</u>. The specified tree fencing is in place. A <u>written statement is attached verifying that</u>

dripline; (2) Plans must denote, as a bold dashed line, a fenced enclosure area out to the dripline, per Sheet T-1 and Detail #605 -

Attach this report to Sheet T-1,: Tree Protection, its Part of the Plan!", per Site Plan Requirements.

http://www.cityofpaloalto.org/trees/forms.htm (See also TTM, Section 2.15 for area to be fenced)

protective fencing is correctly in place around protected and/or designated trees.

6. Street Trees. A signed Public Works Street Tree Protection Verification form is attached

Designated Trees – commercial or non-residential property trees, which are part of an approved landscape plan.

Palo Alto Tree Technical Manual (TTM) contains instructions for all requirements on this form, available at

4. Are the Site Plan Requirements** completed? YES


8.10.040, which can lead to criminal and/or civil legal action.


(Prop. Owner or Agent)

(N/A if there are no protected trees, check here \square)

S:Plan/Pladiv/Arborist/Tree Protection Info/Tree Disclosure Statemer

(N/A if there are no street trees, check here \square).

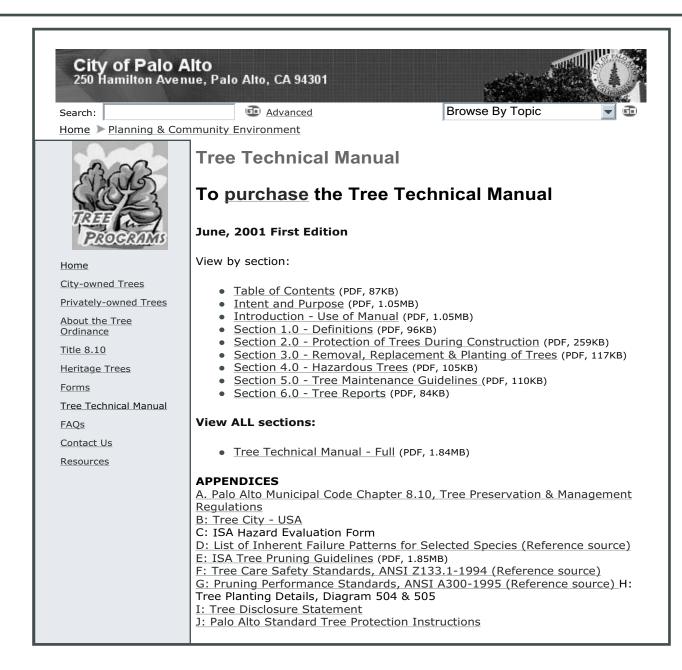

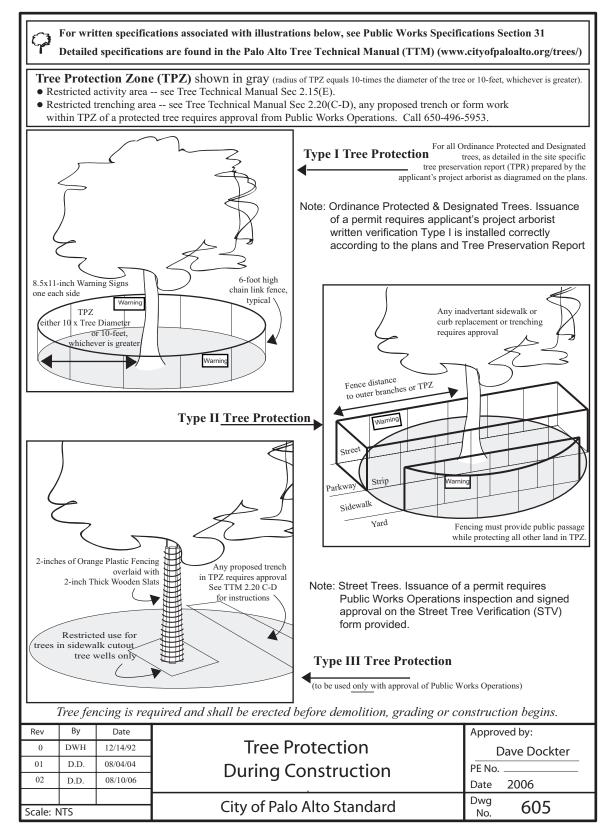

* 137	FORM	APPENDIX J PALO ALTO STREET TREE PROTECTION INSTRUCTIONSSECTION 31
1-1	Genera a.	Tree protection has three primary functions, 1) to keep the foliage canopy and branching structure clear from contact by equipment, materials and activities; 2) to preserve roots and soil conditions in an intact and non-compacted state and 3) to identify the Tree Protection Zone (TPZ) in which no soil disturbance is permitted and activities are restricted, unless otherwise approved.
	b.	The Tree Protection Zone (TPZ) is a restricted area around the base of the tree with a radius of ten-times the diameter of the tree's trunk or ten feet; whichever is greater, enclosed by fencing.
1-2	Referei	nce Documents
	a. b.	 Detail 605 – Illustration of situations described below. Tree Technical Manual (TTM) Forms (http://www.cityofpaloalto.org/trees/) Trenching Restriction Zones (TTM, Section 2.20(C)) Arborist Reporting Protocol (TTM, Section 6.30) Site Plan Requirements (TTM, Section 6.35) Tree Disclosure Statement (TTM, Appendix J) Street Tree Verification (STV) Form (http://www.cityofpaloalto.org/trees/forms)
l -3	Executi	lon.
1-3	a.	Type I Tree Protection: The fence shall enclose the entire TPZ of the tree(s) to be protected throughout the life of the construction project. In some parking areas, if fencing is located on paving or concrete that will not be demolished, then the posts may be supported by an appropriate grade level concrete base, if approved by Public Works Operations.
	b.	Type II Tree Protection: For trees situated within a planting strip, only the planting strip and yard side of the TPZ shall be enclosed with the required chain link protective fencing in order to keep the sidewalk and street open for public use.
	c.	Type III Tree Protection: To be used only with approval of Public Works Operations. Trees situated in a tree well or sidewalk planter pit, shall be wrapped with 2-inches of orange plastic fencing from the ground to the first branch and overlaid with 2-inch thick wooden slats bound securely (slats shall not be allowed to dig into the bark). During installation of the plastic fencing, caution shall be used to avoid damaging any branches. Major limbs may also require plastic fencing as directed by the City Arborist.
	d.	Size, type and area to be fenced. All trees to be preserved shall be protected with six (6') foot high chain link fences. Fences are to be mounted on two-inch diameter galvanized iron posts, driven into the ground to a depth of at least 2-feet at no more than 10-foot spacing. Fencing shall extend to the outer branching, unless specifically approved on the STV Form.
	e.	Warning' signs. A warning sign shall be weather proof and prominently displayed on each fence at 20-foot intervals. The sign shall be minimum 8.5-inches x 11-inches and clearly state in half inch tall letters: "WARNING - Tree Protection Zone - This fence shall not be removed and is subject to a fine according to PAMC Section 8.10.110."
	f.	Duration . Tree fencing shall be erected before demolition; grading or construction begins and remain in place until final inspection of the project, except for work specifically allowed in the TPZ. Work or soil disturbance in the TPZ requires approval by the project arborist or City Arborist (in the case of work around Street Trees). Excavations within the public right of way require a Street Work Permit from Public Works.
	g.	During construction
		 All neighbors' trees that overhang the project site shall be protected from impact of any kind. The applicant shall be responsible for the repair or replacement plus penalty of any publicly owned trees that are damaged during the course of construction, pursuant to Section 8.04.070 of the Palo Alto Municipal Code. The following tree preservation measures apply to all trees to be retained: a. No storage of material, topsoil, vehicles or equipment shall be permitted within the TPZ. b. The ground under and around the tree canopy area shall not be altered. c. Trees to be retained shall be irrigated, aerated and maintained as necessary to ensure survival.

	CONTRACTOR & ARBORIST INSPECTION SCHEDULE
	(S)
	Reference: the Palo Alto Tree Technical Manual is available at www.cityofpaloalto.org/environment/
ALL C	HECKED ITEMS APPLY TO THIS PROJECT:
1.	Inspection of Protective Tree Fencing. For Public Trees, the Street Tree Verification Form shall be signed by the City Arborist. For Protected Trees, the project site arborist shall provide an initial Monthly Tree Activity Report form with a photograph verifying that he has conducted a field inspection of the trees and that the correct type of protective fencing is in place around the designated tree protection zone (TPZ) prior to issuance of a demolition, grading, or building permit. (See TTM, Verification of Tree Protection, Section 1.39).
2. 🗹	Pre-Construction Meeting. Prior to commencement of construction, the applicant or contractor shall conduct a pre-construction meeting to discuss tree protection with the job site superintendent, grading operators, project site arborist, City Arborist, and, if a city maintained irrigation system is involved, the Parks Manager (Contact 650-496-6962).
3. 🗹	Inspection of Rough Grading or Trenching. Contractor shall ensure the project site arborist performs an inspection during the course of rough grading or trenching adjacent to or within the TPZ to ensure trees will not be injured by compaction, cut or fill, drainage and trenching, and if required, inspect aeration systems, tree wells, drains and special paving. The contractor shall provid the project arborist at least 24 hours advance notice of such activity.
4. 🗹	Monthly Tree Activity Report Inspections. The project site arborist shall perform a minimum monthly activity inspection to monitor and advise on conditions, tree health and retention or, immediately if there are <i>any revisions</i> to the approved plans or protection measures. The Tree Technical Manual Monthly Tree Activity Report format shall be used and sent to the Planning Dept landscape review staff no later than 14 days after issuance of building permit date. Fax to (650) 329-2154. (See TTM, Monthly Tree Activity Inspection Report, Addendum 11 & section 1.17).
5. 🗹	Special activity within the Tree Protection Zone. Work in the TPZ area (see also #7 below) requires the direct onsite supervision of the project arborist (see TTM, Trenching, Excavation & Equipment, Section 2.20 C).
6.	Landscape Architect Inspection. For discretionary development projects, prior to temporary or final occupancy the applicant or contractor shall arrange for the Landscape Architect to perform an on site inspection of all plant stock, quality of the materials and planting (see TTM, Planting Quality, Section 5.20.1 A) and that the irrigation is functioning consistent with the approved construction plans. The Planning Dept. landscape review staff shall be in receipt of written verification of Landscape Architect approval prior to scheduling the final inspection, unless otherwise approved.
7.	List Other (please describe as called out in the site Tree Preservation Report, Sheet T-1, T-2, etc.)
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F	City of Palo Alt Free Department Public Works Operations PO Box 10250 Palo Alto, CA 550/496-5953 FAX: 650/852- reeprotection@CityofPaloAlto	Verification of 94303 9289 o.org Street Tree Protection
		on of this form. Mail or FAX this form along with signed Tree Public Works Tree Staff will inspect and notify applicant.
APPLICATION DA	·	
ADDRESS/LOCA TREES TO BE PF	TION OF STREET ROTECTED:	
APPLICANT'S NA	AME:	
APPLICANT'S A	DDRESS:	
APPLICANT'S TE & FAX NUMBERS		
This section to be	filled out by City Tree State	ff
address(es) a		YES □ NO* □
protected. The used is:	e type of protection	* If NO, go to #2 below
Inspected by:		
Date of Inspect	ion:	
Indicate how t modifications to the applicar	were communicated	
Subsequent Inspe	ection	
Street trees at above address were found to be adequately protected:		YES NO* * If NO, indicate in "Notes" below the disposition of case.
Inpsected by:		
Date of Inspectio	n:	
site, condition and installed. Also not	treet trees by species, type of tree protection te if pictures were of sheet if necessary.	
Return approved	sheet to Applicant for d	emolition or building permit issuance.

N	Monthly Tree Ac	tivity Repo	rt- Construction	Site
Inspection Date:	Site address:	Contractor- Main Site Contact	#1: Job site superintend Company: Email:	
Inspection #	Palo Alto, CA	Information	Job site Office: Cell: Mail:	
		Also present:	:	
Distribution:	City of Palo Alto Others	Attn: Dave Dockter	Dave.dockter@cityofpalo 650-329-2440	alto.org
		-	visions may be needed ual tree number)	
2. Field Obser a. Tree l b. Trend 3. Action Item a. Tree l b. Root:	rvations (general site-wide Protection Fences (TPF) at hing has/will occur as (list site-wide, by tree n Protection Fence (TPF) ne zone buffer material (woo hule sewer trench, foundati	and list by individue umber and date to leds adjusting (tree ed chips) can be inst	ual tree number) be satisfied) and Date Due # x, x, x)	
2. Field Obser a. Tree I b. Trend 3. Action Item a. Tree I b. Root c. Sched 4. Photograph	rvations (general site-wide Protection Fences (TPF) at hing has/will occur as (list site-wide, by tree n Protection Fence (TPF) ne zone buffer material (woo hule sewer trench, foundati	and list by individue umber and date to leds adjusting (tree decine) can be instead on dig with	ual tree number) be satisfied) and Date Due # x, x, x)	
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2. Field Obser a. Tree I b. Trenc 3. Action Item a. Tree I b. Root: c. Sched 4. Photograph 5. Tree Locat: 6. Recommen • 7. Past visits (• Respectfully s	rvations (general site-wide Protection Fences (TPF) at hing has/will occur as (list site-wide, by tree in Protection Fence (TPF) ne zone buffer material (woodule sewer trench, foundations (use often) ion Map (mandatory 8.5 x dations, notes or monitor sites carry-over items satisfied	and list by individue umber and date to beds adjusting (tree dechips) can be instited with 11 sheet) items for project/stated/still outstanding	ual tree number) be satisfied) and Date Due # x, x, x) alled next aff/schedule	

---WARNING--Tree Protection Zone

This fencing shall not be removed without City Arborist approval (650-496-5953)

Removal without permission is subject to a \$500 fine per day*

*Palo Alto Municipal Code Section 8.10.110

 $City \ of \ Palo \ Alto \ Tree \ Protection \ Instructions \ are \ located \ at \ \underline{http://www.city.palo-alto.ca.us/trees/technical-manual.html}$

SPECIAL INSPECTIONS	PLANNING DEPARTMENT				
TREE PROTECTION INSPECTIONS MANDATORY					
PAMC 8.10 PROTECTED TREES. CONTRACTOR SHA REQUIRED TREE INSPECTION AND SITE MONITORIN REPORTS TO THE PLANNING DEPARTMENT LANDSO BUILDING PERMIT ISSUANCE.					
BUILDING PERMIT DATE:					
DATE OF 1 ST TREE ACTIVITY REPORTS	:				
CITY STAFF:					
VERIFY THAT ALL TREE PROTECTION MEASURES A ACTIVITY, SCHEDULED OR UNSCHEDULED, WITHIN	VITY REPORT SHALL CONFORM TO SHEET T-1 FORMAT RE IMPLIMENTED AND WILL INCLUDE ALL CONTRACTOF N A TREE PROTECTION ROOT ZONE. NON-COMPLIANCE REFERENCE: PALO ALTO TREE TECHNICAL MANUAL				

Apply Tree Protection Report on sheet(s) T-2

Use addtional "T" sheets as needed

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All other tree-related reports shall be added to the space provided on this sheet (adding as needed) Include this sheet(s) on Project Sheet Index or Legend Page.

A copy of TR-100 can be downloaded at

http://www.cityofpaloalto.org/civica/filebank/blobdload.asp?BlobID=6460

Special Tree Protection Instruction Sheet City of Palo Alto











4 6 1 F R O M R O A D P A R A M U S , N J 0 7 6 5 2 9 7 3 . 2 5 3 . 9 3 9 3 T E L 9 7 3 . 2 5 3 . 9 3 9 0 F A X W W W . S A R G A R C H . C O M

ARCHITECTURAL SEAL

CONSULTANTS

DATE ISSUE
04/02/19 ARB INITIAL SUBMITTAL

DATE REVISION

PROJECT NAME

L'OCCITANE EN PROVENCE

LOCATION

ARB SUBMISSION
BOUTIQUE #224

STANFORD SHOPPING CENTER
SPACE #10B - BLDG. C
180 EL CAMINO REAL,
PALO ALTO, CA 94304

PROJECT INFORMATION

DATE: 03/29/2019
NO MEZZANINE ABOVE
PROJECT NO. 3274-18
GROSS AREA: 733 SQ. FT.
NET AREA: 664 SQ. FT.

NET AREA: DRAWN BY:

SHEET TITLE

REVIEWED BY:

BY: SKS/CS

SJ0

MATERIAL

SAMPLE BOARD

TITLE NUMBER

SMP-100